

GENERAL NOTES

- ALL CONTRACTORS AND SUBCONTRACTORS WILL THOROUGHLY FAMILIARIZE THEMSELVES WITH THESE CONSTRUCTION DOCUMENTS AND WILL VERIFY EXISTING SITE AND CONDITIONS PRIOR TO SUBMITTING A BID. ALL SUBCONTRACTORS WILL PROVIDE ALL LABOR, SUPERVISION, AND MATERIALS OF EVERY TYPE WHICH MAY BE NECESSARY FOR A SUCCESSFUL COMPLETION. ALL WORK TO BE PERFORMED IN A GOOD AND WORKMANLIKE MANNER ACCORDING TO THE TRUE INTENT AND MEANING OF THE DRAWINGS AND
- THIS ARCHITECT AND HIS PROFESSIONAL CONSULTANTS WILL NOT HAVE CONTROL. OF AND WILL NOT BE RESPONSIBLE FOR. CONSTRUCTION MEANS, METHODS, TECHNIQUES, SEQUENCES, PROCEDURES, OR SAFETY PRECAUTIONS AND PROGRAMS IN CONNECTION WITH THE WORK ON THIS PROJECT OR FOR THE ACTS OR OMISSIONS OF THE CONTRACTOR, SUBCONTRACTOR, OR ANY OTHER PERSONS PERFORMING ANY OF THE WORK ON THIS SITE, NOR FOR THE FAILURE OF ANY OF THEM TO CARRY OUT THE WORK IN ACCORDANCE WITH THE INTENT OF THE CONTRACT AND OR CONSTRUCTION DOCUMENTS.
- ALL CONTRACTORS WILL PROVIDE ADEQUATE BRACING AND/OR SHORING TO INSURE STRUCTURAL STABILITY OF THE BUILDING AND ALL RELATED BUILDING COMPONENTS IE: STRUCTURAL WALLS, INTERIOR WALL ASSEMBLIES, ETC. DURING THE CONSTRUCTION PHASE OF THIS PROJECT.
- WORK WILL BE COORDINATED WITH ALL TRADES IN ORDER TO AVOID INTERFERENCE, AND AVOID OMISSIONS.
- ALL MATERIALS USED WILL BE NEW AND BEAR U.L. LABELS WHERE REQUIRED AND MEET APPROPRIATE N.E.M.A. STANDARDS.
- LAYOUT ALL PARTITIONS BEFORE BEGINNING CONSTRUCTION TO PREVENT ERRORS BY DISCREPANCY. ALL DRYWALL PARTITIONS WILL BE INSTALLED AS NOTED ON THE DRAWINGS.
- EACH SUBCONTRACTOR WILL AMEND AND MAKE GOOD AT HIS OWN COST, ANY DEFECTS OR OTHER FAULTS IN HIS WORKMANSHIP AND/OR
- ALL CONTRACTORS WILL GUARANTEE ALL LABOR AND MATERIALS FOR A PERIOD OF ONE YEAR FROM DATE OF OCCUPANCY.
- VERIFY ALL DIMENSIONS IN THE FIELD PRIOR TO ORDERING, CUTTING AND/OR INSTALLING MATERIAL, PRODUCT OR EQUIPMENT. IN THE EVENT OF ANY DISCREPANCIES, CONTACT THE CONSTRUCTION MANAGER OR OWNER BEFORE PROCEEDING WITH THAT WORK.
- ALL SUBCONTRACTORS WILL PROVIDE A CERTIFICATE OF INSURANCE TO THE GENERAL CONTRACTOR PRIOR TO STARTING ANY WORK ON THIS PROJECT. CERTIFICATE OF INSURANCE CANNOT BE TERMINATED OR CANCELED WITHOUT 10 DAYS PRIOR WRITTEN NOTICE TO THE
- ANY ADDITIONS OR CHANGES TO WORK MUST BE AUTHORIZED IN WRITING BY THE CONSTRUCTION MANAGER OR OWNER. NO ALTERATIONS WILL BE MADE ON THIS PROJECT EXCEPT UPON WRITTEN ORDER BY THE CONSTRUCTION MANAGER.
- NO SUBSTITUTIONS OF ANY KIND FOR MATERIALS SPECIFIED ON THESE CONSTRUCTION DOCUMENTS IS ALLOWED. NO "EQUIVALENT" SUBSTITUTIONS WILL BE MADE. UNLESS DUE TO THE LACK OF AVAILABILITY OF THE ORIGINAL MATERIAL SPECIFIED AND APPROVED
- WEATHER CONDITIONS: CONTRACTORS WILL PROTECT ALL PARTS OF THEIR WORK FROM WEATHER DAMAGE DUE TO FROST, RAIN, HEAT, ETC. AND WILL MAKE GOOD TO THE SATISFACTION OF THE CONSTRUCTION MANAGER AND/OR GENERAL CONTRACTOR ANY PORTION OF THE WORK WHICH MAY HAVE BECOME DAMAGED.
- 14. RESPONSIBILITY OF CONTRACTOR: EACH SUBCONTRACTOR IS RESPONSIBLE FOR WORKMANSHIP AND MATERIALS. EACH SUBCONTRACTOR IS RESPONSIBLE FOR THE CARE AND PROTECTION OF HIS OWN WORK AND MATERIALS.
- SITE SAFETY: EACH CONTRACTOR WILL ABIDE BY LOCAL AREA STANDARDS AND RELATED OSHA STANDARDS FOR THE PROTECTION AND SAFETY FOR THEIR EMPLOYEES ON SITE. THIS ARCHITECT AND HIS PROFESSIONAL CONSULTANTS WILL BE HELD HARMLESS BY THE OWNER, GENERAL CONTRACTOR AND RELATED AWARDED TRADES ON THIS PROJECT FOR ACCIDENTS OR INJURIES CAUSED OR ACCRUED ON THIS PROPERTY DURING THE PRE/ACTUAL/POST CONSTRUCTION PHASES OF THIS PROJECT.
- PILFERAGE: EACH CONTRACTOR WILL BE RESPONSIBLE FOR HIS OWN EQUIPMENT AND MATERIALS USED IN CONSTRUCTION INCLUDING THOSE ITEMS. FURNISHED BY THE OWNER. AND DELIVERED TO THE JOB SITE. TO BE INSTALLED BY THE CONTRACTOR. THE OWNER WILL NOT BE HELD LIABLE FOR STOLEN EQUIPMENT, MATERIALS OR DAMAGE OF THE SAME ON THIS JOB SITE.
- 17. LIENS: ALL SUBCONTRACTORS AND THE GENERAL CONTRACTOR WILL DELIVER TO THE OWNER, A COMPLETE RELEASE OF ALL CLAIMS ARISING OUT OF THIS CONTRACT.
- GENERAL CONTRACTOR WILL BE RESPONSIBLE FOR REMOVAL OF DEBRIS ACCUMULATED BY EACH TRADE. HOWEVER, EACH TRADE WILL KEEP THE JOB SITE CLEAN AND SAFE AT ALL TIMES, ALONG WITH A BROOM FINISH AT THE END OF EACH WORKING DAY.
- SCHEDULE OF WORK: THE OWNER CONSTRUCTION MANAGER WILL COORDINATE WITH THE GENERAL CONTRACTOR DURING THE BIDDING PROCESS, THE REQUIRED NUMBER OF CALENDAR DAYS TO COMPLETE

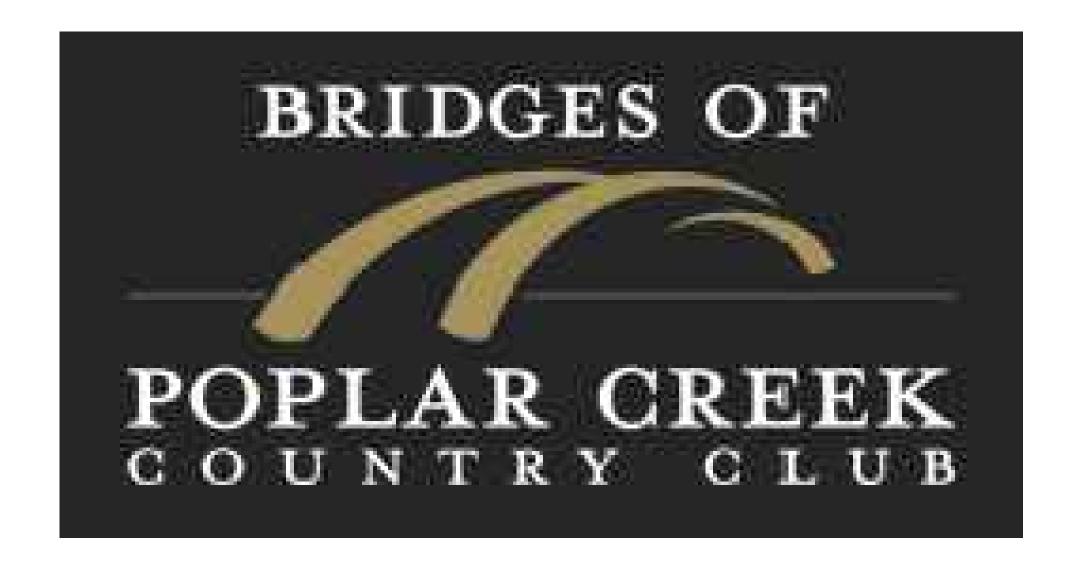

BRIDGES TOP TRACER **BATHROOM UTILITIES**

1400 POPLAR CREEK DRIVE HOFFMAN ESTATES, IL 60169

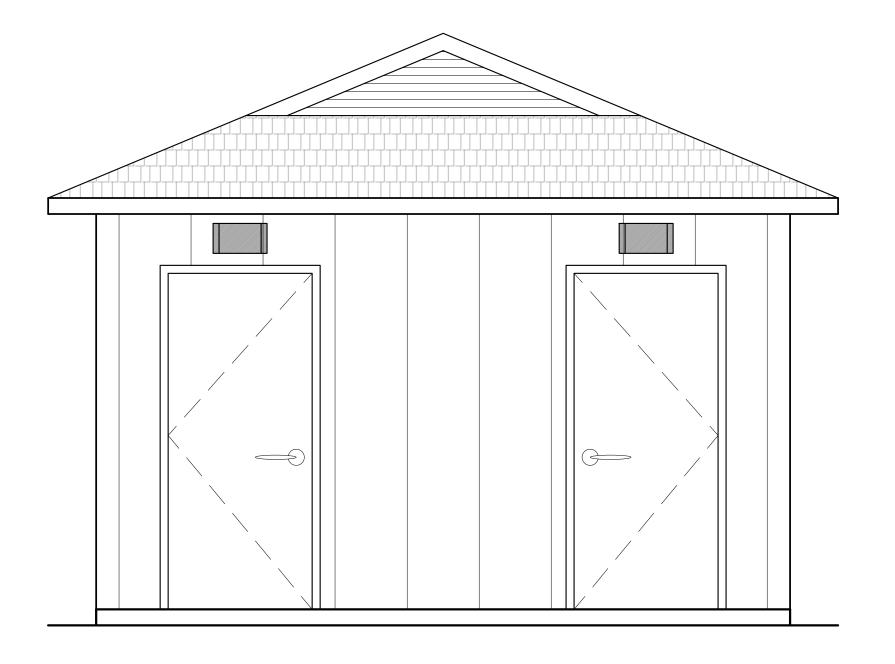

PROJECT DIRECTORY

BRIDGES OF POPLAR CREEK ATTN: DUSTIN HUGEN 1400 POPLAR CREEK DRIVE HOFFMAN ESTATES, IL 60169 847.285.5465

ATTN: CHRISTIAN KALISCHEFSKI 2675 PRATUM AVENUE HOFFMAN ESTATES, IL 60192 224.293.6333


CIVIL ENGINEER

ATTN: TODD ABRAMS 2675 PRATUM AVENUE HOFFMAN ESTATES, IL 60192 224.293.6333

MECHANICAL, ELECTRICAL, AND PLUMBING ENGINEER

WT GROUP ATTN: MARK VENTRELL 2675 PRATUM AVENUE HOFFMAN ESTATES, IL 60192 224.293.6333

LOCATION MAP

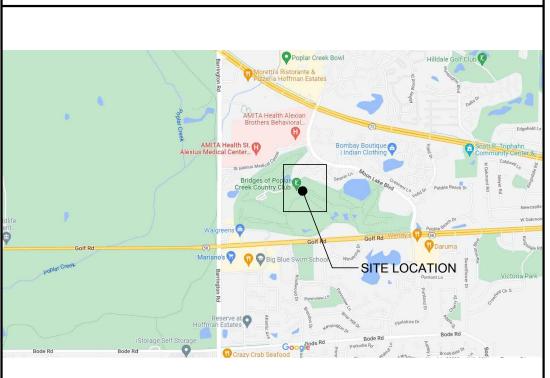

GENERAL BUILDING INFORMATION

HOFFMAN ESTATES ADOPTED CODES INTERNATIONAL BUILDING CODE INTERNATIONAL FIRE CODE INTERNATIONAL MECHANICAL CODE

NATIONAL ELECTRICAL CODE CURRENT ILLINOIS STATE PLUMBING CODE ILLINOIS ACCESSIBILITY CODE CURRENT ILLINOIS ENERGY CONSERVATION CODE INTERNATIONAL FUEL GAS CODE

CURRENT HOFFMAN ESTATES ZONING ORDINANCE

BUILDING DATA

ZONING CLASSIFICATION: RPD - RESIDENTIAL PLANNED DEVELOPMENT DISTRICT OCCUPANCY: U - UTILITY CONSTRUCTION TYPE:

NUMBER OF STORIES:

BUILDING AREA: 185 SQ.FT.


STATEMENT OF COMPLIANCE

I, CHRISTIAN KALISCHEFSKI, A.I.A., DULY LICENSED IN THE STATE OF ILLINOIS BY THE DEPARTMENT OF PROFESSIONAL REGULATION, DO HEREBY STATE THAT THIS DOCUMENT WAS PREPARED BY ME OR UNDER MY DIRECT SUPERVISION AND TO THE BEST OF MY KNOWLEDGE AND BELIEF DOES CONFORM TO THE APPLICABLE BUILDING CODES AND ORDINANCES, AND ARE IN COMPLIANCE WITH THE ENVIRONMENTAL BARRIERS ACT [410 ILLS 25] AND THE ILLINOIS ACCESSIBILITY CODE (71

CHRISTIAN

KALISCHEFSKI

12930

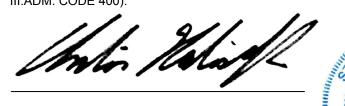

DATE: 03/01/2022

CHRISTIAN KALISCHEFSKI ILLINOIS REGISTRATION NUMBER: 001-012930 DATE OF EXPIRATION: NOVEMBER 30, 2022

SCOPE OF WORK

DRAWING INDEX

ACCESSIBILITY INFORMATION

SCHEDULES AND DETAILS

PLUMBING PLAN AND DETAILS

CIVIL DRAWINGS ARE UNDER SEPARATE DRAWING SET.

MECHANICAL PLAN AND SCHEDULES

RISER DIAGRAMS AND PANEL SCHEDULES

ELECTRICAL SPECIFICATIONS SYMBOLS AND NOTES

EXTERIOR ELEVATIONS AND WALL SECTIONS

COVER SHEET

GENERAL


<u>PLUMBING</u>

<u>MECHANICAL</u>

ELECTRICAL

THIS IS A NEW RESTROOM BUILDING CONTAINING ONE ACCESSIBLE SINGLE USER RESTROOM, ONE SINGLE USER RESTROOM AND A UTILITY ROOM.



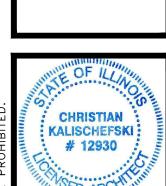

03.01.2022 BI

COVER SHEET

TYPICAL ACCESSORY MOUNTING HEIGHTS


SIGN MUST INCLUDE: GRADE 2 BRAILLE, MINIMUM 6" X 6" PICTOGRAM, AND 5/8" HIGH TEXT RAISED 1/32". THE CHARACTERS AND BACKGROUND OF SIGNS SHALL BE EGGSHELL, MATTE, OR OTHER NON-GLARE FINISH. CHARACTERS AND SYMBOLS SHALL CONTRAST WITH THEIR BACKGROUND. CHARACTERS MUST BE UPPERCASE AND SANS SERIF OR "SIMPLE SERIF" TYPE STYLE.

ACCESSIBLE SIGNAGE FINISH, CHARACTERS, SYMBOLS AND BRAILLE MUST MEET THE REQUIREMENTS OF THE 2018 ILLINOIS ACCESSIBILITY CODE. SIGN MUST INCLUDE THE INTERNATIONAL SYMBOL OF ACCESSIBILITY.

RESTROOM SIGNAGE SHALL BE MOUNTED ON THE WALL ADJACENT TO THE LATCH SIDE OF THE DOOR. MOUNTING HEIGHT SHALL BE PER THE DIAGRAM ON THIS SHEET. MOUNTING LOCATION FOR THE SIGNAGE MUST BE SO THAT A PERSON MAY APPROACH WITHIN AN 18"x18" AREA, CENTERED ON THE SIGNAGE, WITHOUT ENCOUNTERING PROTRUDING OBJECTS OR DOOR SWINGS.

PER THE ILLINOIS EQUITABLE RESTROOM ACT, SIGNAGE TO BE GENDER NEUTRAL.

2 ACCESSIBLE SIGNAGE
SCALE: N.T.S.

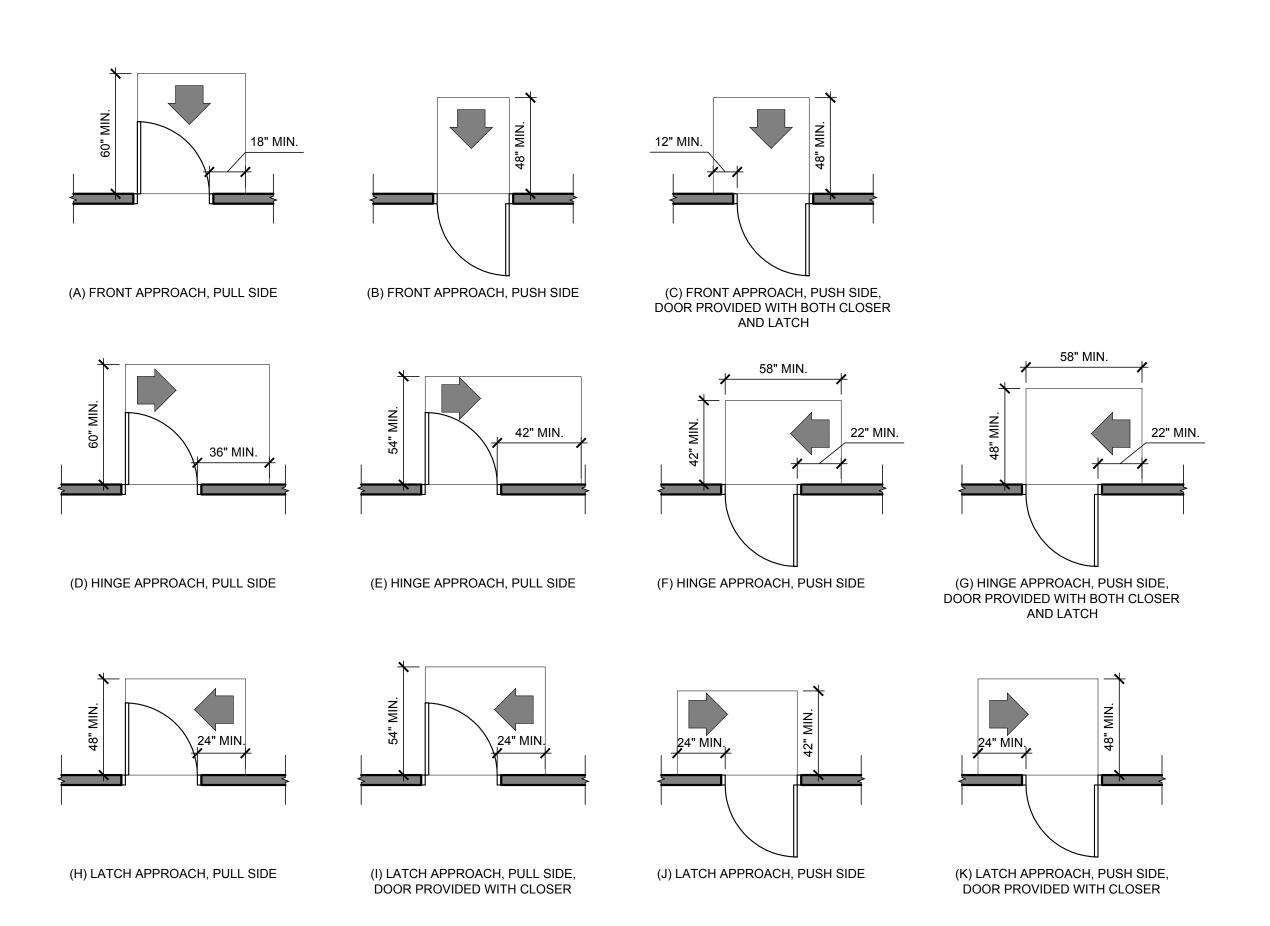


ACCESSIBLE DOOR CLEARANCES

date: 03.01.2022 BID

KALISCHEFSKI

gned: 03/01/2022 Expires: 11/30/20

ACCESSIBILITY INFORMATION

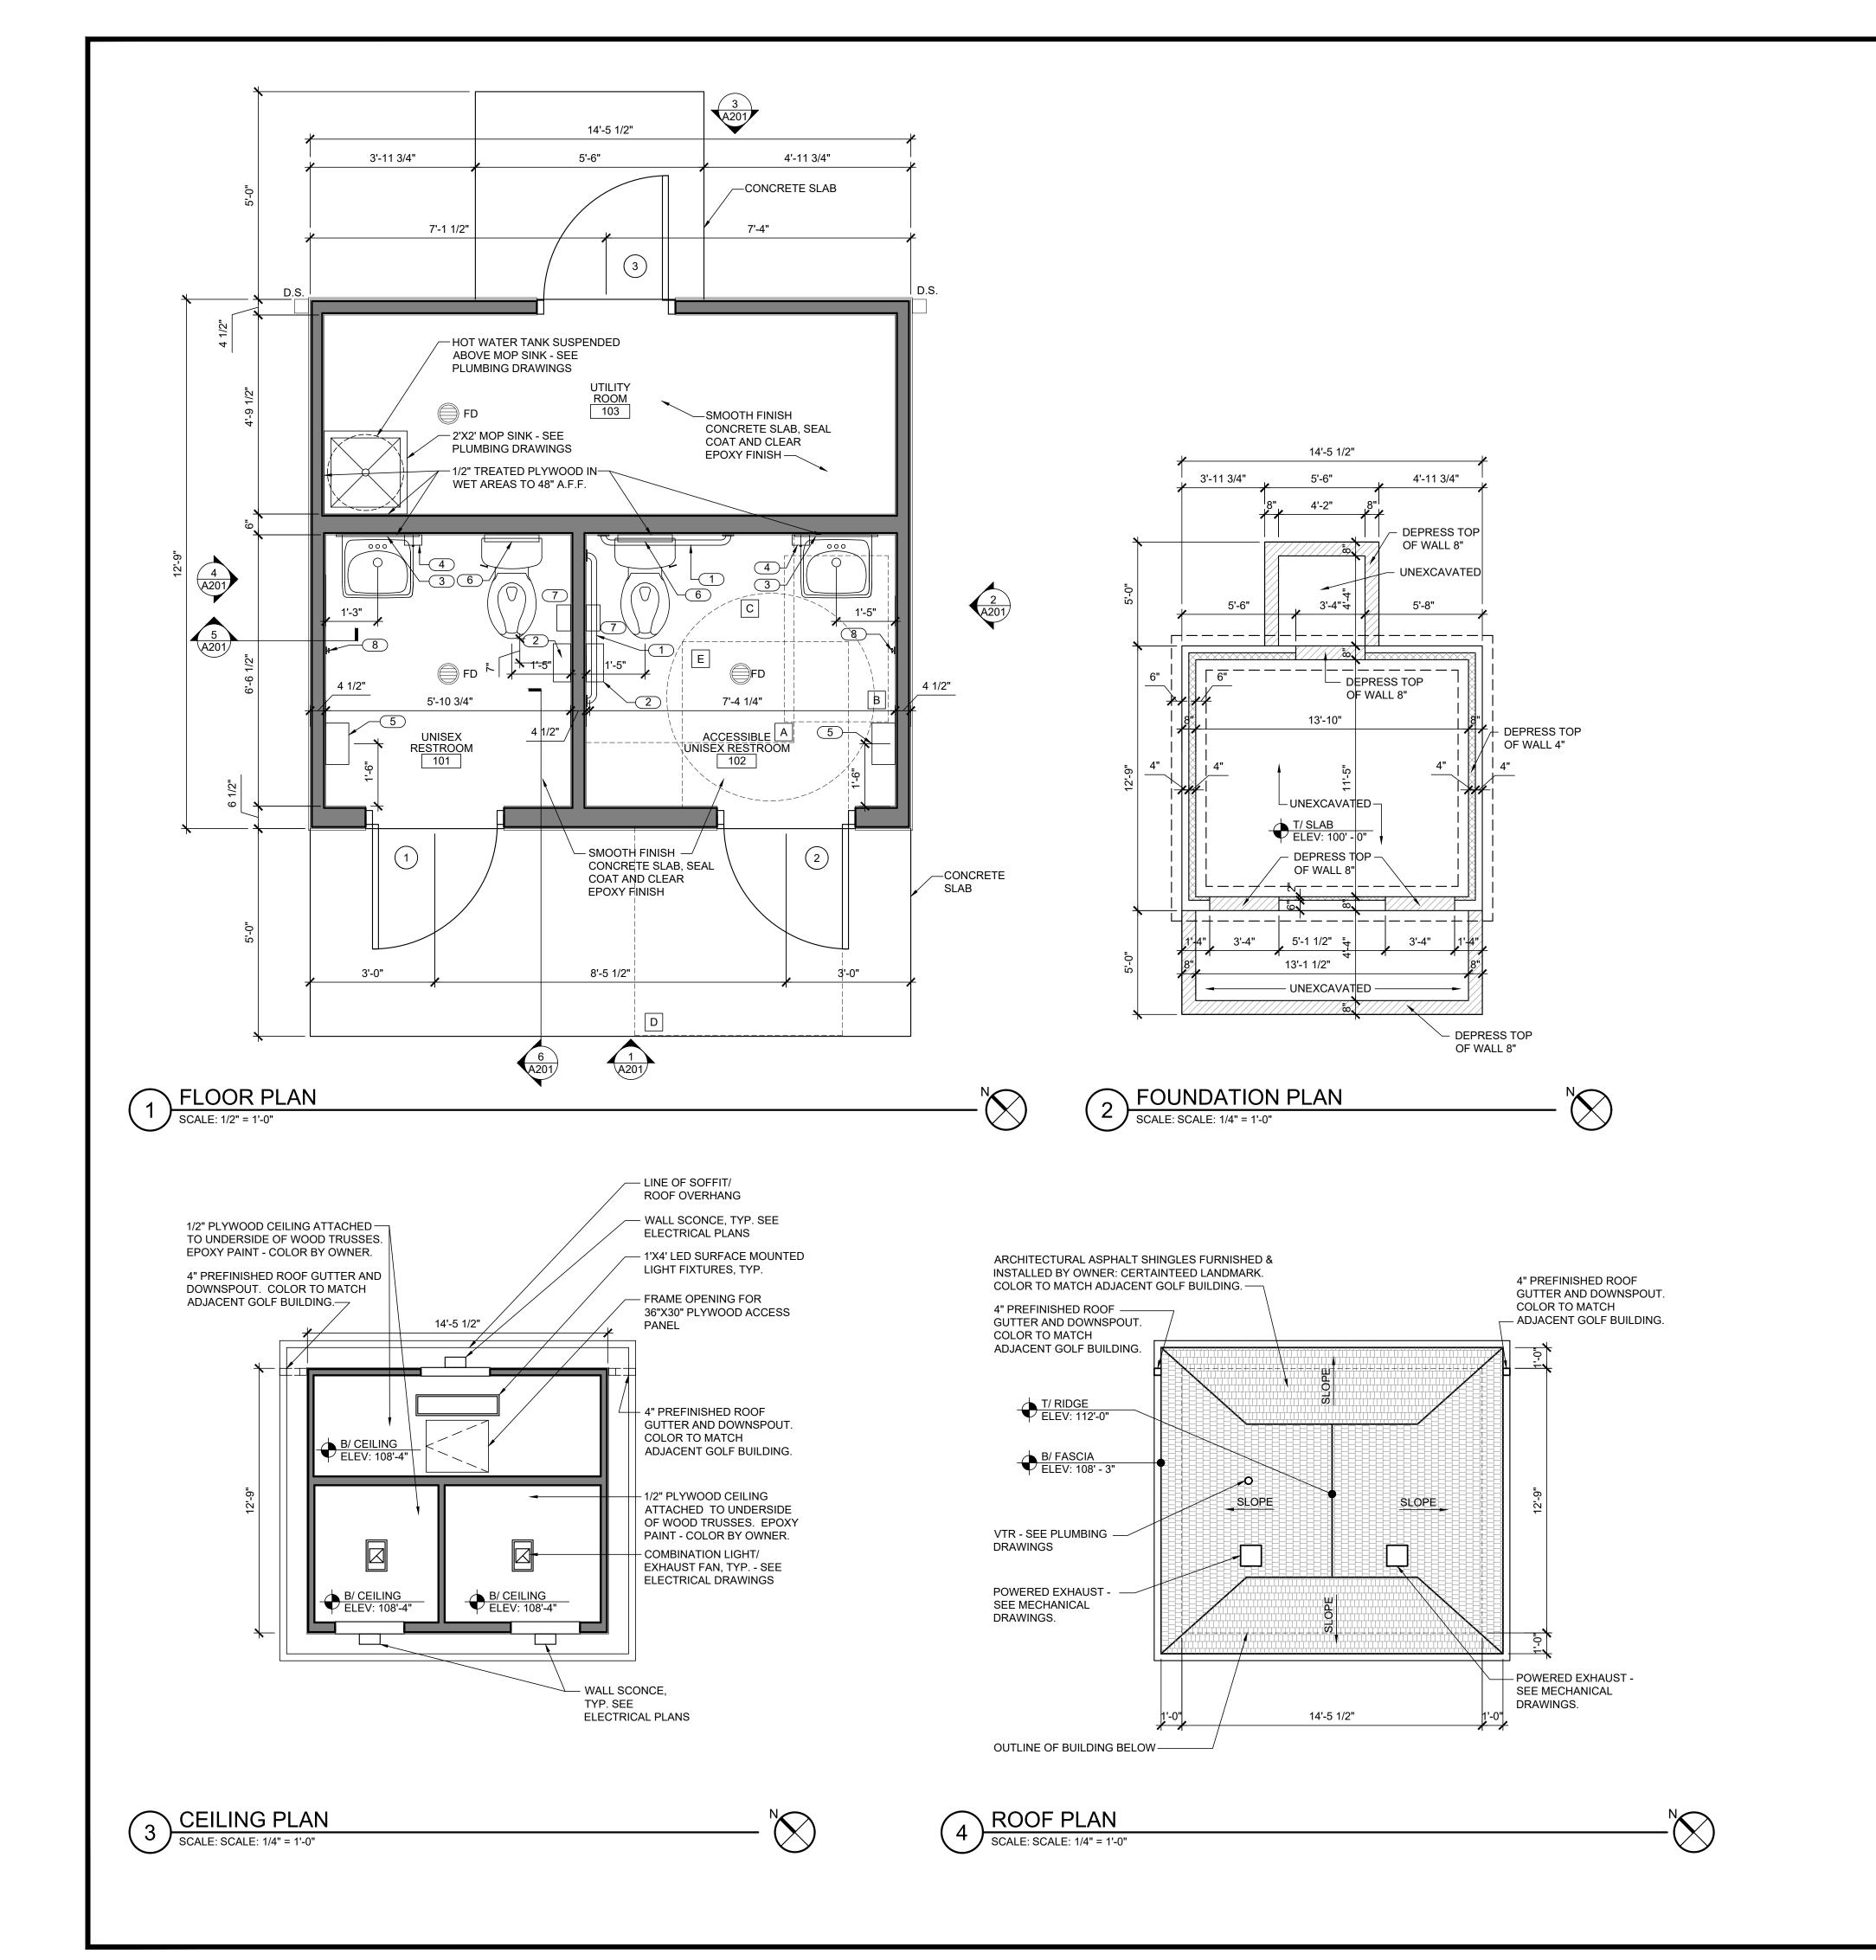

PLAN GENERAL NOTES

- A. ALL CONTRACTORS TO VERIFY EXISTING SITE CONDITIONS AND DIMENSIONS BEFORE ANY WORK IS TO BEGIN. NOTIFY ARCHITECT OF DISCREPANCIES.
- B. ALL WORK TO BE DONE IN ACCORDANCE WITH ALL GOVERNING STATE AND LOCAL CODES, ORDINANCES, AND AMENDMENTS.
- C. PROVIDE ALL REQUIRED IN WALL BLOCKING FOR ALL WALL MOUNTED EQUIPMENT, MILLWORK, SHELVING, AND ACCESSORIES.
- D. MOUNT ALL FIXTURES & ACCESSORIES AT HEIGHTS CONFORMING
- WITH ALL GOVERNING CODES & ACCESSIBILTY REQUIREMENTS.


 E. FIRE EXTINGUISHERS ARE SUPPLIED AND INSTALLED BY THE G.C.

QUANTITIES AND LOCATIONS TO BE COORDINATED W/ THE LOCAL

- F. ALL DIMENSIONS ARE NOMINAL & ARE FROM FACE OF GYPSUM BOARD, SHEATHING, OR SUBSTRATE UNLESS NOTED OTHERWISE.
- G. PROVIDE CONTINUOUS BEAD OF CLEAR SILICONE SEALANT AT INTERIOR SIDE OF ALL WALL TRANSITIONS. SEAL ALL NEW AND EXISTING OPENINGS IN FLOORS, STRUCTURAL DECK AND EXTERIOR WALLS IN ORDER TO PROVIDE A WEATHER TIGHT SEAL.
- H. ALL WALLS ARE AT 90° UNLESS NOTED OTHERWISE.

FIRE DEPARTMENT.

- I. PROPERLY PREPARE & CLEAN SUBSTRATES & SURFACES AS REQUIRED TO ACCEPT FINISHES, MATERIALS, TREATMENTS, ETC.
- J. G.C. SHALL PROVIDE FINAL CLEANING AT END OF CONSTRUCTION.
- K. SEE ELECTRICAL DRAWINGS FOR LIGHTING SCHEDULE AND SPECIFICATIONS.
- L. COORDINATE LOCATION OF LIGHT FIXTURES AND POWER SUPPLY WITH ELECTRICAL DRAWINGS.
- M. CONTRACTOR TO SUBMIT LIGHTING CUTS TO OWNER FOR APPROVAL PRIOR TO ORDERING. CONTRACTOR SHALL VERIFY LIGHTING CATALOG NUMBER WITH ELECTRICAL DRAWINGS AND NOTIFY THE OWNER OF ANY DISCREPANCIES.
- N. GENERAL CONTRACTOR TO COORDINATE LIGHT FIXTURE CLEARANCE REQUIREMENTS WITH ABOVE CEILING UTILITIES, I.E. PLUMBING, CONDUIT & DUCTWORK, BEFORE COMMENCING WORK.
- O. ELECTRICAL CONTRACTOR TO VERIFY ALL LOCATIONS OF WALL MOUNTED OUTLETS, J-BOXES, AND ITEMS PROVIDED BY THE OWNER, SEE ELECTRICAL DRAWINGS.

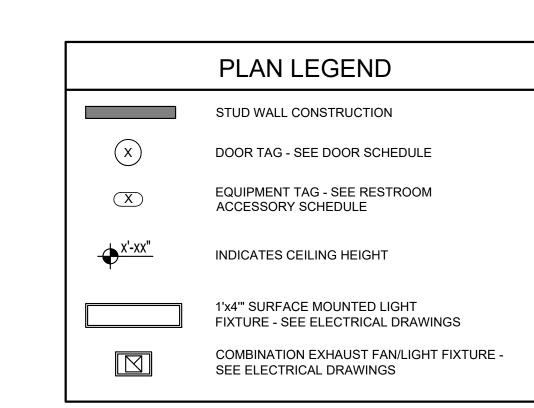

	- CLEAR FL	OOR SPACE
TAG	ITEM	SPACE REQUIRED
Α	TOILET	60" X 60"
В	SINK	30" X 48"
С	TURNING SPACE	60" DIAMETER
D	PULL SIDE OF 3'-0" DOOR FRONT APPROACH	60" X 60"
E	PUSH SIDE OF 3'-0" DOOR LATCH APPROACH	48" X 48"

ROOF GENERAL NOTES

- A. PROVIDE A COMPLETE AND WATER TIGHT ROOFING SYSTEM THAT MAINTAINS THE ROOF SYSTEM MANUFACTURER'S WARRANTY.
- B. PROCEED WITH WORK ONLY WHEN WEATHER CONDITIONS PERMIT WORK TO PROCEED WITH OUT WATER ENTERING THE ROOFING SYSTEM.
- PROTECT ALL MATERIAL FROM SATURATION OF WATER PRIOR TO FINAL INSTALLATION OF ROOF MEMBRANE.
- D. ALL WOOD BLOCKING TO BE PRESSURE TREATED P.T.
- E. ALL METAL FASTENERS TO BE CORROSION RESISTANT.
- ALL NEWLY INSTALLED FLASHING MATERIALS TO BE COMPATIBLE
- WITH ONE ANOTHER CAUSING NO DELETERIOUS EFFECTS.
- G. CONTRACTOR TO ENSURE ALL ROOFING SYSTEMS MEET MANUFACTURER'S REQUIREMENTS FOR TOTAL SYSTEM WARRANTIES. THE WARRANTY PERIOD SHOULD MEET 25 YEARS.

ARCHITE

T5 PRATUM AVENUE

FFMAN ESTATES, IL 60/92

FICE: 312:505:392




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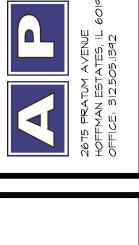
THE ORIGINAL SITE OR PURPOSE FOR WHICH THEY WERE PREPARED. REPRODUCTIC

ES TOP TRACER BATHROO POPLAR CREEK DRIVE

project no. C22000000 date: O3.01.2022 BID revision 1: revision 2: revision 3: revision 4:





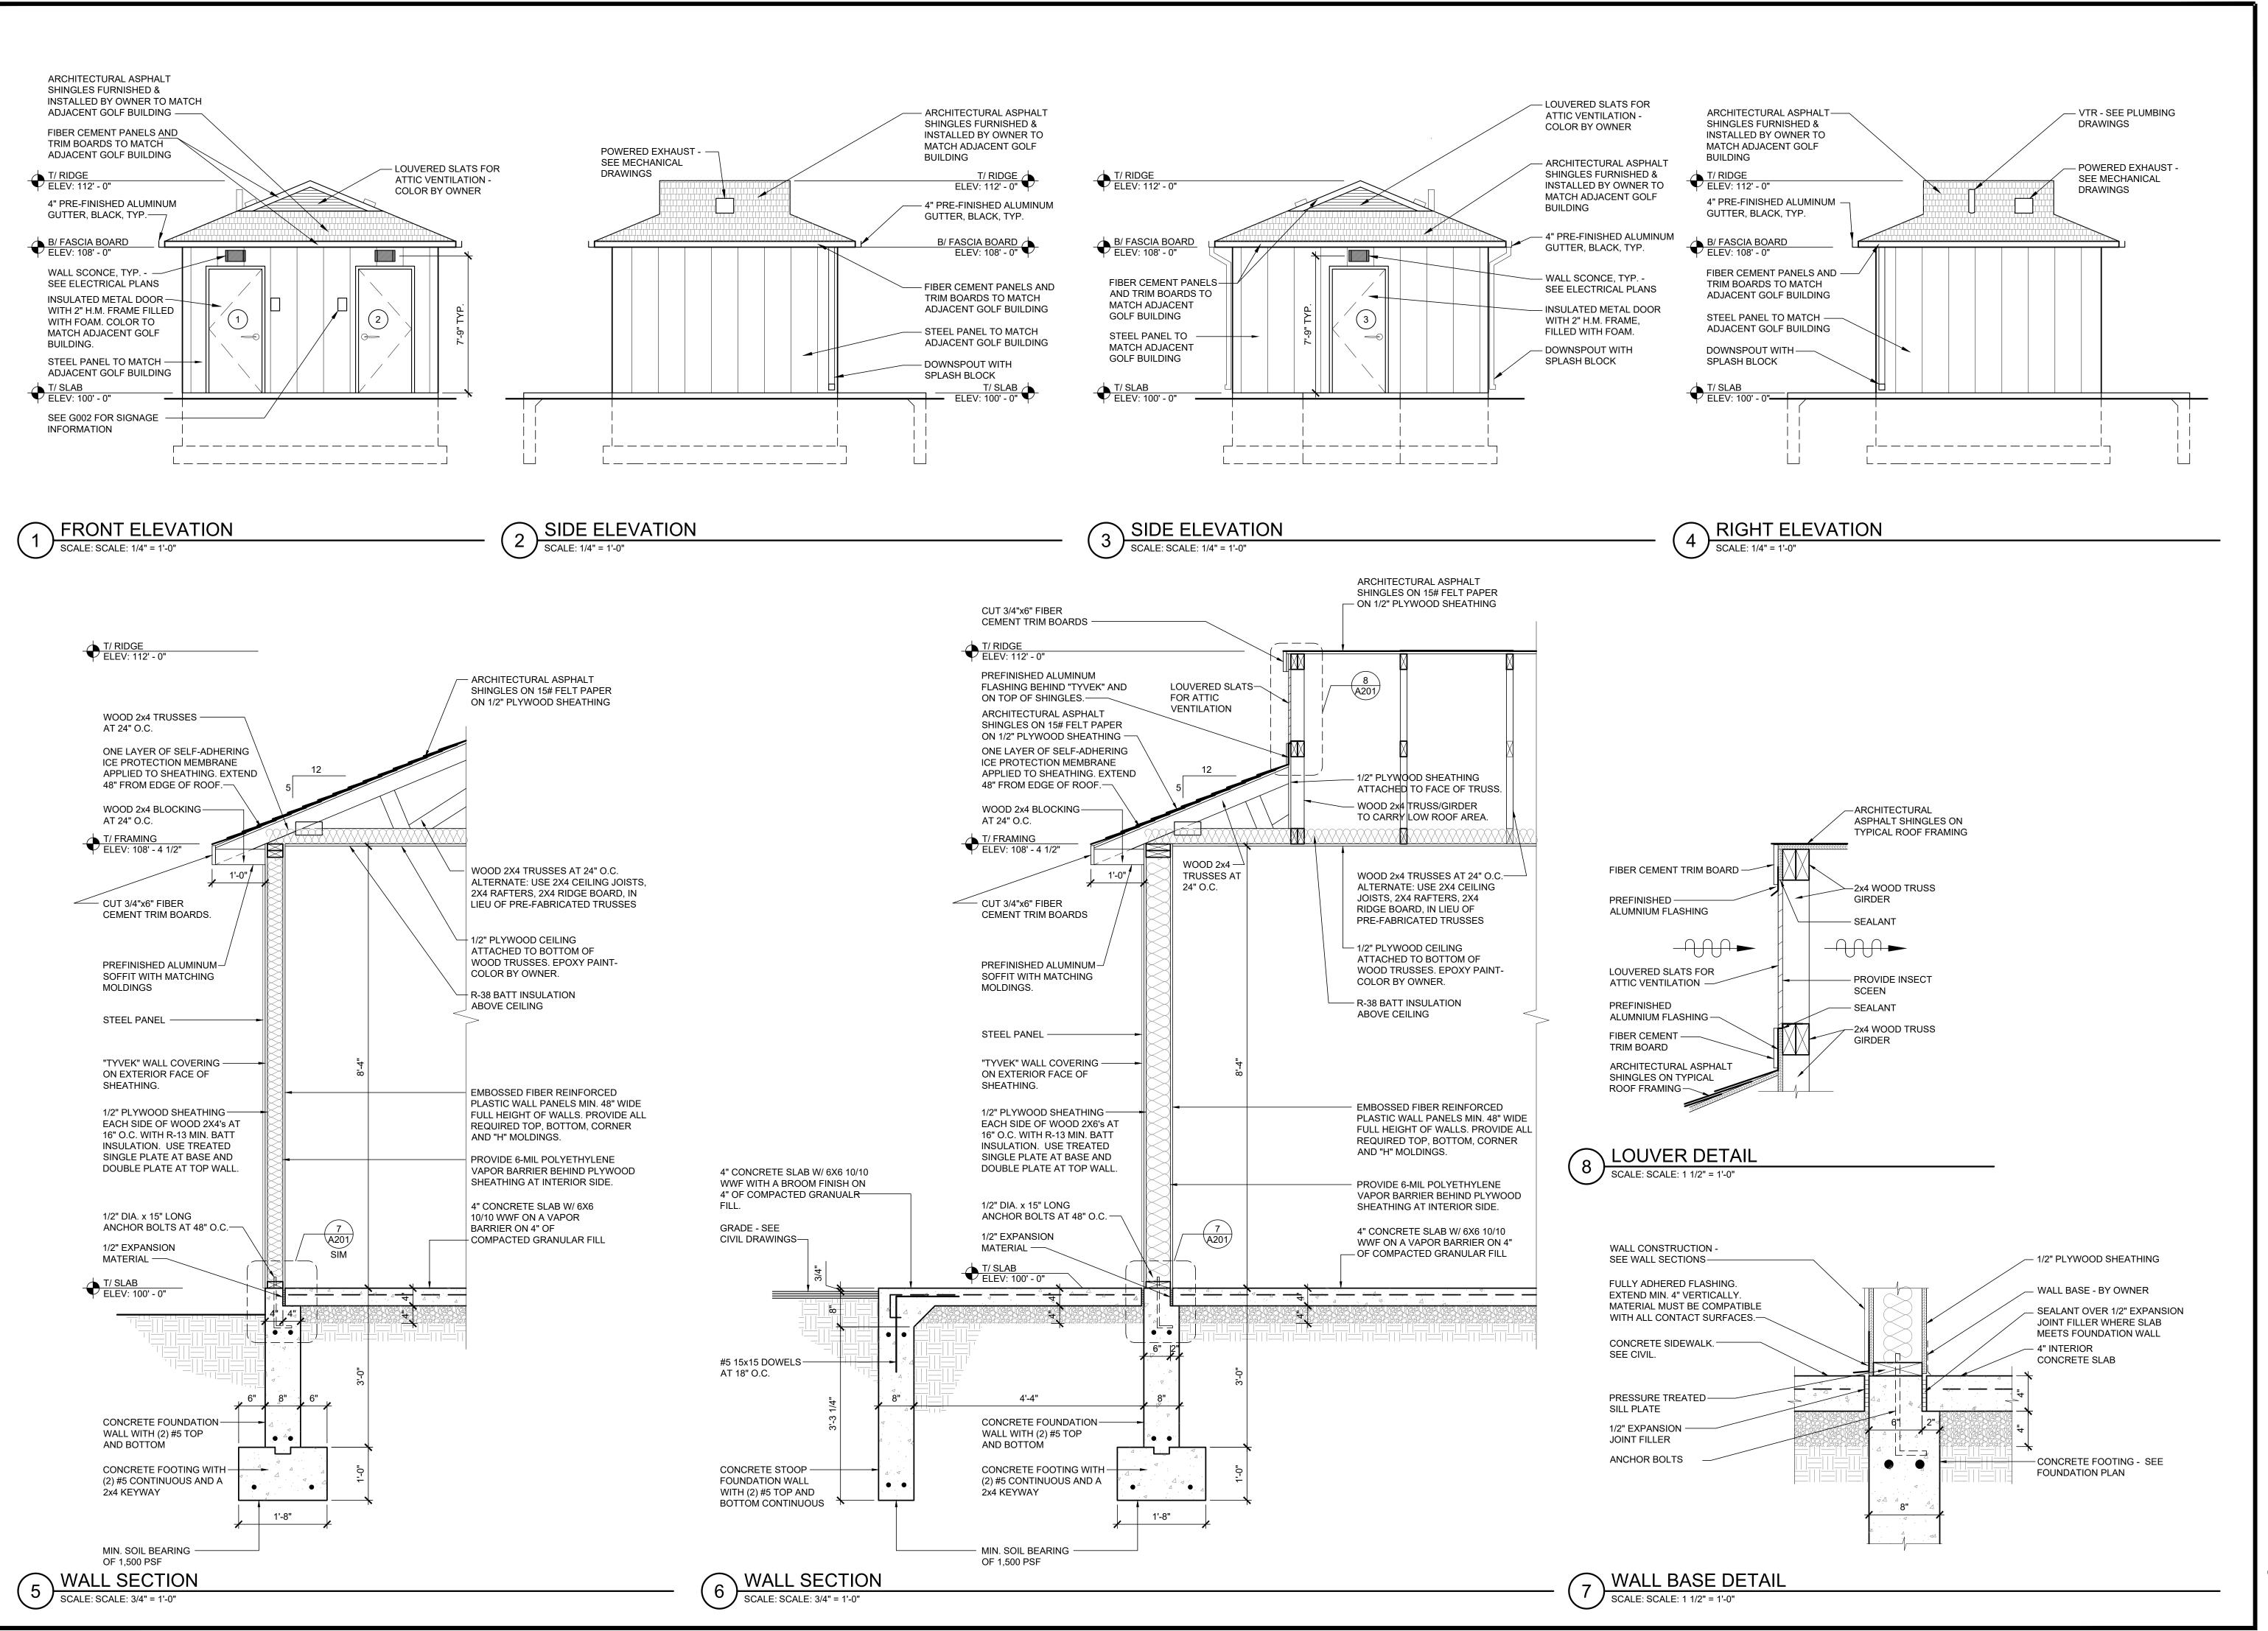



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roject no. C220000 late: 03.01.2022 BID

ELEVATIONS + WALL SECTIONS

						DOOR SO	CHEDULE (X)			
TAG	ROOM NAME	DOOR SIZE W X H	FRAME SIZE	DOOR TYPE	MATERIAL DOOR / FRAME	THRESHOLD DETAIL	MANUFACTURER	HARDWARE SET	FIRE RATING	COMMENTS
1	UNISEX RESTROOM	3'-0" x 7'-0"	3'-4" x7'-2"	А	INSUL. H.M.	N/A	CURRIES OR EQUAL	1	0-HOUR	FRAME FOR 2x6. COLOR BY OWNER.
2	ACCESSIBLE UNISEX RESTROOM	3'-0" x 7'-0"	3'-4" x7'-2"	А	INSUL. H.M.	N/A	CURRIES OR EQUAL	1	0-HOUR	FRAME FOR 2x6. COLOR BY OWNER.
3	UTILITY ROOM	3'-0" x 7'-0"	3'-4" x 7'-2"	А	INSUL. H.M.	N/A	CURRIES OR EQUAL	2	0-HOUR	FRAME FOR 2x4. COLOR BY OWNER.


DOOR HARDWARE

- 1 1/2 PAIR BUTT HINGES (4 1/2"x4 1/2" NRP)
- LEVER OPERATED LOCKSET DOUBLE BORE AND CYLINDER LOCK. DOOR CLOSER
- BOTH DOOR AND FRAME FACTORY PRIMED FOR PAINTING.FRAME COLOR TO MATCH DOOR.
- INSECT SWEEP


- <u>SET 2</u>

 1 1/2 PAIR BUTT HINGES (4 1/2"x4 1/2" NRP)
- LEVER OPERATED LOCKSET DOUBLE BORE AND CYLINDER LOCK WITH DEADBOLT.
- DOOR CLOSER
- BOTH DOOR AND FRAME FACTORY PRIMED FOR PAINTING.FRAME COLOR
- TO MATCH DOOR. INSECT SWEEP


- ALL DOORS ARE 1 3/4" THICK UNLESS NOTED OTHERWISE.
- ALL INTERIOR HOLLOW METAL FRAMES ARE 16 GA, WELDED TYPE.
- ALL CLOSERS AND HARDWARE TO BE US26D UNLESS NOTED OTHERWISE.
- ALL LOCKSETS TO BE KEYED SEPARATELY. ALL KEYWAYS TO BE STANDARD KEYWAYS.
- CONTRACTOR TO CONFIRM THAT ALL CYLINDERS WILL BE PROVIDED FROM ONE SOURCE.
- ALL CLOSERS AND LOCKSETS SHALL MEET ACCESSIBILITY REQUIREMENTS.
- ALL HINGES ON DOORS WITH CLOSERS TO BE OIL IMPREGNATED BEARING TYPE.
- ALL FRAMES TO RECIEVE STANDARD ANSI CURVED LIP STRIKE WITH ANSI WROUGHT STRIKE BOX WHERE REQUIRED.
- ALL CLOSERS TO BE SET FOR 110 DEGREE OPENING WHERE THE DOOR SWING WILL NOT BE IN CONFLICT WITH ADJACENT CONSTRUCTION.
- EXTERIOR DOORS TO HAVE MAXIMUM 5 POUNDS PUSH/PULL OPENING FORCE.
- ALL DOOR HANDLES, PULLS, LATCHES, LOCKS, AND OTHER OPERATING DEVICES SHALL BE
- INSTALLED AT LEAST 34" BUT NOT MORE THAN 48" ABOVE FINISH FLOOR. • THE OPERATING DEVICES SHALL BE CAPABLE OF OPERATION WITH ONE HAND AND SHALL
- NOT REQUIRE TIGHT GRASPING, TIGHT PINCHING, OR TWISTING OF WRIST TO OPERATE.
- EGRESS DOORS SHALL OPEN READILY FROM THE EGRESS SIDE WITHOUT THE USE OF A KEY OR SPECIAL KNOWLEDGE OR EFFORT.
- THE USE OF MACHINE SCREWS FOR CONTINUOUS HINGE ANCHORAGE IS REQUIRED. PROVIDE ADDITIONAL REINFORCING FOR THE HINGES IN THE FRAMES AND DOOR STILES.
- THE HARDWARE INSTALLER TO CONFIRM THAT ALL CLOSERS HAVE THE BACKCHECK VALVE SCREWED IN, FOR PARALLEL ARM INSTALLATIONS.

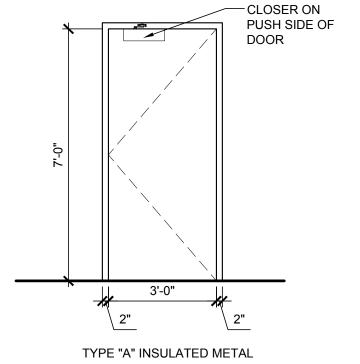



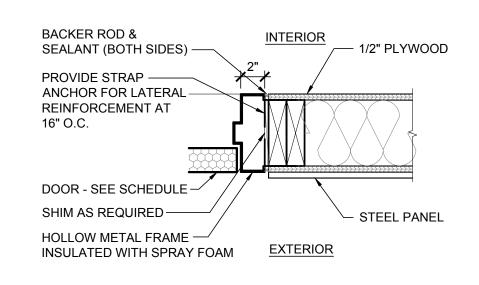




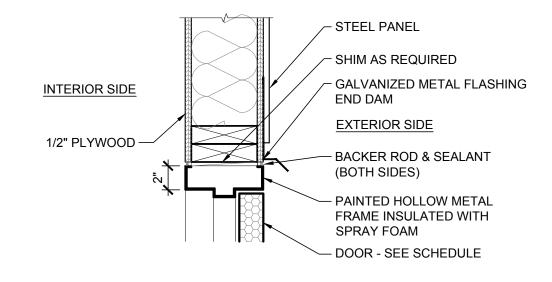







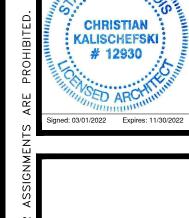

date: 03.01.2022 BID

SCHEDULES AND DETAILS



PLUMBING SPECIFICATIONS

THE GENERAL CONDITIONS AND SUPPLEMENTAL GENERAL CONDITIONS ISSUED BY THE ARCHITECT SHALL GOVERN WHERE APPLICABLE.

THIS CONTRACTOR SHALL THOROUGHLY FAMILIARIZE HIMSELF WITH THE PLANS AND SHALL VERIFY EXISTING SITE CONDITIONS AT THE JOB SITE BEFORE SUBMITTING BID. FAILURE TO RECOGNIZE WORK REQUIRED SHALL BE AT THE EXPENSE OF THIS CONTRACTOR. NO CONSIDERATION SHALL BE GIVEN FOR ADDITIONAL COMPENSATION AFTER THE LETTING OF BIDS.

ENTIRE INSTALLATION SHALL BE PERFORMED IN A FIRST-CLASS WORKMANLIKE MANNER. THE COMPLETED SYSTEMS SHALL BE FULLY OPERATIONAL; ACCEPTANCE BY THE OWNER SHALL BE A CONDITION OF THE CONTRACT. ALL WORK SHALL BE COORDINATED WITH OTHER TRADES IN ORDER TO AVOID INTERFERENCES, PRESERVE MAXIMUM HEADROOM, AND AVOID OMISSIONS.

CONTRACTOR TO MAKE ALL NECESSARY TAPS, AS CALLED FOR ON THE DRAWINGS.

THIS CONTRACTOR SHALL REMOVE ALL DEBRIS ON A REGULAR BASIS AND UPON COMPLETION OF THE JOB AND CLEAN ALL FIXTURES.

COVER ALL HOT AND COLD LINES, ROOF DRAINS AND HORIZONTAL DOWNSPOUT PIPING. PIPE COVERING TO BE SHALL BE 3 1/2 LB. DENSITY FIBERGLASS WITH MOLDED FITTINGS AND BUTT JOINTS AND VAPOR BARRIER.

IT SHALL BE THE RESPONSIBILITY OF THIS CONTRACTOR TO START UP, ADJUST AND CHECK FOR PROPER OPERATION ALL EQUIPMENT INSTALLED UNDER HIS CONTRACT.

THIS CONTRACTOR SHALL ALLOW IN HIS INITIAL BID THE COST OF SERVICE ON ALL EQUIPMENT INSTALLED UNDER HIS CONTRACT FOR A PERIOD OF ONE (I) YEAR FROM DATE OF FINAL ACCEPTANCE OF THE WORK.

ALL WATER PIPING SHALL BE TESTED WITH WATER UNDER PRESSURE OF 100 PSI FOR 10 MINUTES, AND MADE TIGHT AT THIS PRESSURE.

ALL SOIL, WASTE AND VENT PIPING SHALL BE SUBJECTED TO A HYDROSTATIC TEST OF NOT LESS THAN IO FEET OF WATER COLUMN FOR 15 MINUTES BEFORE INSPECTION STARTS AND PROVEN TIGHT.

BEFORE TURNING PLUMBING SYSTEM OVER TO THE OWNER, CHLORINATE ALL DOMESTIC WATER PIPING FOR A PERIOD OF 24 HOURS. AFTER CHLORINATION HAS BEEN COMPLETED, FLUSH ALL PIPING UNTIL WATER RUNS CLEAR AND IS RESIDUAL CHLORINE FREE.

ALL BELOW GROUND WASTE, VENT AND STORM SEMER PIPING SHALL BE SERVICE WEIGHT CAST-IRON, ALL ABOVE GROUND WASTE, VENT AND STORM SEMER PIPING 3" AND LARGER SHALL BE SERVICE WEIGHT CAST-IRON, ALL WASTE VENT AND STORM SEMER PIPING 2" AND SMALL SHALL BE GALVANIZED OR TYPE "M" COPPER. (SCHEDULE 40 PVC MAY BE USED ABOVE GRADE IF APPROVED BY THE THE LOCAL AUTHORITY) ALL BELOW GROUND WATER PIPING 3" AND LARGER SHALL BE DUCTILE-IRON, ALL BELOW GROUND WATER PIPING 2" AND SMALLER SHALL BE TYPE "K" COPPER, ALL ABOVE GROUND WATER PIPING SHALL BE TYPE "L" COPPER.

THE PLUMBING SYSTEM SHALL BE INSTALLED IN CONFORMANCE WITH STATE OF ILLINOIS PLUMBING CODE ALL REQUIREMENTS OF THE LOCAL CODES AND ORDINANCES

FIXTURE SCHEDULE

NC-I "AMERICAN STANDARD" MODEL#73IAA.OOI CHAMPION 4 RIGHT HIEGHT FLOOR SET TANK TYPE ADA COMPLIANT WATER CLOSET, VITREOUS CHINA, HIGH-EFFICIENCY (I.6 GPF), EVERCLEAN SURFACE INHIBITS THE GROWTH OF BACTERIA, MOLD AND MILDEW, ELONGATED BOWL, POWERFUL DIRECT-FED SIPHON JET ACTION,

"BEMIS" MODEL #2155C WATER CLOSET SEAT. SEAT SHALL CONTAIN DURAGUARD, AN ANTIMICROBIAL AGENT. SEAT SHALL BE HEAVY WEIGHT AND INJECTION MOLDED OF SOLID PLASTIC. SEAT SHALL BE OPEN FRONT LESS COVER FOR ELONGATED BOWL AND FEATURE LARGE MOLDED-IN BUMPERS. EXTERNAL CHECK HINGES TO FEATURE 300 SERIES STAINLESS STEEL POSTS THAT STOP SEAT II DEGREES BEYOND VERTICAL.

L-I "AMERICAN STANDARD" MODEL# 0355.012 LUCERNE LAVATORY.
WALL-HUNG, VITREOUS CHINA, FRONT OVERFLOW, D-SHAPED BOWL,
SELF-DRAINING DECK AREA WITH CONTOURED BACK AND SIDE
SPLASH SHIELDS, FAUCET LEDGE, FAUCET HOLES ON 4" CENTERS
AND WALL HANGER.
(MOUNT RIM 34" AFF)

"JAY R SMITH" MODEL #0700 LAVATORY SUPPORT.

"SLOAN" MODEL #EBF-650-4-BDT CHROME PLATED BRASS, SENSOR ACTIVATED, 4" CENTER-SET ELECTRONIC HAND WASHING FAUCET (SET TEMPERATURE SHALL NOT EXCEED 110 DEGREES F)

"MCGUIRE" MODEL #PW2I25WCPRO SEAMLESS PRE-WRAPPED ADJUSTABLE CAST BRASS P-TRAP KIT WITH PRE-WRAPPED PRO-DRAIN OFFSET GRID STRAINER. KIT ALSO INCLUDES SUPPLY COVERS.

PROVIDE CHROME-PLATED ANGLES STOPS, ESCUTCHEONS AND RISER

MB-I MOP BASIN "FIAT" #TSBC60II TERRAZZO BASIN WITH
INTEGRAL DRAIN BODY AND "FIAT" 830-AA SERVICE FAUCET
FITTING WITH VACUUM BREAKER, HOSE THREAD SPOUT AND
INTEGRAL STOPS

EQUIPMENT SCHEDULE

I-I ELECTRIC WATER HEATER WITH MOUNTING SHELF, "A.O. SMITH" #E6-12CI55V, I2 GALLON, I,500 W, I20 V, I PHASE, A RECOVERY RATE OF 9 GPH AT A 90° F. TEMPERATURE RISE, TEMPERATURE AND PRESSURE RELIEF VALVE (MOUNT ON SHELF ABOVE MB)

ET-I EXPANSION TANK "AMTROL" #ST-5

PLUMBING SYMBOLS

NOT ALL SYMBOLS MAY APPLY ----- EXISTING COLD WATER PIPING ---- EXISTING HOT WATER PIPING ---- EXISTING HOT WATER RETURN PIPING - - EXISTING UNDERGROUND SEWER EXISTING SUSPENDED SEWER - - - EXISTING VENT PIPING ----- COLD WATER PIPING (INSULATED) ---- HOT WATER RETURN PIPING (INSULATED) -----TWS ------ TEMPERED WATER PIPING (INSULATED) TWR TEMPERED WATER RETURN PIPING (INSULATED) — UNDERGROUND SEWER SUSPENDED SEWER DRAIN TILE VENT PIPING

VENT PIPING
UNION

IF CO CLEANOUT PLUG

II— CO CLEANOUT PLUG

III— MCO WALL CLEANOUT PLUG ("MI-FAB" #C1430-RD)

FCO-I FLOOR CLEANOUT ("MI-FAB" #CI200-C-5-3)

FCO-2 FLOOR CLEANOUT ("MIFAB" #CI000-R-3)

YCO YARD CLEANOUT ("MI-FAB" #CIIOO-XR)

FD-I FLOOR DRAIN ("MI-FAB" #FIIOOX-C-5-3)

FD-2 FLOOR DRAIN ("MI-FAB" #FI320-TFB-4)

FD-3 FLOOR FUNNEL DRAIN ("MI-FAB" #FIIOO-C-EF-3)

OSD OPEN SITE DRAIN

AREA DRAIN ("MI-FAB" #F1820-81)

FS FLOOR SINK ("MI-FAB" #FSI720-I50-I-3)
W/ I/2 GRATE & SEDIMENT BUCKET

ROOF DRAIN ("MI-FAB" #RI200-M-U-I2)

OD OVERFLOW ROOF DRAIN ("MI-FAB" #RI200-W-I2)

DOWNSPOUT NOZZLE ("MI-FAB" #RI940-83-1)

✓ GV GATE VALVE ("NIBCO" #T-131)

BY BALL VALVE ("NIBCO" #580-70)

BY BALANCING VALVE ("NIBCO" #51710)

CY CHECK VALVE ("NIBCO" #433)

BFP BACKFLOW PREVENTER ("WATTS" SERIES SD-3)

FROSTPROOF SILLCOCK ("WOODFORD" #B67)

→ HB HOSE BIBB ("WOODFORD" #24P)

O→ RSC-I ROOF FROSTPROOF SILLCOCK ("WOODFORD" #SRH-MS)

TRENCH DRAIN ("MIFAB" #T-I400-PGV-4-3 STAINLESS STEEL FRAME AND GRATE, "MI-FAB" #TI400-CB-620-PGV-4-3 CATCH BASIN)

-VACUUM RELIEF VALVE

STACK OR RISER DESIGNATION

4" UNDERGROUND
SANITARY SEWER
FOR CONT. SEE
SITE UTILITY PLAN


4"X5" V.T.R.

2"
2"
4"
4"
4"
4"
FD-1

4"
4"
4"
FD-1

DIAGRAM-WASTE AND VENT PIPING

1/2" = 1'-0"

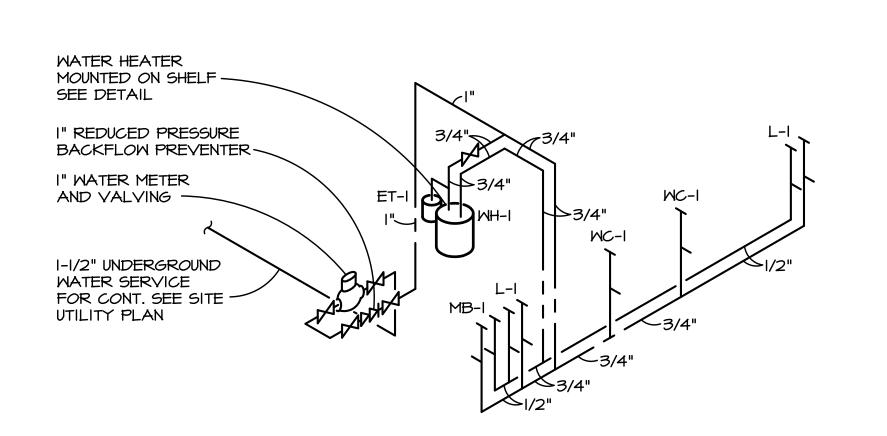

3/4"HW OUTLET-BALL VALVE WATER THERMOMETER DI-ELECTRIC UNIONS TEMPERATURE AND PRESSURE RELIEF VALVE EXPANSION TANK WATER HEATER SEE PLAN FOR SIZE AND TYPE RELIEF VALVE DISCHARGE NON-DRIP, CORROSION RESISTANT, PIPED INDIRECTLY TO 24 GAUGE GALVANIZED STEEL DRAIN PAN SHELF FLOOR DRAIN OR OTHER APPROVED RECEPTOR. MOUNTING BRACKET DRAIN PAN DISCHARGE AND SUPPORTS MOUNTED PIPED INDIRECTLY TO FLOOR DRAIN OR OTHER APPROVED RECEPTOR. NOTE: I.) ALL DISCHARGE PIPING SHALL BE OF METALLIC MATERIAL.

DETAIL-ELECTRIC WATER HEATER MOUNTED ON SHELF

2.) FLOOR DRAIN TRAP SHALL BE DEEP SEAL OR FED BY PRIMING DEVICE.

ABOVE A FLOOR DRAIN LOCATED IN A BATHROOM SHALL BE FURNISHED

3.) ALL RELIEF VALVE AND DRAIN PAN DISCHARGE PIPING TERMINATING

AND INSTALLED WITH A CHROME PLATED ELBOW AND ESCUTCHEON.

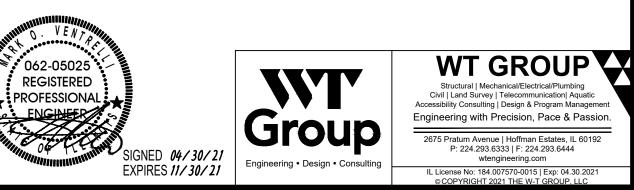


DIAGRAM-WATER PIPING

RIGHT & OTHER RIGHTS RESTRICTING THESE DOCUMENTS I


RIDGES TOP TRACER BATHF

100 POPLAR CREEK DRIVE

project no. C22000000 date: O3.01.2022 BID revision 1: revision 2: revision 3: revision 4:

sheet title:
PLUMBING PLAN AND
DETAILS
sheet number:

sheet number:

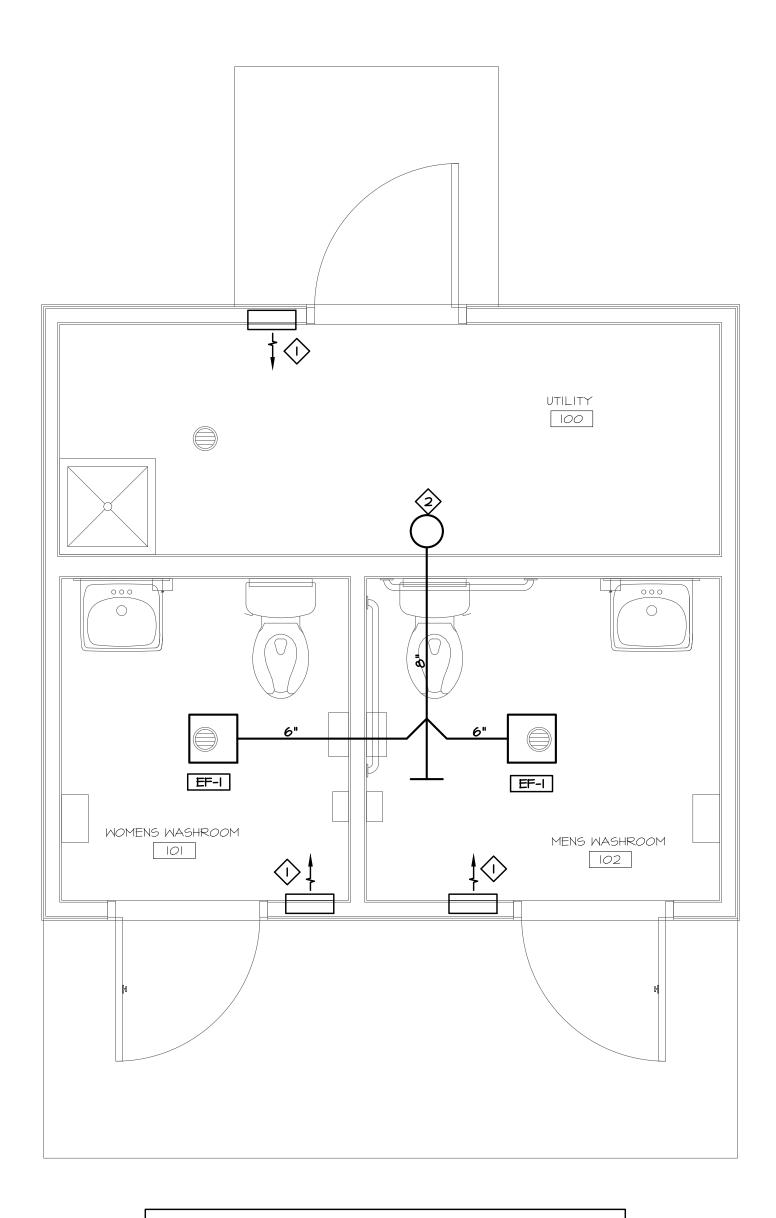

PLAN KEYED NOTES
750 WATT ELECTRIC WALL HEATER FURNISHED AND INSTALLED BY THE ELECTRICAL CONTRACTOR.
2 8" EXHAUST UP THRU ROOF WITH GOOSENECK TERMINATION.


1 MECHANICAL PLAN 1/2" = 1'-0"

				EXH	AUST I	FAN S	CHEDULE					
ITEM	MANUFACTURER AND	CFM	ESP	ELECTRICAL DATA CONTROLLED VIA			DAMPER	AREA SERVING	UNIT WEIGHT	REMARKS		
TAG	MODEL NUMBER	OITT		VOLT-PH-HZ	HP OR NOTED	RPM	CONTROLLED VIV	TYPE	AND SERVING	(LBS)		
EF-I	"PANASONIC" #FV-0510VSLI	80	0.25"	120-1-60	0.25 AMPS	1176	OCCUPANCY SENSOR	BACKDRAFT	TOILETS	12	ALL	

REMARKS:

FAN / LIGHT COMBO
 VERIFY EXACT VOLTAGE PRIOR TO ORDERING EQUIPMENT.
 ELECTRICAL CONTRACTOR SHALL PROVIDE DISCONNECT SWITCH AND LINE WIRING.

					VENT	ILATION SCH	EDULE						
ROOM TAG	ROOM NAME	ROOM	NUMBER OF	TABLE REQUIREMENTS		20112 / 1111	REQUIRED SPACE VENTILATION		ACTUAL SPACE VENTILATION			SERVED BY	
	OCCUPANCY CLASSIFICATION	AREA (SQFT)	OCCUPANTS OR FIXTURES	(CFM / OCC.)	(CFM / SQFT)	DIST. EFFECT.	O.A. (CFM)	EXHAUST (CFM)	SUPPLY (CFM)	O.A. (CFM)	EXHAUST (CFM)	SUPPLY	EXHAUST
100	UTILITY	65	0	0	0	0.8	0	NR	0	0	-		-
101	WOMENS WASHROOM	40	1	0	0	0.8	0	70	0	0	80		EF-1
102	MENS WASHROOM	49	1	0	0	0.8	0	70	0	0	80		EF-1

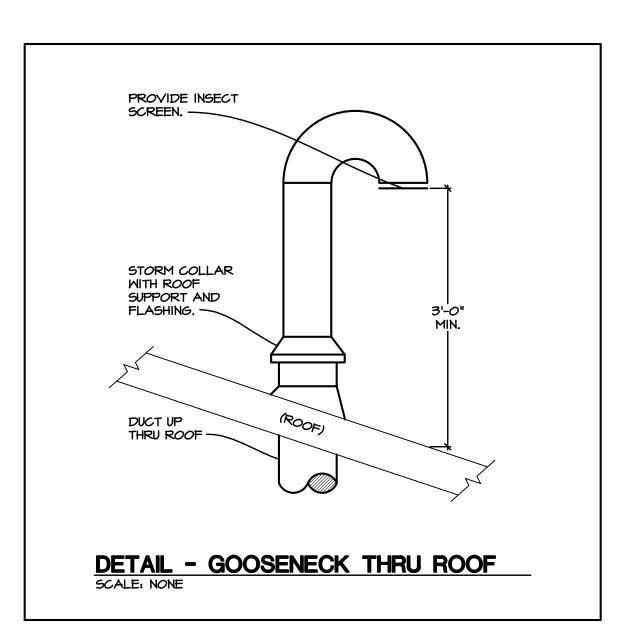






60169 CREEK DRIVE 1400

project no. C2200007 date: O3.01.2022 BID

sheet title:

MECHANICAL PLAN

AND SCHEDULES

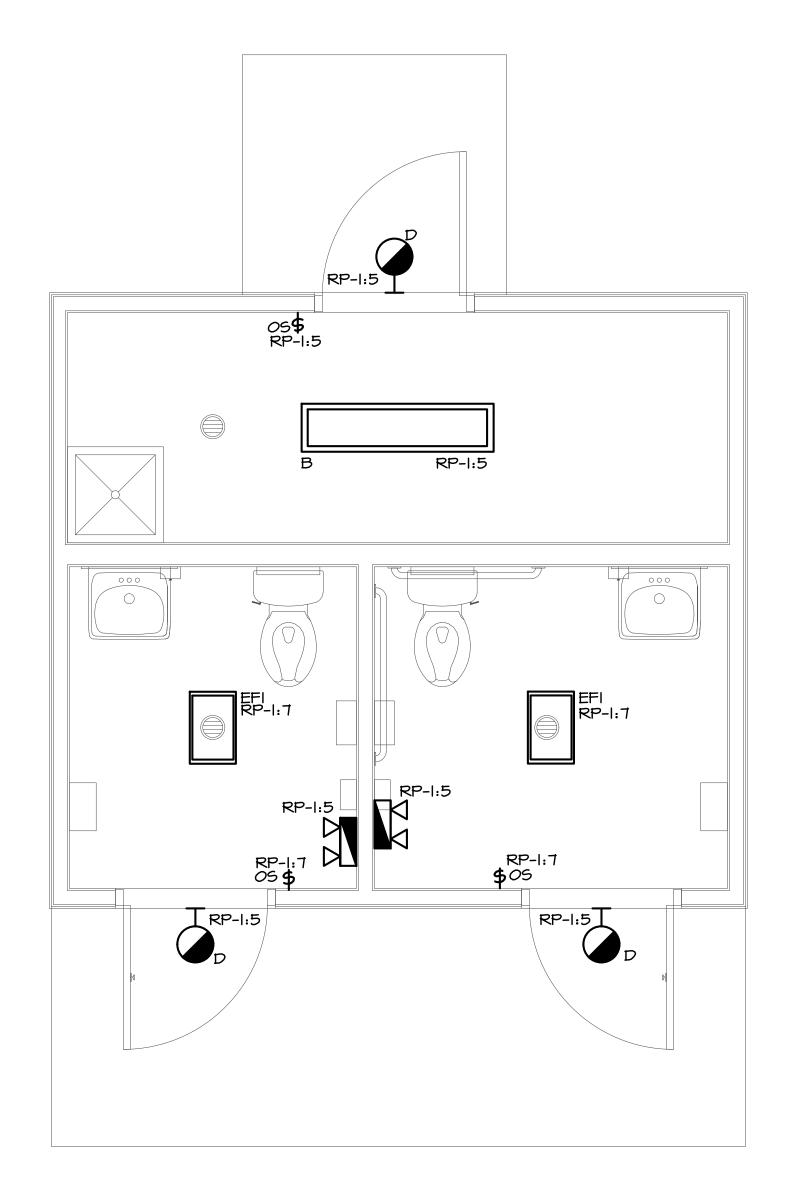


2 ELECTRICAL LIGHTING PLAN
1/2" = 1'-0"

	LI	GHTING FIXTU	JRE SCHEDUL	E	
TYPE	DESCRIPTION & FEATURES	LAMPS QTY. TYPE	MOUNTING CLG./POLE-TYPE	VOLT	SPECIFIED MANUFACTURER AND CATALOG NUMBER
EF1	LED LIGHT & EXHAUST FAN	IOW LED	RECESSED	120	PANASONIC: FV-0510VSLI
В	4'-0" LED WRAPAROUND WBUILT-IN	34.9W LED	SURFACE	120	LITHONIA #STL4-48L-EZI-LP830
	EMERGENCY BATTERY BACK-UP				ELI4L
D	EXTERIOR CYLINDER	I4W LED	SURFACE	120	LITHONIA-OLLWD LED PI 40K MVOLT DDB
					PROVIDE 90 MINUTE BATTERY BACKED INVERTER
	EMERGENCY BATTERY LIGHT	LED	MALL	UNV.	COOPER SURE-LITES: SELMTG SERIES
					SELMTRG60R5SD

NOTES

- I. THE FIXTURE SCHEDULE DOES NOT NECESSARILY LIST ALL ACCESSORIES AND HARDWARE NECESSARY FOR THE COMPLETION OF INSTALLATION, NOR DOES IT DETAIL THE CEILING CONSTRUCTION TO BE ENCOUNTERED. IT IS THE CONTRACTOR'S RESPONSIBILITY TO PROPERLY DETERMINE AND PROVIDE CORRECT COMPONENTS, ACCESSORIES, AND HARDWARE AS REQUIRED FOR THE INSTALLATION.
- CONTRACTOR SHALL COORDINATE WITH ARCHITECTURAL DRAWINGS AND CEILING CONTRACTOR FOR EXACT LIGHTING FIXTURE LOCATION.
- 3. ALL BATTERY BACK-UP EMERGENCY LIGHT AND EXIT SIGN LIGHTING FIXTURES INDICATED SHALL HAVE BATTERY BACK-UP RATED FOR I-I/2 HOURS MINIMUM AND AS APPROVED BY LOCAL FIRE PREVENTION BUREAU.

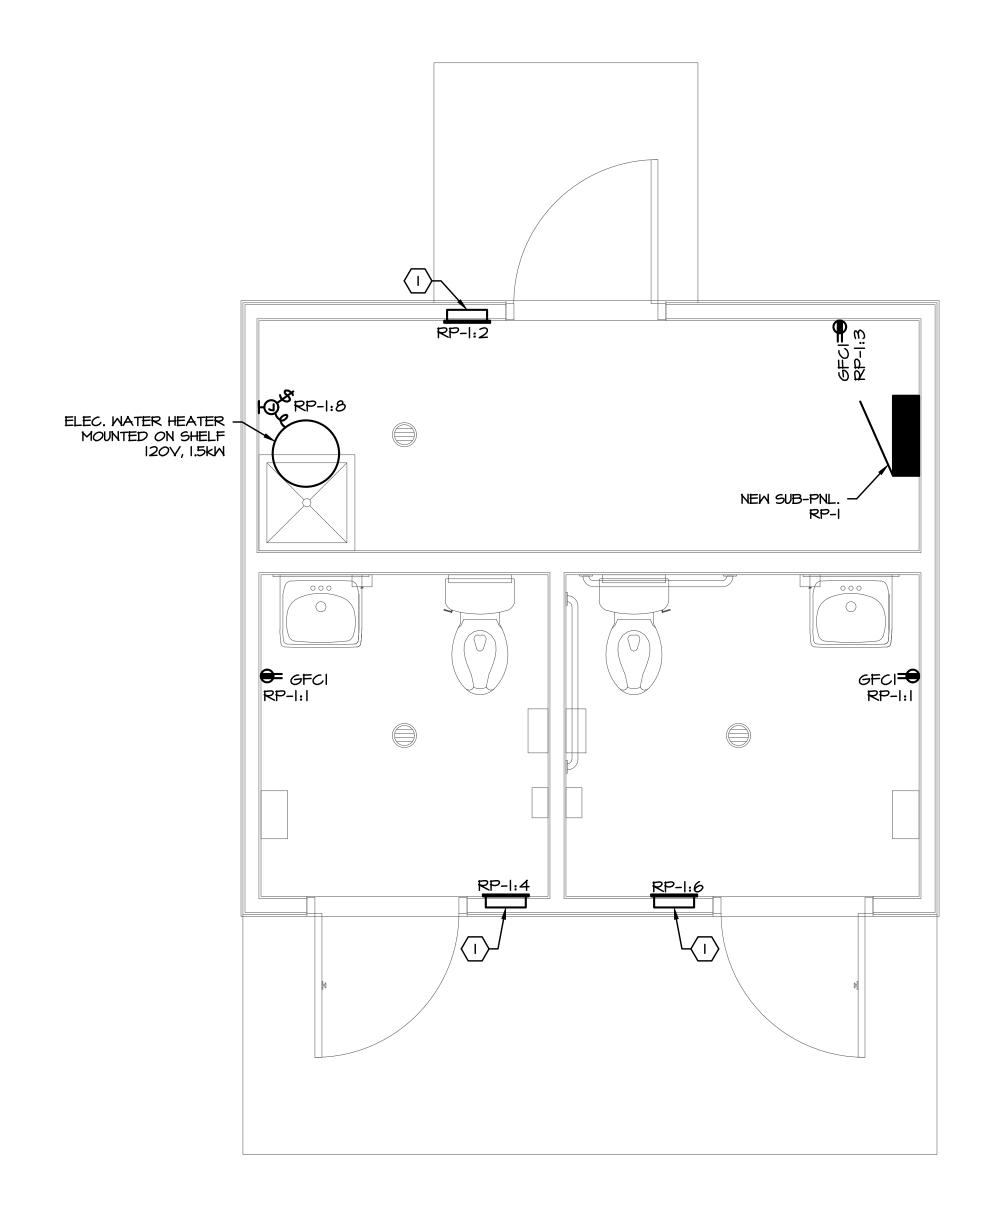

1) ELECTRICAL POWER PLAN 1/2" = 1'-0"

***** KEYED NOTES

I. ELECTRICAL UNIT HEATER 1500/750M WITH BUILD IN THERMOSTAT AND DISCONNECT SWITCH. MARKEL: E3035, I20V, I2.6/6.25A

LIGHTING CONTROL NOTES:

OS\$ DUAL-TECH WALLBOX SENSOR (WIRED: 120/27TV).
#ONW-D-1001-MV-N, MOTOR LOAD: 1/4HP RATED @ 125VAC
(NEUTRAL REQUIRED) CONFIGURE FOR AUTO ON / AUTO OFF
FUNCTIONALITY

REGISTERED
PROFESSION AF

SIGNED 04/30/21

EXPIRES 11/30/21



Structural | Mechanical/Electrical/Plumbing
Civil | Land Survey | Telecommunication| Aquatic
Accessibility Consulting | Design & Program Management
Engineering with Precision, Pace & Passion.

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wtengineering.com

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GES TOP TRACER BATHROOM UTILITIES
POPLAR CREEK DRIVE

BRIDGES TOP T

1400 POPLAR C

1200 03.01.2022

project no. C220000

date: O3.01.2022 BID

revision 1:
revision 2:
revision 3:
revision 4:

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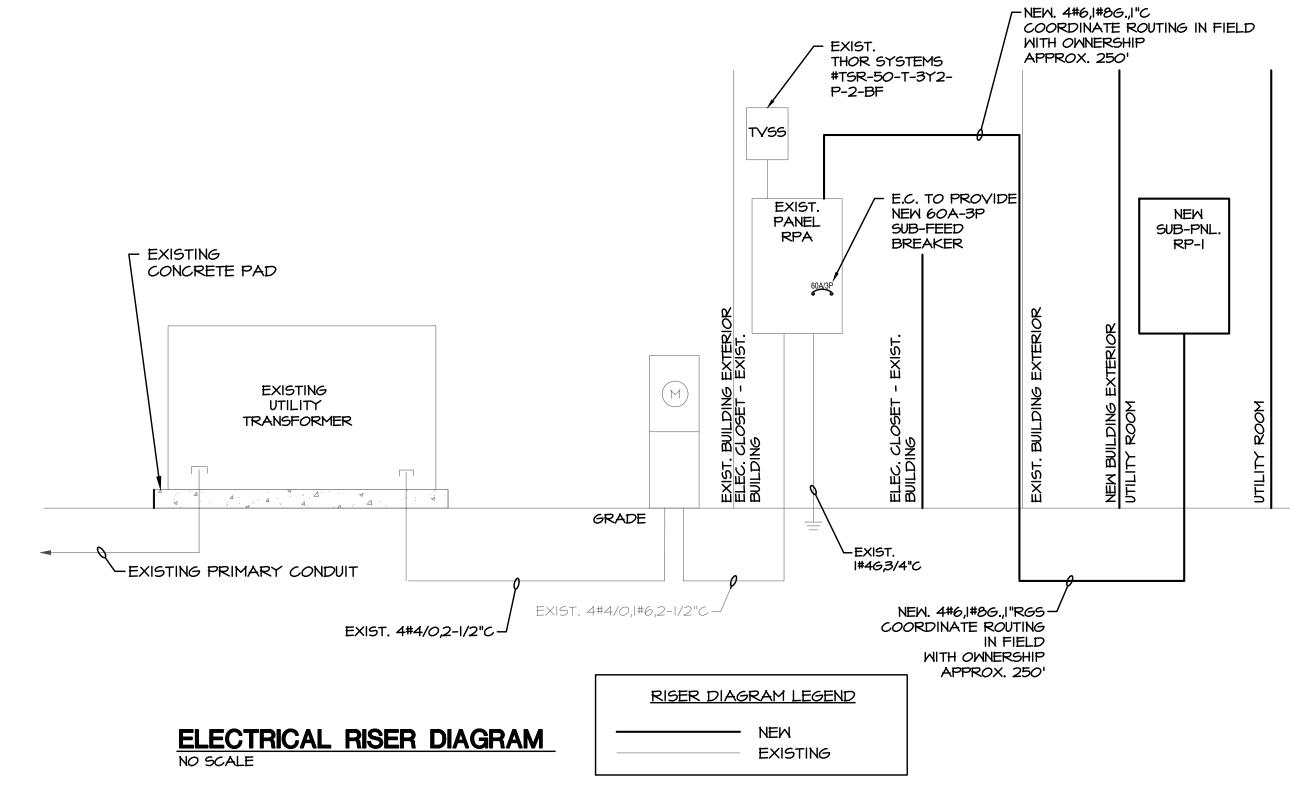
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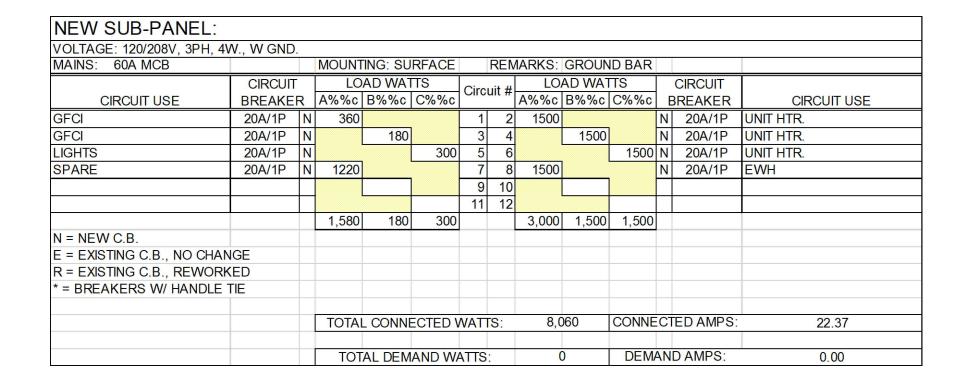
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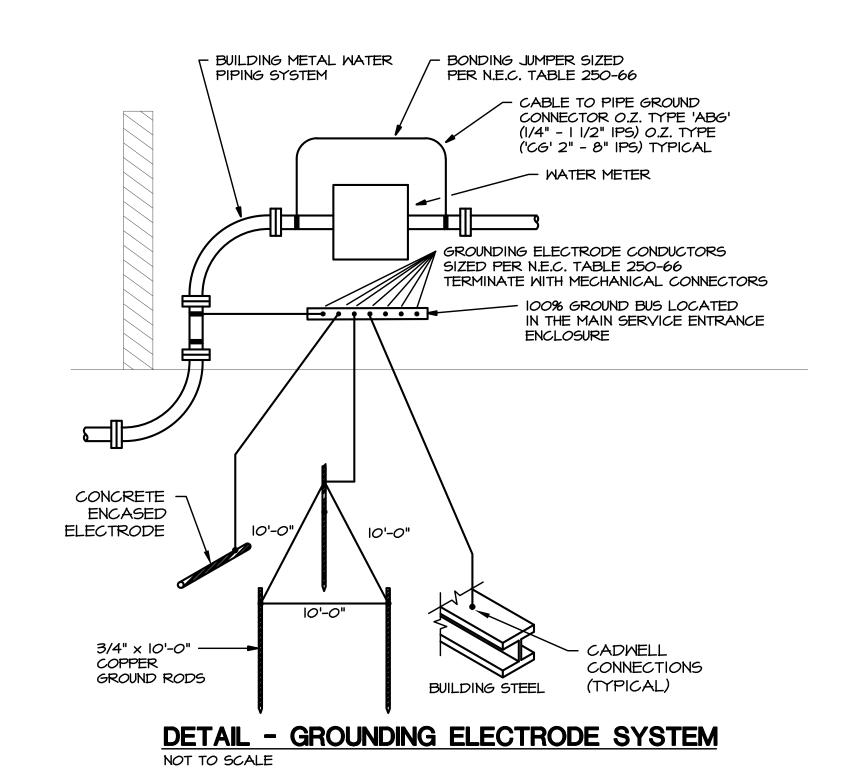
ELECTRICAL PLANS


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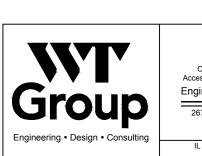
PA	NEL		RPA VOLTS		120/20				
A۱	ИPS		225 MAIN _	20	OA/3P	M.C.B A.I.C. 10,000	1		_
_	CAT	ION	UTILITY ROOM			MOUNTING SURFACE			
CIRCUIT	POLE	TRIP	DESCRIPTION	KVA	KVA	DESCRIPTION	TRIP	POLE	CIRCUIT
* 1	ı	20	TV DISPLAYS	1.08	1.08	GENERAL OUTLETS	20	ı	2 *
* 3	ı	20	TV DISPLAYS	1.08		SPARE	20	ı	4
* 5	ı	20	GOLF DISPLAY	0.50	0.90	GENERAL OUTLETS	20	ı	6
* 7	ı	20	GOLF DISPLAY	0.50	0.36	RECEPTION OUTLETS	20	ı	8
9	ı	20	GOLF TRACKING SENSORS	0.20	0.20	FACP	20	ı	10
11	2		ELECTRIC UNIT HEATER - UTILITY RM	3.30	1.00	GOLF SERVER	20	ı	12
13		30			0.36	ттв	20	ı	14
15	ı	20	FIRE PIT POWER	0.20		SPARE	20	ı	16
17	ı	20	RADIANT HEATERS	0.60		SPARE	20	ı	18
19	1	20	RADIANT HEATERS	0.50			60		20
21	1	20	SPARE			NEW SUB-PNL. RP-I			22
23	ı	20	SPARE					3	24
25	ı	20	SPARE			SPARE	20	ı	26
27	ı	20	SPARE			SPARE	20	ı	28
29	1	20	SPARE			SPARE	20	ı	30
31	1	20	SPARE			SPARE	20	ı	32
33	1	20	SPARE			SPARE	20	1	34
35	ı	20	SPARE			SPARE	20	ı	36
37	ı	20	SPARE			SPARE	20	ı	38
39	1	20	SPARE			SPARE	20	1	40
41	1	20	SPARE			SPARE	20	1	42
43	ı	20	SPARE			SPARE	20	ı	44
45	ı	20	SPARE			SPARE	20	ı	46
47	ı	20	SPARE			SPARE	20	ı	48
49	1	20	SPARE			SPARE	20	ı	50
51	ı	20	SPARE		0.25	PHOTOCELL/TIMER	20	ı	52
53	ı	20	SPARE		0.50	INTERIOR LIGHTING	20	ı	54
55	3		TV55		0.58	EXTERIOR LIGHTING	20	ı	56
57					0.54	INTERIOR LIGHTING	20	ı	58
59		30			0.27	INTERIOR PADDLE FANS	20	ı	60
* INE	DICAT	ES G	FCI C/B TOTAL =	7.96	6.04	= TOTAL TOTAL KVA = 14.00 TOTAL AM	PS =	5	38.8









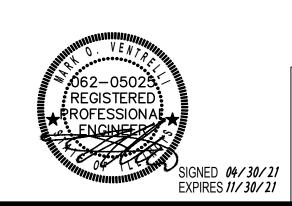





1400 late: 03.01.2022 BID

sheet title:
RISER DIAGRAM +
PANEL SCHEDULES

ELECTRICAL SPECIFICATIONS

THE GENERAL CONDITIONS AND SUPPLEMENTAL GENERAL CONDITIONS BY THE ARCHITECT SHALL GOVERN WHERE APPLICABLE.

THIS CONTRACTOR SHALL THOROUGHLY FAMILIARIZE HIMSELF WITH THE PLANS AND SHALL VERIFY EXISTING SITE CONDITIONS AT THE JOB SITE BEFORE SUBMITTING BID. FAILURE TO RECOGNIZE WORK REQUIRED SHALL BE AT THE EXPENSE OF THIS CONTRACTOR. NO CONSIDERATION SHALL BE GIVEN FOR ADDITIONAL COMPENSATION AFTER THE LETTING OF BIDS.

ENTIRE INSTALLATION SHALL BE PERFORMED IN A FIRST-CLASS WORKMANLIKE MANNER AND SHALL CONFORM TO ALL APPLICABLE CODES AND ORDINANCES. THE COMPLETED SYSTEMS SHALL BE FULLY OPERATIONAL: ACCEPTANCE BY THE OWNER SHALL BE A CONDITION OF THE CONTRACT. ALL WORK SHALL BE COORDINATED WITH OTHER TRADES IN ORDER TO AVOID INTERFERENCE'S, PRESERVE MAXIMUM HEADROOM, AND AVOID OMISSIONS. ALL MATERIALS, WORKMANSHIP AND EQUIPMENT SHALL BE GUARANTEED FOR ONE (I) YEAR AFTER SYSTEM ACCEPTANCE.

RECEPTACLES AND SWITCHES SHALL BE THE TYPE AS SHOWN ON THE DRAWINGS AND SHALL BE SPECIFICATION GRADE.

MINIMUM BRANCH WIRE SIZE SHALL BE #12 AWG COPPER EXCEPT FOR CONTROL AND SIGNAL CIRCUITS. INSULATION (INTERIOR) SHALL BE SOLID TYPE THHN OR THWN SIZES #12 THROUGH #10. SIZES #8 THROUGH 750 MCM SHALL BE STRANDED TYPE THHN OR THWN AT THE CONTRACTOR'S OPTION.

MINIMUM OUTLET BOXES SHALL BE 4" SQUARE, UNLESS OTHERWISE SPECIFIED.

CONTRACTOR SHALL NOT SCALE DRAWINGS FOR DIMENSIONS BUT SHALL CONTACT THE PROJECT ARCHITECT FOR ALL DIMENSIONAL DATA AND SHALL VERIFY EXACT LOCATION AND MOUNTING HEIGHTS OF ALL OUTLETS WITH ARCHITECT AND/OR OWNER PRIOR TO INSTALLATION.

GROUNDING SHALL COMPLY WITH REQUIREMENTS OF ALL APPLICABLE CODES.

ALL MATERIALS USED SHALL BE NEW AND BEAR THE U/L LABEL AND BE OF THE APPROPRIATE NEMA STANDARD.

THIS CONTRACTOR SHALL ALLOW IN HIS INITIAL BID THE COST OF SERVICES ON ALL EQUIPMENT INSTALLED UNDER HIS CONTRACT FOR A PERIOD OF ONE (I) YEAR FROM DATE OF FINAL ACCEPTANCE OF THE WORK.

LAYOUT IS DIAGRAMMATIC AND WORK SHALL BE INSTALLED TO MEET FIELD CONDITIONS AND EQUIPMENT SELECTED. PROVIDE SHOP DRAWINGS AS REQUIRED AND VERIFY ALL EQUIPMENT.

PANELBOARDS SHALL BE DEAD FRONT WITH BOLT-ON TYPE CIRCUIT BREAKERS W/CU BUS. A TYPED LEGEND, UNDER A CLEAR PLEXAN-GLASS SHALL BE PROVIDED FOR CIRCUIT IDENTIFICATION.

CONTRACTOR SHALL INCLUDE ALL MISCELLANEOUS ITEMS REQUIRED TO COMPLETE THE WORK.

CONTRACTOR SHALL OBTAIN AND PAY FOR ALL PERMITS AND REQUIRED INSPECTION FEES.

IT SHALL BE THE RESPONSIBILITY OF THIS CONTRACTOR TO COORDINATE AND REVIEW THE ELECTRICAL CHARACTERISTICS, AMPACITY AND OTHER REQUIREMENTS OF ALL EQUIPMENT PRIOR TO INSTALLATION.

IT SHALL BE THE RESPONSIBILITY OF THIS CONTRACTOR TO COORDINATE THE LOCATIONS OF CONDUIT ROUTING, EQUIPMENT, LIGHTING, ETC. WITH ALL OTHER TRADES IN THE FIELD PRIOR TO INSTALLATION.

THE ENTIRE INSTALLATION OF ALL COMPONENTS OF THIS PROJECT SHALL COMPLY WITH ALL FEDERAL ADA REQUIREMENTS. VERIFY EXACT LOCATIONS AND HEIGHTS OF ALL FIXTURES AND OUTLETS BEFORE INSTALLATION TO INSURE COMPLIANCE WITH FEDERAL REGULATIONS.

FOR CLARITY OF ALL PLANS, SOME CONDUIT AND WIRE HAS NOT BEEN SHOWN. IT IS THE RESPONSIBILITY OF THIS CONTRACTOR TO FURNISH AND INSTALL COMPLETE AND OPERATING SYSTEMS INCLUDING ALL CONDUIT AND WIRING.

FOR ALL NIGHT LIGHTING, EXIT SIGNS AND BATTERY POWERED EMERGENCY LIGHTING CIRCUITS, THIS CONTRACTOR SHALL USE #10 AWG FOR THE ENTIRE CIRCUIT LENGTH UNLESS INDICATED OTHERWISE.

THIS CONTRACTOR SHALL MAINTAIN THE FIRE RATED INTEGRITY OF ALL FLOORS, CEILINGS AND WALLS. ALL PENETRATIONS THROUGH FIRE RATED BUILDING ELEMENTS SHALL BE EFFECTIVELY SEALED USING APPROVED MATERIALS AND METHODS. ALL LIGHTING FIXTURES MOUNTED IN FIRE RATED CEILINGS SHALL MAINTAIN THE INTEGRITY OF THE FIRE RATED CEILINGS USING APPROVED MATERIALS AND METHODS. REFER TO ARCHITECTURAL DRAWINGS FOR FIRE RATINGS.

THIS CONTRACTOR SHALL INSPECT THE COMPLETE SET OF DRAWINGS AND SPECIFICATIONS TO DETERMINE HIS ENTIRE SCOPE OF WORK. THIS CONTRACTOR SHALL VISIT THE SITE AND BECOME FAMILIAR WITH THE EXISTING CONDITIONS AND EXTENT OF DEMOLITION AND NEW WORK FOR THIS PROJECT PRIOR TO SUBMITTING HIS BID.

THE ELECTRICAL INSTALLATION IS TO BE IN STRICT ACCORDANCE WITH THE APPLICABLE RULES AND REGULATIONS OF ALL LOCAL, STATE AND FEDERAL ELECTRICAL CODES AND THE LOCAL UTILITY COMPANY REQUIREMENTS OR ANY OTHER AUTHORITIES HAVING LAWFUL JURISDICTION.

ALL SITE UNDERGROUND BRANCH CIRCUIT WIRING IN CONDUIT SHALL BE TYPE THWN OR XHHW.

ALL EXPOSED TO THE WEATHER CONDUIT SHALL BE HEAVYWALL, GALVANIZED RIGID STEEL 'RGS' OR INTERMEDIATE METAL CONDUIT 'IMC', MINIMUM SIZE 3/4".

ALL UNDERFLOOR, UNDERGROUND CONDUIT SHALL BE SCHEDULE 40 PVC, MINIMUM SIZE 3/4". PVC CONDUIT ROUTED UNDERFLOOR, UNDERGROUND SHALL BE TRANSITION TO HEAVYWALL GALVANIZED RIGID STEEL 'RGS' OR INTERMEDIATE METAL CONDUIT 'IMC' PRIOR TO GRADE.

ALL WIRE SHALL BE INSTALLED IN THINWALL, ELECTRICAL METALLIC TUBING (EMT) CONDUIT UNLESS OTHERWISE NOTED. MINIMUM SIZE SHALL BE 3/4" FOR BRANCH CIRCUIT WIRING, DROPS TO SWITCHES AND BRANCH DEVICES MAY BE 1/2" UNLESS OTHERWISE NOTED ON DRAWINGS. ALL THINWALL FITTINGS SHALL BE OF THE STEEL COMPRESSION GLAND TYPE PER ALL APPLICABLE CODE REQUIREMENTS. ALL CONDUITS SHALL BE CONCEALED WHERE POSSIBLE, WHERE EXPOSED, THIS CONTRACTOR SHALL RUN CONDUITS IN STRAIGHT LINES PARALLEL AND/OR PERPENDICULAR TO THE BUILDING CONSTRUCTION. CONDUITS INSTALLED IN AREAS SUBJECT TO MECHANICAL DAMAGE SHALL BE RIGID GALVANIZED, OR INTERMEDIATE METAL TYPE.

THIS CONTRACTOR SHALL PROVIDE ALL TEMPORARY WIRING FOR ALL TRADES FOR CONSTRUCTION EQUIPMENT (ie: HANDTOOLS, WELDERS, PIPE BENDERS, ETC.) AND CONSTRUCTION LIGHTING PER THE LATEST OSHA STANDARDS. INCLUDE ALL COSTS IN THE BASE BID. THIS CONTRACTOR SHALL ESTABLISH SAFE WORKING PROCEDURES FOR THE PROTECTION OF THE WORKMEN IN ALL PHASES OF WORK, COMPLYING WITH THE APPLICABLE PROVISIONS OF ALL CITY, STATE AND FEDERAL SAFETY LAWS (OSHA).

O

E

 \blacksquare

//

WG

LED LIGHT FIXTURE. CAPITAL LETTER DENOTES FIXTURE TYPE, NUMERAL INDICATES CIRCUIT ASSIGNMENT, SUBSCRIPT LETTER DENOTES SWITCH LEG. SHADING OF ANY FIXTURE INDICATES CIRCUITED TO UNSWITCHED NIGHT LIGHT CIRCUIT. SEE "LIGHTING FIXTURE SCHEDULE."

EXIT SIGN UNIVERSAL MOUNT SHADED AREA INDICATES FACE, ARROWS AS REQUIRED. SEE "LIGHTING FIXTURE SCHEDULE."

INDICATED.

LIGHTING FIXTURE OUTLET - SEE "LIGHTING FIXTURE SCHEDULE"

FUSED DISCONNECT SWITCH, SWITCH AND FUSE RATING AS

NON FUSED SAFETY SWITCH, RATING AS INDICATED

3-PHASE COMBINATION MAGNETIC STARTER WITH NEMA SIZE INDICATED BY E.C.

ISOLATED GROUND DUPLEX RECEPTACLE, NEMA 5-20R, I5"A.F.F. U.N.O.

SINGLE RECEPTACLE, NEMA 5-20, 15" A.F.F. U.N.O.

DUPLEX RECEPTACLE, NEMA 5-20R, 15"A.F.F. U.N.O.

DUPLEX RECEPTACLE, NEMA 5-20R, CROSS LINE DENOTES 6" ABOVE COUNTER OR BACKSPLASH U.N.O.

DUPLEX RECEPTACLE, NEMA 5-20R, SHADING DENOTES GROUND FAULT CIRCUIT INTERRUPTER "GFCI"., 15"A.F.F. U.N.O.

DOUBLE DUPLEX RECEPTACLE, NEMA 5-20R, 15"A.F.F. U.N.O.

DUPLEX RECEPTACLE, NEMA 5-20R, SHADING DENOTES GROUND FAULT CIRCUIT INTERRUPTER "GFCI", CROSS LINE DENOTES 6" ABOVE COUNTER OR BACKSPLASH U.N.O.

DOUBLE DUPLEX RECEPTACLE, NEMA 5-20R, SHADING DENOTES GROUND FAULT CIRCUIT INTERRUPTER "GFCI", 15"A.F.F. U.N.O.

DUPLEX RECEPTACLE W 2 USB PORTS, NEMA 5-20R, 15"A.F.F. U.N.O.

DUPLEX RECEPTACLE W/ 2 USB PORTS, NEMA 5-20R, CROSS LINE DENOTES 6" ABOVE COUNTER OR BACKSPLASH U.N.O.

SPECIAL PURPOSE RECEPTACLE NEMA CONFIGURATION AS REQUIRED BY MANUFACTURERS EQUIPMENT. VERIFY CONDUIT, CONDUCTOR AND DISCONNECT/CIRCUIT BREAKER REQUIREMENTS PRIOR TO ROUGH-IN.

LIGHTING AND/OR POWER PANEL

MOTOR

PHOTO ELECTRIC CONTROL, ROOF MOUNTED, (FACE NORTH) 120Y OPERATION, 20A RATED TIED TO LIGHTING RELAY PANEL (LRP); ACUITY #PCELL-2MO-BB

CONDUIT ROUTED CONCEALED IN CEILING OR WALL CONSTRUCTION. (CROSS LINES DENOTE NUMBER OF WIRES.) CONDUIT ROUTED EXPOSED, PARALLEL OR PERPENDICULAR

TO WALLS. CONDUIT ROUTED CONCEALED IN CONCRETE FLOOR SLAB

J AUXILIARY JUNCTION BOX

OR UNDERGROUND.

FLEXIBLE CONDUIT CONNECTION

HOME RUN TO PANELBOARD CONDUIT

- PHASE CONDUCTORS NEUTRAL CONDUCTOR EQUIPMENT GROUND ISOLATED GROUND

WEATHER PROOF (NEMA 3R)

F.B.O. FURNISHED BY OTHERS

DENOTES 6" ABOVE COUNTER OR BACKSPLASH U.N.O.

UNLESS NOTED OTHERWISE U.N.O.

ABOVE FINISH FLOOR A.F.F.

> 2-GANG RECESSED FLOOR-BOX / POKE-THRU DEVICE. VERIFY EXACT DEVICE IN FIELD. MOUNTED FLUSH IN FLOOR. PROVIDE SEPARATE CONDUIT STUBS FOR POWER AND DATA (I")

CABLING. COVER ASSEMBLY AND DEVICES AS INDICATED.

WIRE GUARD BY SAFETY TECHNOLOGY INTERNATIONAL, INC

COVER FINISH TO BE SELECTED BY ARCHITECT. LEGRAND EVOLUTION 6" SERIES

ELECTRICAL SYMBOLS

WALL TELEPHONE OUTLET (48"AFF) WITH I" CONDUIT

TELEPHONE OUTLET, WITH I" CONDUIT

DATA SYSTEM OUTLET WITH I" CONDUIT

TY OUTLET, WITH I" CONDUIT

SINGLE POLE TOGGLE SWITCH, 48"AFF, SUBSCRIPT LETTER

DENOTES SWITCH LEG, 20 AMP, 120 VOLT

MANUAL SINGLE PHASE MOTOR STARTER WITH THERMAL OVERLOAD PROTECTION. "P" DENOTES DEVICE FURNISHED WITH PILOT LIGHT., 48"AFF UNLESS INDICATED OTHERWISE

SINGLE POLE PILOT LIGHT SWITCH, 48"AFF, PILOT LIGHT ON WHEN DEVICE IS TURNED ON, 20 AMP, 120 YOLT

THREE WAY TOGGLE SWITCH, 48"AFF, 20AMP, 120VOLT.

FAN SPEED SWITCH; 48"AFF

MOMENTARY CONTACT SWITCH 48"A.F.F.

WALL MOUNTED OCCUPANCY SENSOR SWITCH (AUTO ON / AUTO OFF) 48"A.F.F. ACUITY #WSX-PDT-XX

, VS WALL MOUNTED VACANCY SENSOR SWITCH (MANUAL ON / AUTO OFF) 48"A.F.F. ACUITY #WSX-PDT-SA-XX

, DVS WALL MOUNTED VACANCY SENSOR DIMMER SWITCH (MANUAL ON / AUTO OFF) 48"A.F.F. ACUITY #MSX-PDT-D-SA-XX

ACUITY #NPODM-XX

 $_{\downarrow}^{ extsf{LVD}}$ nLIGHT (ON/OFF + RAISE/LOWER) SWITCH; 48"A.F.F. ACUITY #NPODM-DX-XX

^{LVSC} nLIGHT SCENE CONTROLLER (ON/OFF + RAISE/LOWER) SMITCH; 48"A.F.F. ACUITY #NPODM-45B-DX-WH

nLIGHT O-IOV POWER PACK; ACUITY #NPPI6-D

nLIGHT ELY POWER PACK; ACUITY #NSP5-PCD

NLIGHT CEILING MOUNTED ULTRASONIC/ PASSIVE INFRARED OCCUPANCY SENSOR; ACUITY #nCM-PDT-10-RJB

nLIGHT CEILING MOUNTED ULTRASONIC/ PASSIVE INFRARED VACANCY SENSOR; ACUITY #nCM-PDT-10-RJB

BRANCH WIRING NOTES


PROVIDE THE FOLLOWING MINIMUM WIRE SIZE TO THE FIRST OUTLET OF A 15 OR 20 AMPERE BRANCH CIRCUIT. PROVIDE MINIMUM #10AMG TO THE LAST OUTLET FOR ALL

DISTANCE UP TO 100 FEET 100 TO 200 FEET

BRANCH CIRCUITS MORE THAN 200 FEET IN LENGTH. AMG WIRE SIZES

MORE THAN 200 FEET #8 MINIMUM PROVIDE MINIMUM AWG CONDUCTOR SIZES FOR GENERAL BRANCH CIRCUITING AS FOLLOWS. WHERE APPLICABLE INCREASE AS REQUIRED TO ACCOMMODATE VOLTAGE

OVERCURRENT CU AMG OVERCURRENT CU AMG PROTECTION <u>WIRE SIZE</u> <u> WIRE SIZE</u> <u>PROTECTION</u> 15/20 AMPERE 60 AMPERE 25/30 AMPERE 70/80 AMPERE 90 AMPERE 40 AMPERE 50 AMPERE 100 AMPERE

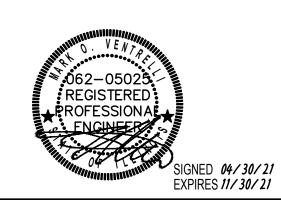





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*0*3.01.2022 B evision 2 revision 3: evision 4:

> **ELECTRICAL SPEC** SYMBOLS + NOTES