

GENERAL NOTES

- ALL CONTRACTORS AND SUBCONTRACTORS WILL THOROUGHLY FAMILIARIZE THEMSELVES WITH THESE CONSTRUCTION DOCUMENTS AND WILL VERIFY EXISTING SITE AND CONDITIONS PRIOR TO SUBMITTING A BID. ALL SUBCONTRACTORS WILL PROVIDE ALL LABOR, SUPERVISION, AND MATERIALS OF EVERY TYPE WHICH MAY BE NECESSARY FOR A SUCCESSFUL COMPLETION. ALL WORK TO BE PERFORMED IN A GOOD AND WORKMANLIKE MANNER ACCORDING TO THE TRUE INTENT AND MEANING OF THE DRAWINGS AND SPECIFICATIONS.
- THIS ARCHITECT AND HIS PROFESSIONAL CONSULTANTS WILL NOT HAVE CONTROL, OF AND WILL NOT BE RESPONSIBLE FOR, CONSTRUCTION MEANS, METHODS, TECHNIQUES, SEQUENCES, PROCEDURES, OR SAFETY PRECAUTIONS AND PROGRAMS IN CONNECTION WITH THE WORK ON THIS PROJECT OR FOR THE ACTS OR OMISSIONS OF THE CONTRACTOR, SUBCONTRACTOR, OR ANY OTHER PERSONS PERFORMING ANY OF THE WORK ON THIS SITE, NOR FOR THE FAILURE OF ANY OF THEM TO CARRY OUT THE WORK IN ACCORDANCE WITH THE INTENT OF THE CONTRACT AND OR CONSTRUCTION DOCUMENTS.
- ALL CONTRACTORS WILL PROVIDE ADEQUATE BRACING AND/OR SHORING TO INSURE STRUCTURAL STABILITY OF THE BUILDING AND ALL RELATED BUILDING COMPONENTS IE, STRUCTURAL WALLS, INTERIOR WALL ASSEMBLIES, ETC. DURING THE CONSTRUCTION PHASE OF THIS PROJECT.
- WORK WILL BE COORDINATED WITH ALL TRADES IN ORDER TO AVOID INTERFERENCE, AND AVOID OMISSIONS.
- ALL MATERIALS USED WILL BE NEW AND BEAR U.L. LABELS WHERE REQUIRED AND MEET APPROPRIATE N.E.M.A. STANDARDS.
- LAYOUT ALL PARTITIONS BEFORE BEGINNING CONSTRUCTION TO PREVENT ERRORS BY DISCREPANCY. ALL DRYWALL PARTITIONS WILL BE INSTALLED AS NOTED ON THE DRAWINGS.
- EACH SUBCONTRACTOR WILL AMEND AND MAKE GOOD AT HIS OWN COST, ANY DEFECTS OR OTHER FAULTS IN HIS WORKMANSHIP AND/OR HIS SUPPLIED MATERIALS.
- ALL CONTRACTORS WILL GUARANTEE ALL LABOR AND MATERIALS FOR A PERIOD OF ONE YEAR FROM DATE OF OCCUPANCY.
- VERIFY ALL DIMENSIONS IN THE FIELD PRIOR TO ORDERING, CUTTING AND/OR INSTALLING MATERIAL OR EQUIPMENT. IN THE EVENT OF ANY DISCREPANCIES, CONTACT THE CONSTRUCTION MANAGER OR OWNER BEFORE PROCEEDING WITH THAT WORK.
- ALL SUBCONTRACTORS WILL PROVIDE A CERTIFICATE OF INSURANCE TO THE GENERAL CONTRACTOR PRIOR TO STARTING ANY WORK ON THIS PROJECT. CERTIFICATE OF INSURANCE CANNOT BE TERMINATED OR CANCELED WITHOUT 10 DAYS PRIOR WRITTEN NOTICE TO THE OWNER.
- ANY ADDITIONS OR CHANGES TO WORK MUST BE AUTHORIZED IN WRITING BY THE CONSTRUCTION MANAGER OR OWNER. NO ALTERATIONS WILL BE MADE ON THIS PROJECT EXCEPT UPON WRITTEN ORDER BY THE CONSTRUCTION MANAGER.
- NO SUBSTITUTIONS OF ANY KIND FOR MATERIALS SPECIFIED ON THESE CONSTRUCTION DOCUMENTS IS ALLOWED. NO "EQUIVALENT" SUBSTITUTIONS WILL BE MADE, UNLESS DUE TO THE LACK OF AVAILABILITY OF THE ORIGINAL MATERIAL SPECIFIED AND APPROVED IN WRITING BY CLIENT.
- WEATHER CONDITIONS: CONTRACTORS WILL PROTECT ALL PARTS OF THEIR WORK FROM WEATHER DAMAGE DUE TO FROST, RAIN, HEAT, ETC. AND WILL MAKE GOOD TO THE SATISFACTION OF THE CONSTRUCTION MANAGER AND/OR GENERAL CONTRACTOR ANY PORTION OF THE WORK WHICH MAY HAVE BECOME DAMAGED.
- RESPONSIBILITY OF CONTRACTOR: EACH SUBCONTRACTOR IS RESPONSIBLE FOR WORKMANSHIP AND MATERIALS. EACH SUBCONTRACTOR IS RESPONSIBLE FOR THE CARE AND PROTECTION OF HIS OWN WORK AND MATERIALS.
- SITE SAFETY: EACH CONTRACTOR WILL ABIDE BY LOCAL AREA STANDARDS AND RELATED OSHA STANDARDS FOR THE PROTECTION AND SAFETY FOR THEIR EMPLOYEES ON SITE. THIS ARCHITECT AND HIS PROFESSIONAL CONSULTANTS WILL BE HELD HARMLESS BY THE OWNER, GENERAL CONTRACTOR AND RELATED AWARDED TRADES ON THIS PROJECT FOR ACCIDENTS OR INJURIES CAUSED OR ACCRUED ON THIS PROPERTY DURING THE PRE/ACTUAL/POST CONSTRUCTION PHASES OF THIS PROJECT.
- PILFERAGE: EACH CONTRACTOR WILL BE RESPONSIBLE FOR HIS OWN EQUIPMENT AND MATERIALS USED IN CONSTRUCTION INCLUDING THOSE ITEMS, FURNISHED BY THE OWNER, AND DELIVERED TO THE JOB SITE, TO BE INSTALLED BY THE CONTRACTOR. THE OWNER WILL NOT BE HELD LIABLE FOR STOLEN EQUIPMENT, MATERIALS OR DAMAGE OF THE SAME ON THIS JOB SITE.
- LIENS: ALL SUBCONTRACTORS AND THE GENERAL CONTRACTOR WILL DELIVER TO THE OWNER, A COMPLETE RELEASE OF ALL CLAIMS ARISING OUT OF THIS CONTRACT.
- GENERAL CONTRACTOR WILL BE RESPONSIBLE FOR REMOVAL OF DEBRIS ACCUMULATED BY EACH TRADE. HOWEVER, EACH TRADE WILL KEEP THE JOB SITE CLEAN AND SAFE AT ALL TIMES, ALONG WITH A BROOM FINISH AT THE END OF EACH WORKING DAY.
- SCHEDULE OF WORK: THE OWNER CONSTRUCTION MANAGER WILL COORDINATE WITH THE GENERAL CONTRACTOR DURING THE BIDDING PROCESS, THE REQUIRED NUMBER OF CALENDAR DAYS TO COMPLETE THIS WORK.

HOFFMAN ESTATES PARK DISTRICT - VOGELEI HOUSE

650 WEST HIGGINS ROAD

HOFFMAN ESTATES, IL 60169

DRAWING INDEX


GENERAL	
G001	COVER SHEET
G002	ACCESSIBILITY INFORMATION
SITE	
A001	SITE PLAN
A002	SITE RAMP DETAILS
A003	SITE RAMP DETAILS
DEMOLITION	
D101	BASEMENT DEMOLITION FLOOR PLAN
D102	FIRST FLOOR DEMOLITION PLAN
D103	SECOND FLOOR DEMOLITION PLAN
STRUCTURAL	
S-0.0	STRUCTURAL NOTES
S-0.1	STRUCTURAL NOTES
S-1.0	FOUNDATION PLAN
S-2.0	FIRST FLOOR FRAMING PLAN
S-2.1	SECOND FLOOR FRAMING PLAN
S-2.2	ROOF FRAMING PLAN
S-2.3	NORTH RAMP FOUNDATION AND FRAMING PLAN
S-3.0	FOUNDATION DETAILS
S-3.1	FOUNDATION DETAILS
S-4.0	FRAMING DETAILS
S-4.1	FRAMING DETAILS
ARCHITECTURAL	
A101	BASEMENT FLOOR PLAN
A102	FIRST FLOOR PLAN
A103	SECOND FLOOR PLAN
A121	BASEMENT REFLECTED CEILING PLAN
A122	FIRST FLOOR REFLECTED CEILING PLAN
A123	2ND FLOOR REFLECTED CEILING PLAN
A201	BUILDING ELEVATIONS
A202	BUILDING ELEVATIONS
A311	WALL SECTIONS
A701	ROOM FINISH SCHEDULE
A702	DOOR SCHEDULE AND ELEVATIONS
A703	WINDOW SCHEDULE AND ELEVATIONS
PLUMBING	
P1.1	PLUMBING PLANS
P2.1	PLUMBING NOTES, SYMBOLS, SPECIFICATIONS, AND DIAGRAMS
MECHANICAL	
MD1.1	MECHANICAL DEMO PLAN BASEMENT
MD1.2	MECHANICAL DEMO PLAN FIRST FLOOR
MD1.3	MECHANICAL DEMO PLAN SECOND FLOOR
M1.1	MECHANICAL NEW WORK PLAN BASEMENT
M1.2	MECHANICAL NEW WORK PLAN FIRST FLOOR
M1.3	MECHANICAL NEW WORK PLAN SECOND FLOOR
M2.1	MECHANICAL SCHEDULES, DETAILS, AND NOTES
ELECTRICAL	
ED1.1	ELECTRICAL DEMO PLAN BASEMENT
ED1.2	ELECTRICAL DEMO PLAN 1ST LEVEL
ED1.3	ELECTRICAL DEMO PLAN 2ND LEVEL
ED2.1	ELECTRICAL DEMO PLAN BASEMENT
ED2.2	ELECTRICAL DEMO PLAN 1ST LEVEL
ED2.3	ELECTRICAL DEMO PLAN 2ND LEVEL
E1.1	ELECTRICAL POWER PLAN BASEMENT
E1.2	ELECTRICAL POWER PLAN 1ST LEVEL
E1.3	ELECTRICAL POWER PLAN 2ND LEVEL
E2.1	ELECTRICAL LIGHTING PLAN BASEMENT
E2.2	ELECTRICAL LIGHTING PLAN 1ST LEVEL
E2.3	ELECTRICAL LIGHTING PLAN 2ND LEVEL
E3.1	ELECTRICAL SCHEDULES AND DETAILS
E3.2	ELECTRICAL SYMBOLS AND SPECS

NOTE: CIVIL DRAWINGS AND FIRE PROTECTION DRAWINGS ARE UNDER SEPARATE DRAWING SET.

PROJECT DIRECTORY

OWNER	STRUCTURAL ENGINEER
HOFFMAN ESTATES PARK DISTRICT DUSTIN HUGEN 1685 WEST HIGGINS ROAD HOFFMAN ESTATES, IL 60169 847-885-7500	THE W-T GROUP, LLC JEFFERY GUTOWSKY 2675 PRATUM AVENUE HOFFMAN ESTATES, IL 60192 224-293-6333
ARCHITECT	MECHANICAL, ELECTRICAL, AND PLUMBING ENGINEER
API ARCHITECTS 2675 PRATUM AVENUE HOFFMAN ESTATES, IL 60192	THE W-T GROUP, LLC MARK VENTRELLI 2675 PRATUM AVENUE HOFFMAN ESTATES, IL 60192 224-293-6333
CIVIL ENGINEER	
THE W-T GROUP, LLC TODD ABRAMS 2675 PRATUM AVENUE HOFFMAN ESTATES, IL 60192 224-293-6333	

LOCATION MAP

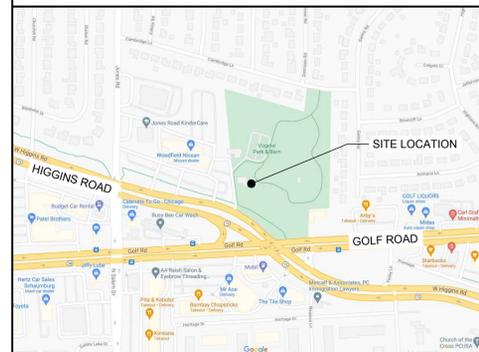

GENERAL BUILDING INFORMATION

HOFFMAN ESTATES ADOPTED CODES

2015	INTERNATIONAL BUILDING CODE
2015	INTERNATIONAL FIRE CODE
2015	INTERNATIONAL MECHANICAL CODE
2017	NATIONAL ELECTRICAL CODE
2014	ILLINOIS PLUMBING CODE
2018	ILLINOIS ACCESSIBILITY CODE
2019	ILLINOIS ENERGY CONSERVATION CODE

CURRENT HOFFMAN ESTATES ZONING ORDINANCE

BUILDING DATA

ZONING CLASSIFICATION:	B1
OCCUPANCY:	B
CONSTRUCTION TYPE:	IIIB
NUMBER OF STORIES:	2
BUILDING AREA:	4,967 SQ.FT.

STATEMENT OF COMPLIANCE

I HEREBY CERTIFY THAT THESE PLANS WERE PREPARED UNDER MY DIRECT SUPERVISION AND TO THE BEST OF MY PROFESSIONAL KNOWLEDGE THEY CONFORM TO THE LOCAL BUILDING CODES.

DATE: _____

KEN NADOLSKI
REGISTRATION NUMBER: 001022729
DATE OF EXPIRATION: NOVEMBER 30, 2022

SCOPE OF WORK

THIS IS A BUILDING REMODEL, WITH INTERIOR AND EXTERIOR SPACES BEING EFFECTED. THE INTERIOR WILL BE TURNED INTO OFFICE SPACE, AND LIMITED USE LIMITED APPLICATION ELEVATOR FROM BASEMENT TO SECOND FLOOR WILL BE ADDED. AROUND THE EXTERIOR, THREE RAMPS WILL BE ADDED TO EACH LEVEL OF THE BUILDING.




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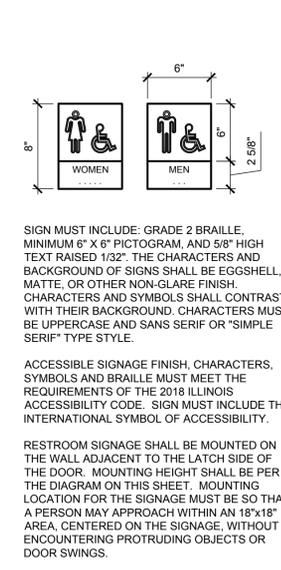
HOFFMAN ESTATES PARK DISTRICT - VOGELEI HOUSE REMODEL
650 WEST HIGGINS ROAD
HOFFMAN ESTATES, IL 60169

project no.	D2100051
date:	07.21.2021
revision 1:	08.27.2021
revision 2:	
revision 3:	
revision 4:	
checked:	CK
drawn:	JB


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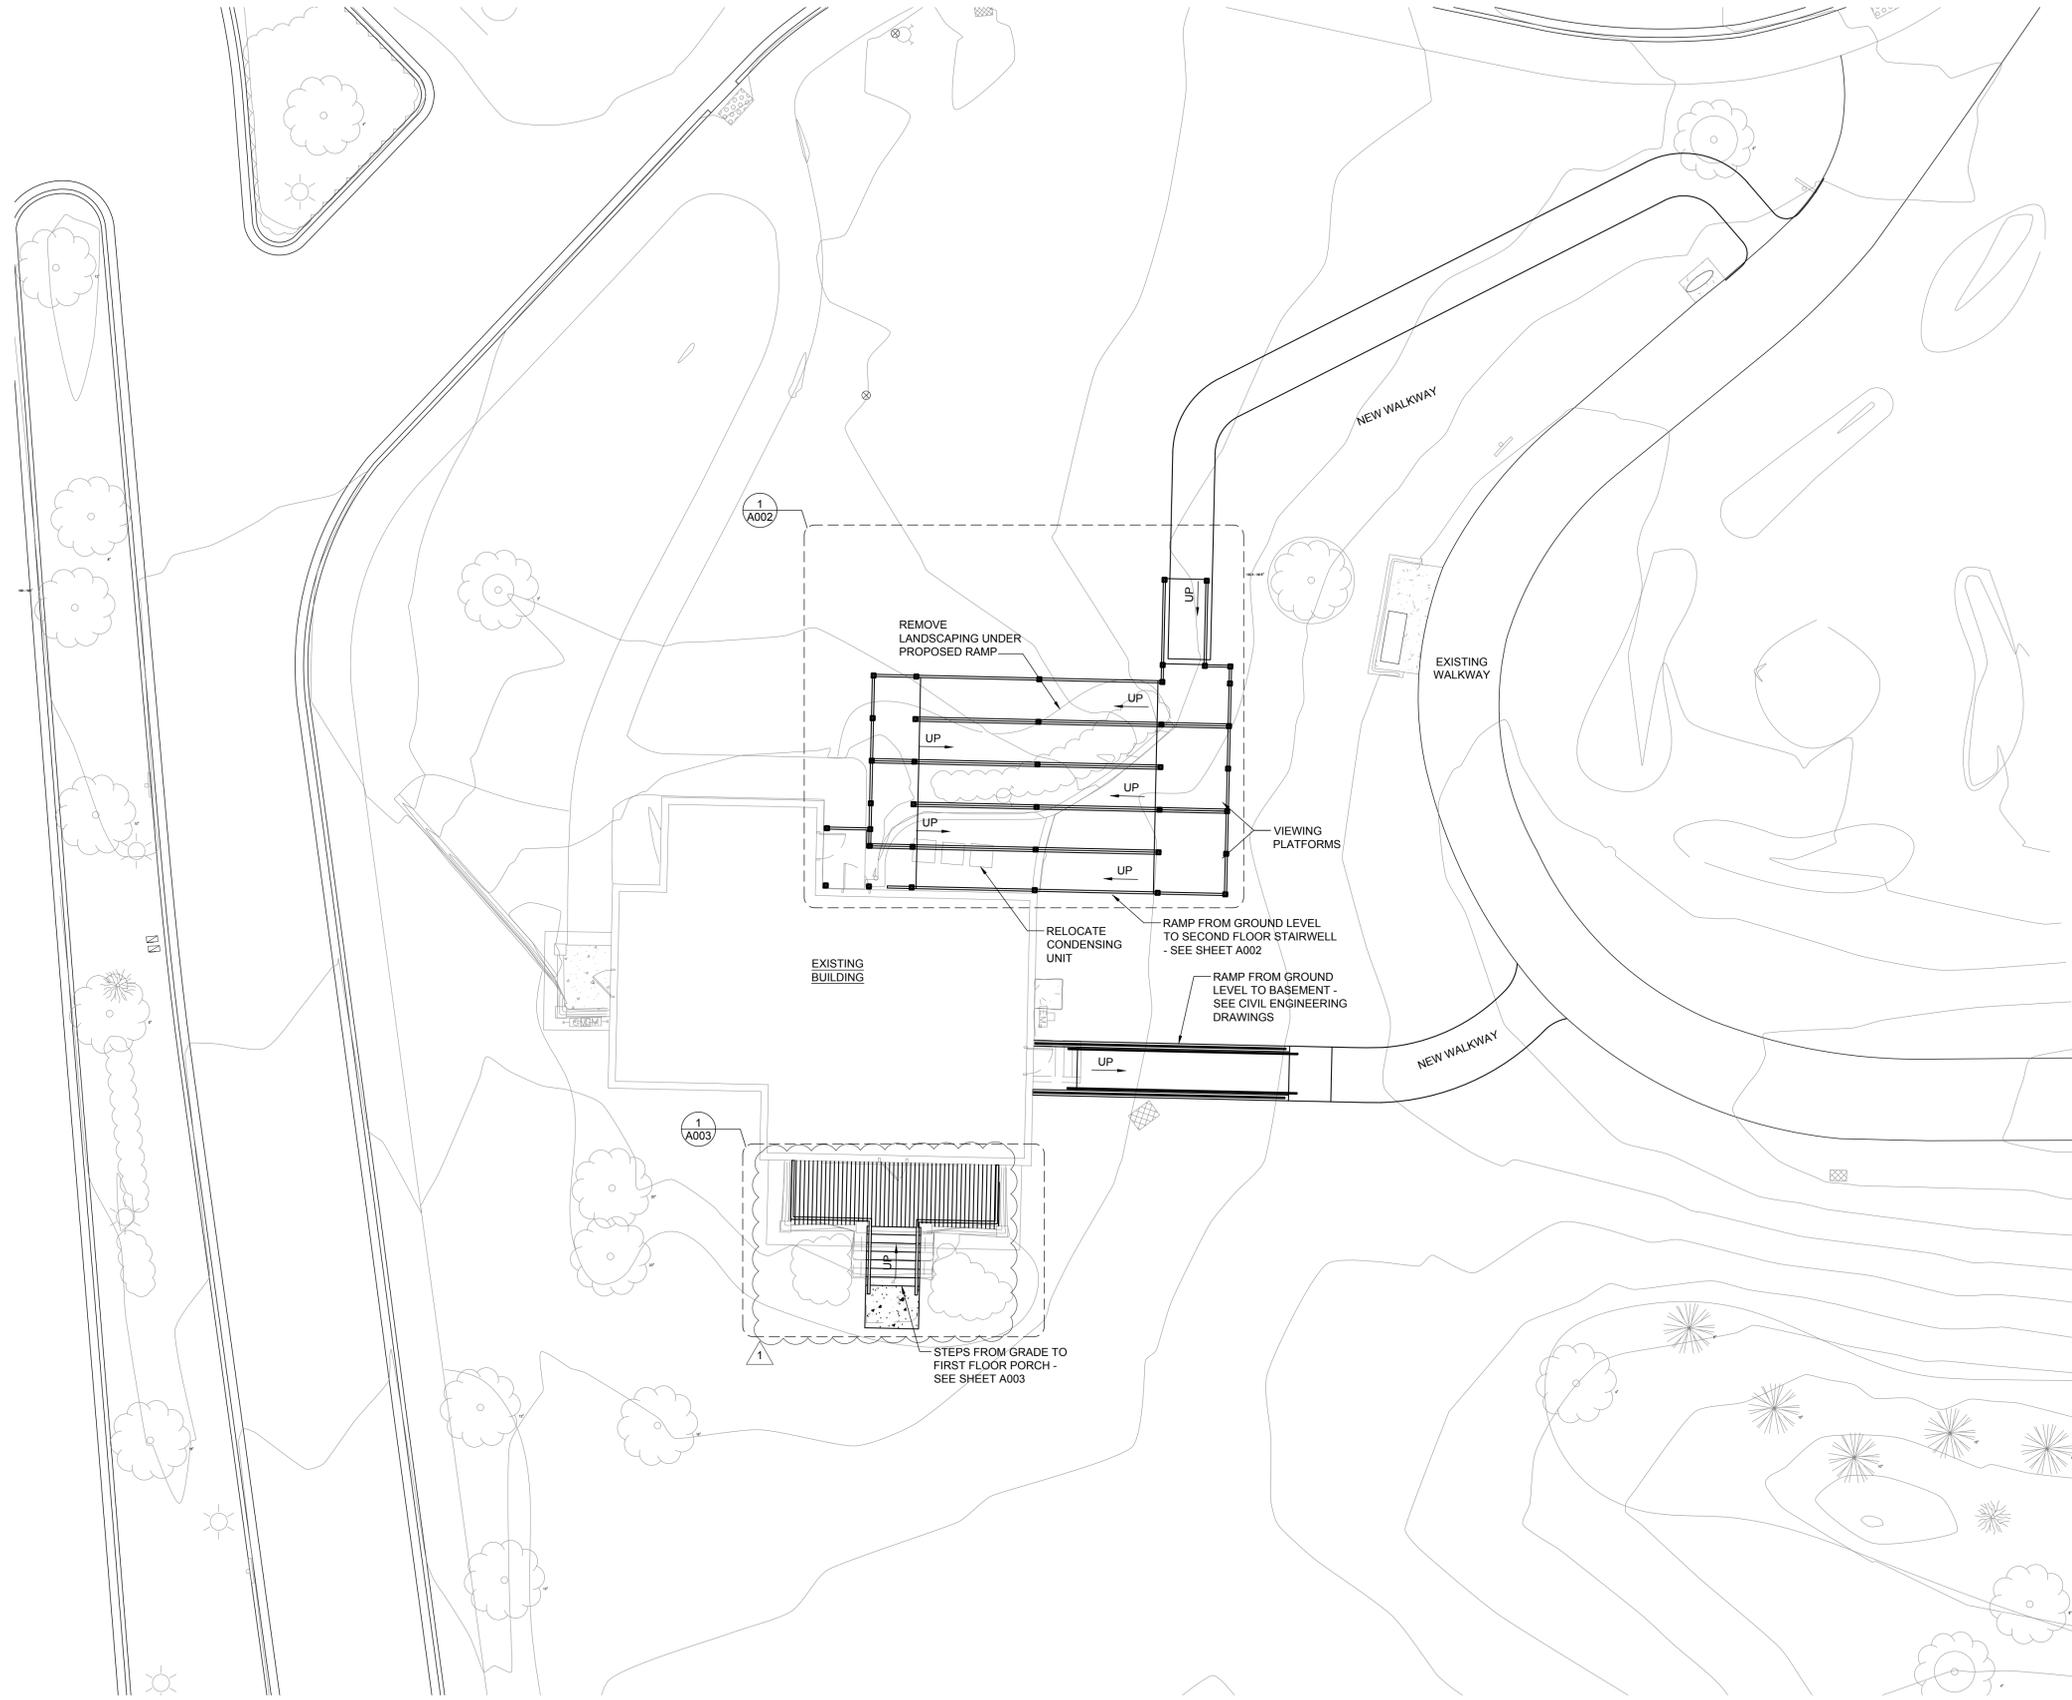
1 TYPICAL ACCESSORY MOUNTING HEIGHTS
SCALE: N.T.S.

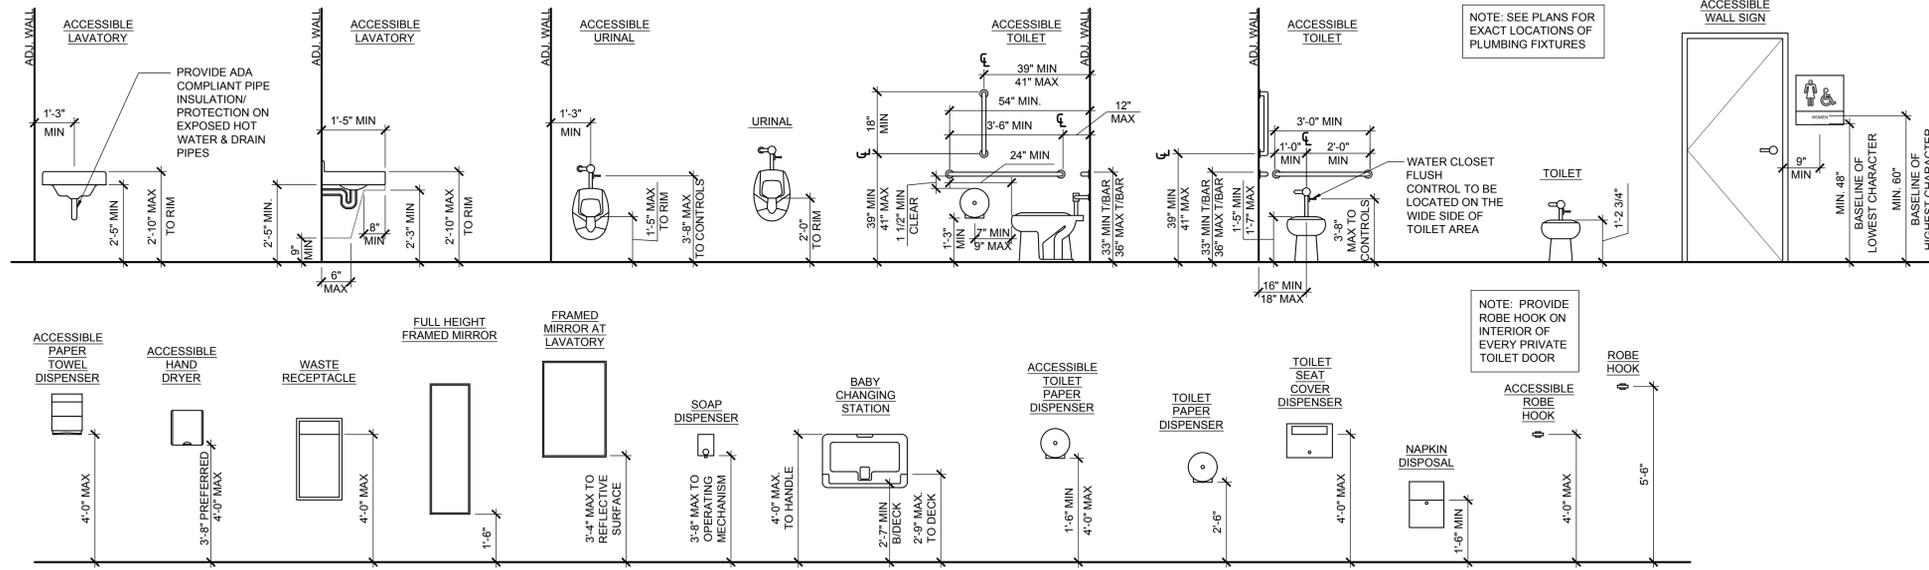

2 ACCESSIBLE SIGNAGE
SCALE: N.T.S.



3 ACCESSIBLE DOOR CLEARANCES
SCALE: N.T.S.

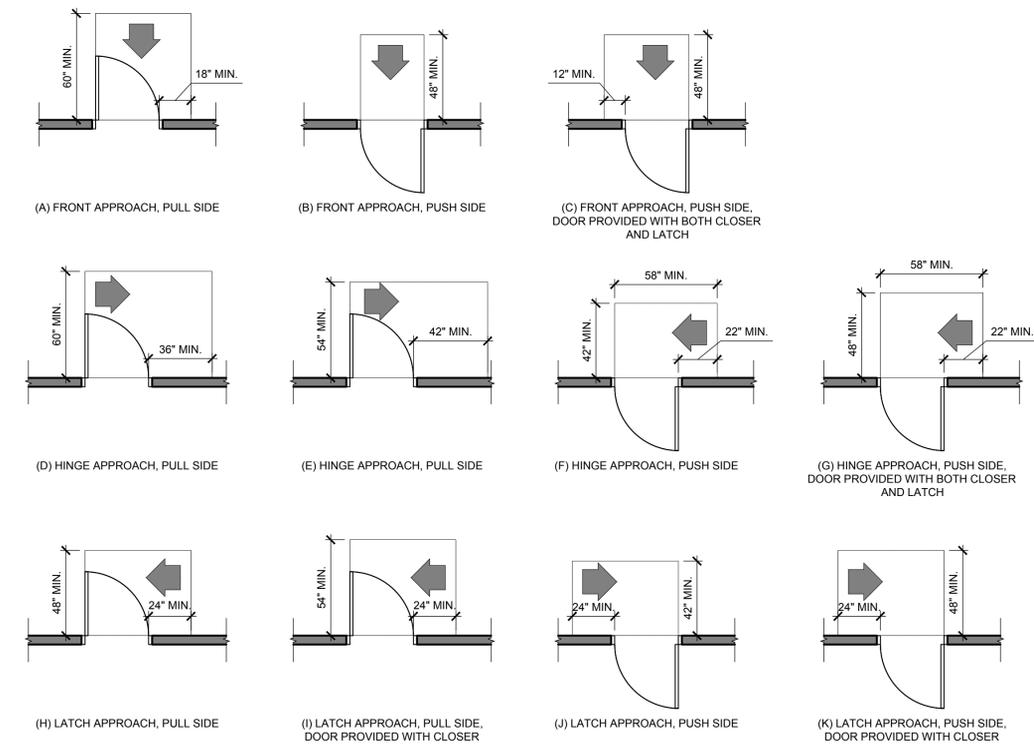

1 SITE PLAN
SCALE: 1" = 10'-0"



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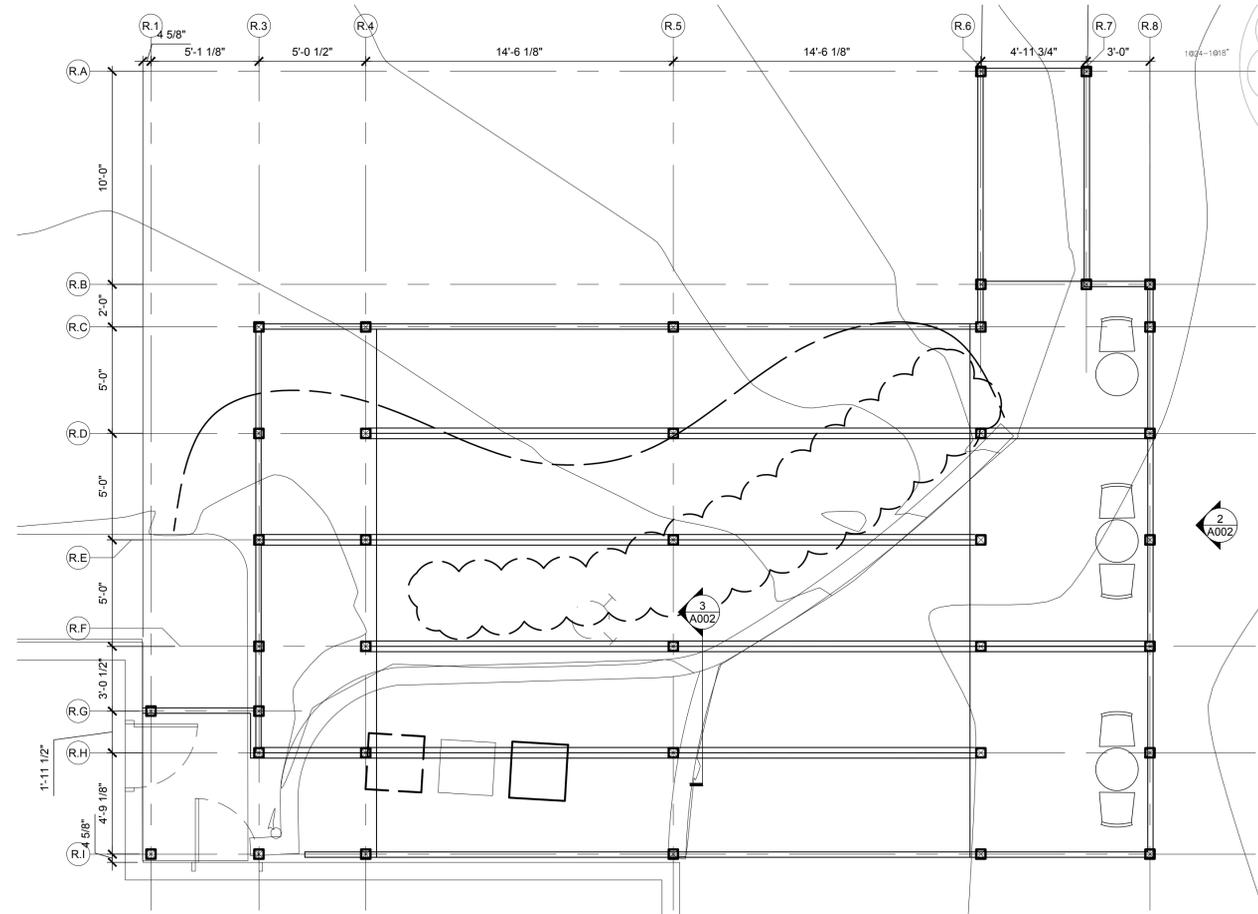
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project no. D2100051
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 revision 1: 08.27.2021
 revision 2:
 revision 3:
 revision 4:
 checked: C
 drawn: B


sheet title: **SITE PLAN**
 sheet number: **A001**

API ARCHITECTS
 5475 PARKWAY AVENUE
 HOFFMAN ESTATES, IL 60169
 OFFICE: 815.505.1342


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 Expires: November 30, 2025



1 RAMP SECTION
SCALE: 1/4" = 1'-0"

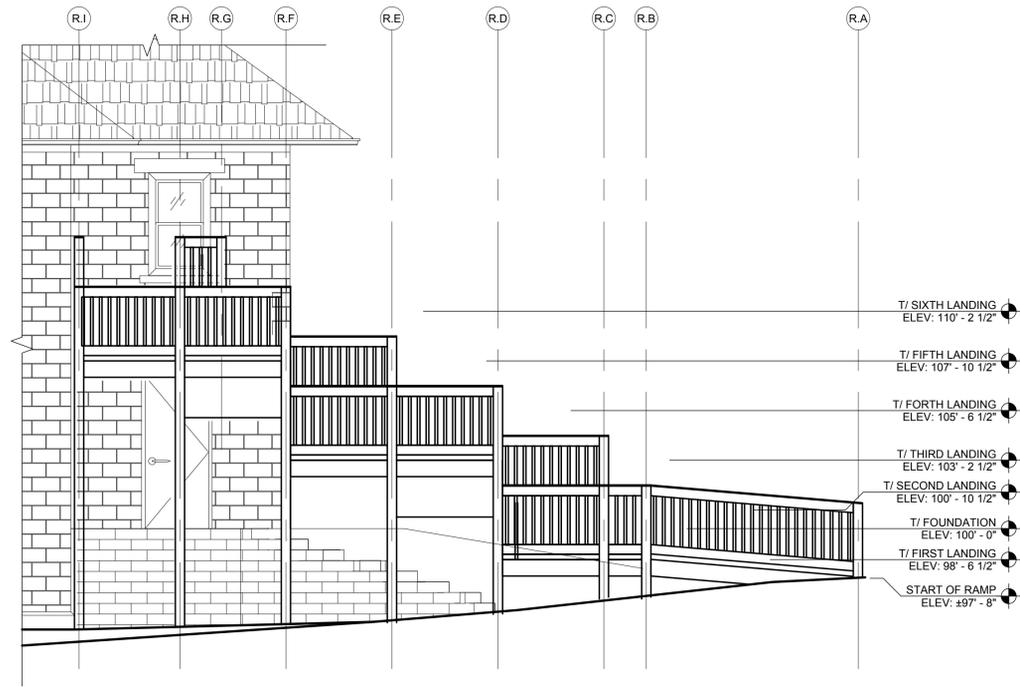


2 RAMP ELEVATION
SCALE: 1/4" = 1'-0"

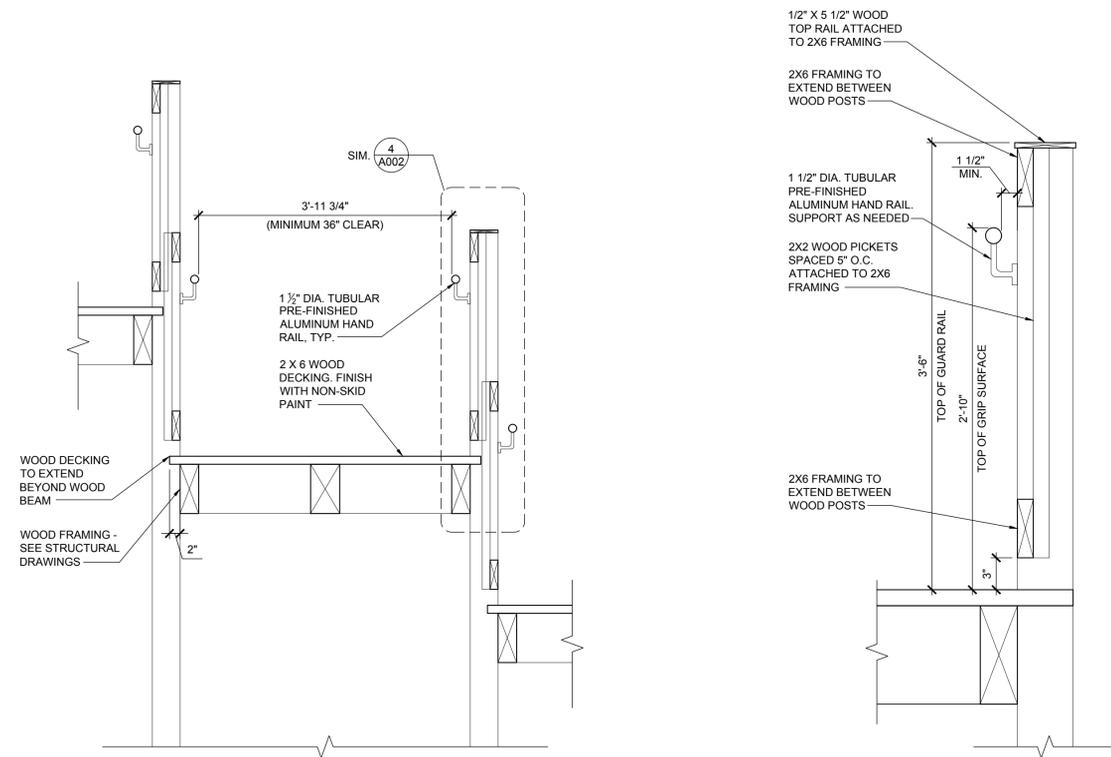


3 RAMP DETAIL
SCALE: 3/4" = 1'-0"


4 GUARD RAIL DETAIL
SCALE: 1 1/2" = 1'-0"

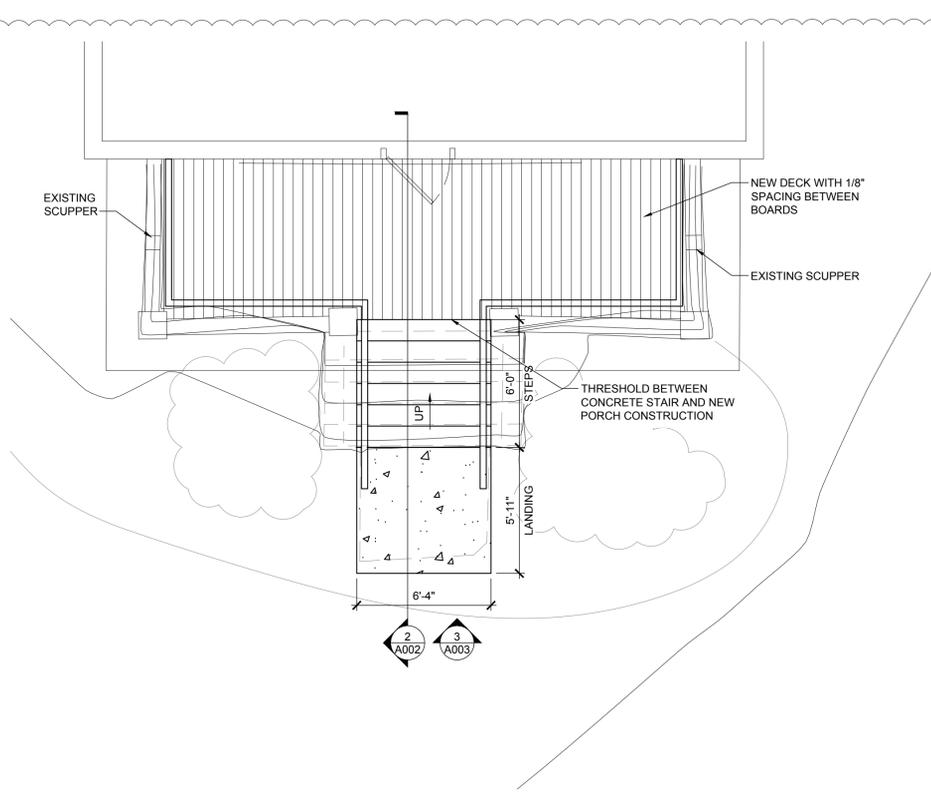

1 FRONT PORCH
SCALE: 1/4" = 1'-0"

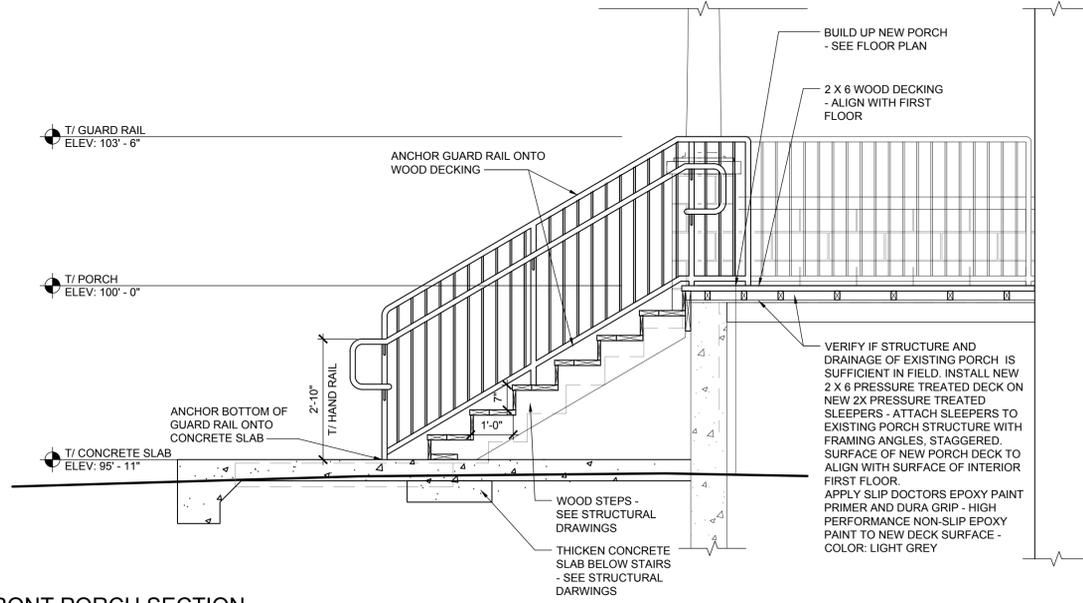


2 FRONT PORCH SECTION
SCALE: 1/2" = 1'-0"

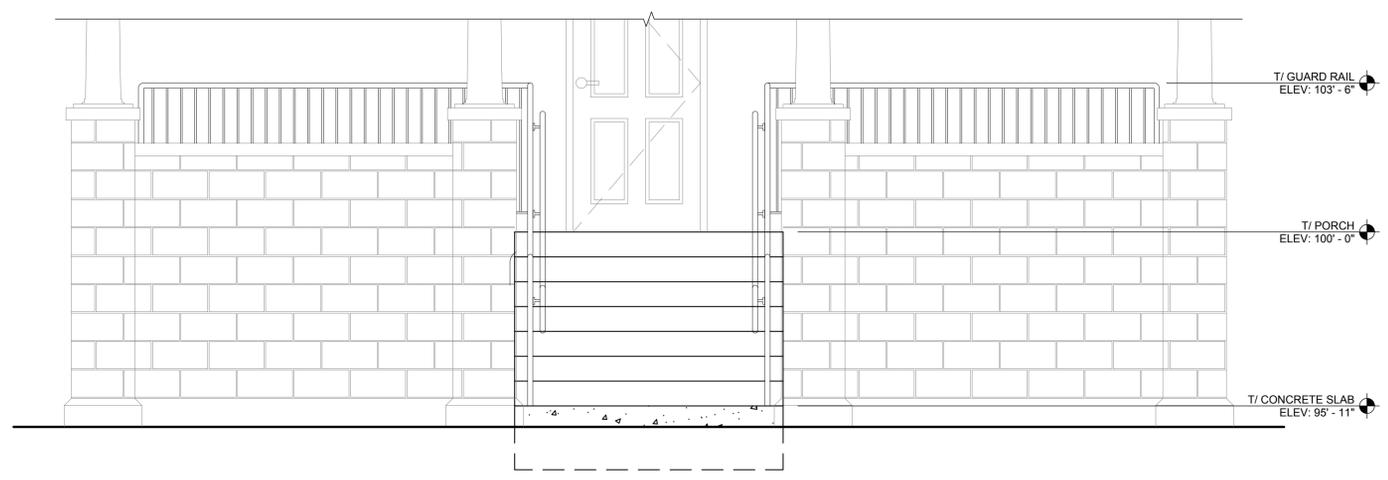

3 FRONT PORCH ELEVATION
SCALE: 1/2" = 1'-0"

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1 BASEMENT DEMOLITION FLOOR PLAN
SCALE: 1/4" = 1'-0"

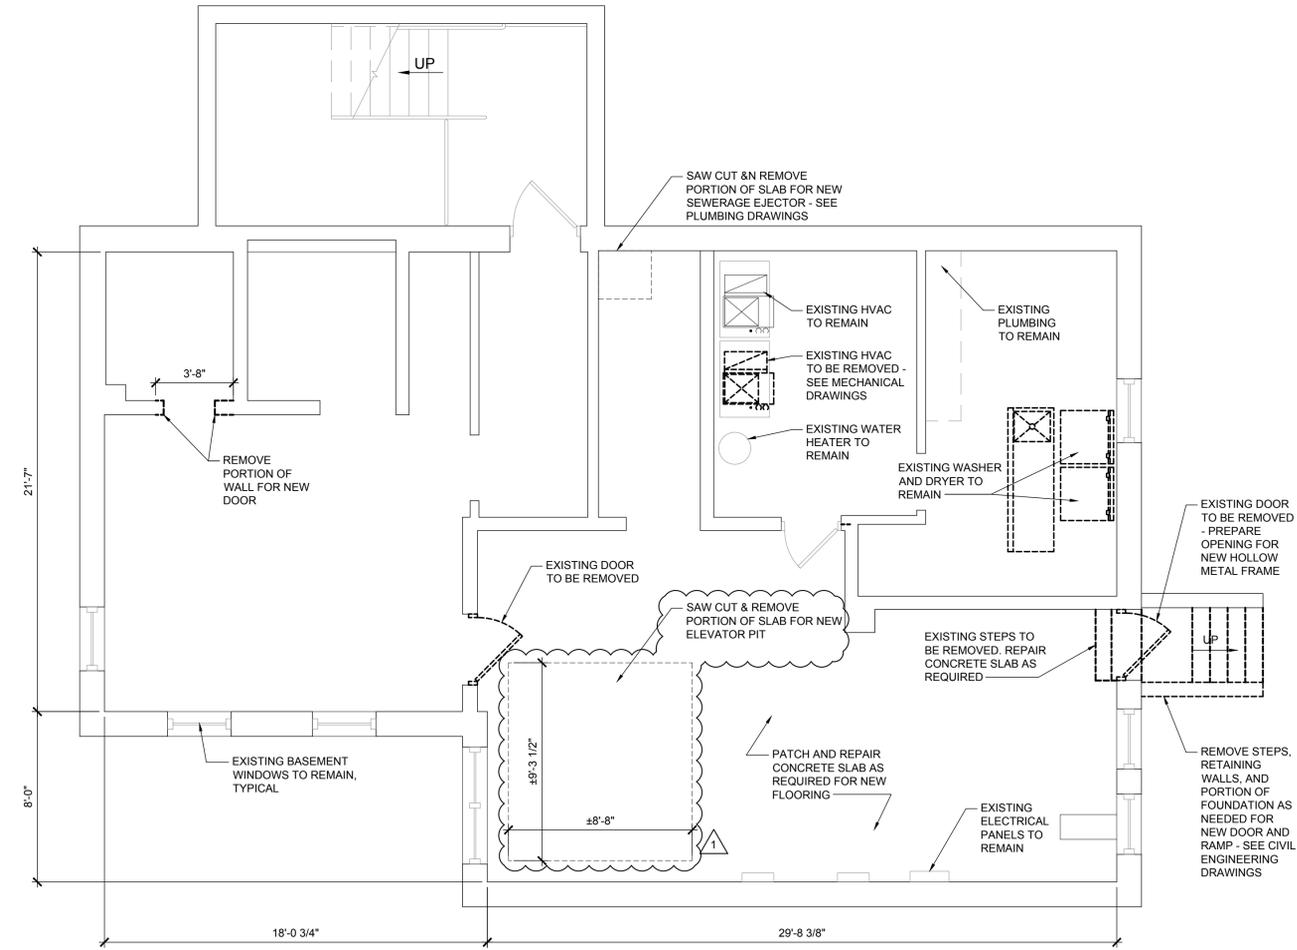

DEMOLITION GENERAL NOTES

- A. THIS PLAN INDICATES A GENERAL DEMOLITION SCOPE OF WORK TO BE PERFORMED AND DOES NOT RELIEVE THE CONTRACTOR FROM OTHER INCIDENTAL DEMOLITION WORK REQUIRED TO COMPLETE THE BUILDING MODIFICATIONS AS SHOWN AND REQUIRED BY THE CONTRACT DOCUMENTS.
- B. FIELD VERIFICATION OF DEMOLITION ITEMS AND DIMENSIONS SHALL BE THE RESPONSIBILITY OF THE CONTRACTOR. TO BE PERFORMED PRIOR TO COMMENCEMENT OF WORK. OWNER AND/OR ARCHITECT SHALL BE NOTIFIED IMMEDIATELY OF ANY DISCREPANCIES OR ERRORS WITH THIS DRAWING.
- C. CONTRACTOR SHALL PROVIDE ALL TEMPORARY BRACING AS REQUIRED TO MAINTAIN STRUCTURAL STABILITY OF THE EXISTING STRUCTURE DURING ALL PHASES OF CONSTRUCTION.
- D. SEQUENCING AND PHASING OF DEMOLITION AND CONSTRUCTION TO BE CONFIRMED WITH OWNER PRIOR TO START OF WORK.
- E. CONTRACTOR IS TO CLEAN UP AND REMOVE ALL DEMOLISHED MATERIALS FROM SITE. THE BUILDING AND EXTERIOR IS TO BE SWEEPED CLEAN DAILY FROM ALL DEMOLISHED MATERIALS.
- F. PROTECT ALL EXISTING WALLS, FLOORS, CEILINGS, EQUIPMENT, ETC., THAT ARE TO REMAIN, FROM DAMAGE DURING CONSTRUCTION.
- G. VERIFY ALL DIMENSIONS IN FIELD PRIOR TO START OF WORK.
- H. CONTRACTOR SHALL PROTECT ALL UTILITIES, I.E. SEWER, WATER, GAS LINES, ELECTRICAL CONDUITS, ETC. THAT ARE TO REMAIN AND SHALL PATCH AND REPAIR ALL ACCIDENTALLY DAMAGED ITEMS - TYPICAL THROUGH-OUT.
- I. CUTS TO THE CONCRETE FLOOR SLAB SHALL BE CLEANLY SAWCUT IN STRAIGHT/RECTILINEAR RUNS WITH NO OVERCUTS. REMOVE PORTIONS OF SLAB TO NEAREST EXISTING JOINT, AS APPROPRIATE. WHERE MULTIPLE AREAS OF SAWCUT/TRENCHING ARE SHOWN IN CLOSE PROXIMITY, CUTS MAY BE COMBINED.
- J. THROUGHOUT DURATION OF WORK, OPEN TRENCHES SHALL BE PROTECTED AND COVERED BY STEEL PLATES.
- K. WHERE ANY PLUMBING, MECHANICAL, REFRIGERATION OR ELECTRICAL ITEMS, LINES, FIXTURES, ETC. HAVE BEEN REMOVED, TERMINATE AND CAP PIPES, CONDUIT LINES, ETC. BELOW FINISH FLOOR, BEHIND FACE OF WALL, OR ABOVE CEILING. REMOVE ABANDONED WIRE BACK TO SOURCE. TERMINATIONS SHALL BE PERFORMED IN ACCORDANCE WITH APPLICABLE CODES.
- L. PRIOR TO AND DURING DEMOLITION CONTRACTOR SHALL MAINTAIN ALL LIFE SAFETY AND EXIT DEVICES AS REQUIRED BY CITY ORDINANCES. NOTIFY BUILDING OWNER PRIOR TO MOVING OR TAMPERING WITH DEVICES. PROTECT ALL SMOKE DETECTORS FROM CONSTRUCTION DUST AND DEBRIS.
- M. PROTECT ALL PUBLIC AREAS FROM CONSTRUCTION DEBRIS, DUST, ETC.
- N. ANY WALL BEING REMOVED SHALL BE CONFIRMED BY THE CONTRACTOR AS BEING NON-LOAD BEARING BEFORE PROCEEDING WITH REMOVAL. IF LOAD-BEARING WALL(S) ARE FOUND DURING CONSTRUCTION, IT SHOULD BE BROUGHT DIRECTLY TO THE OWNER'S PROJECT MANAGER'S ATTENTION BEFORE PROCEEDING WITH THE REMOVAL OF THAT WALL.
- O. RETAIN ALL REMOVED EQUIPMENT AND FIXTURES FOR REUSE. COORDINATE WITH OWNER.

DEMOLITION LEGEND

- BUILDING ELEMENTS TO BE REMOVED.
- DASHED ITEMS INDICATED ON THIS PLAN REPRESENT ARCHITECTURAL ITEMS REMOVED OR REMOVED AND RELOCATED UNLESS OTHERWISE NOTED.



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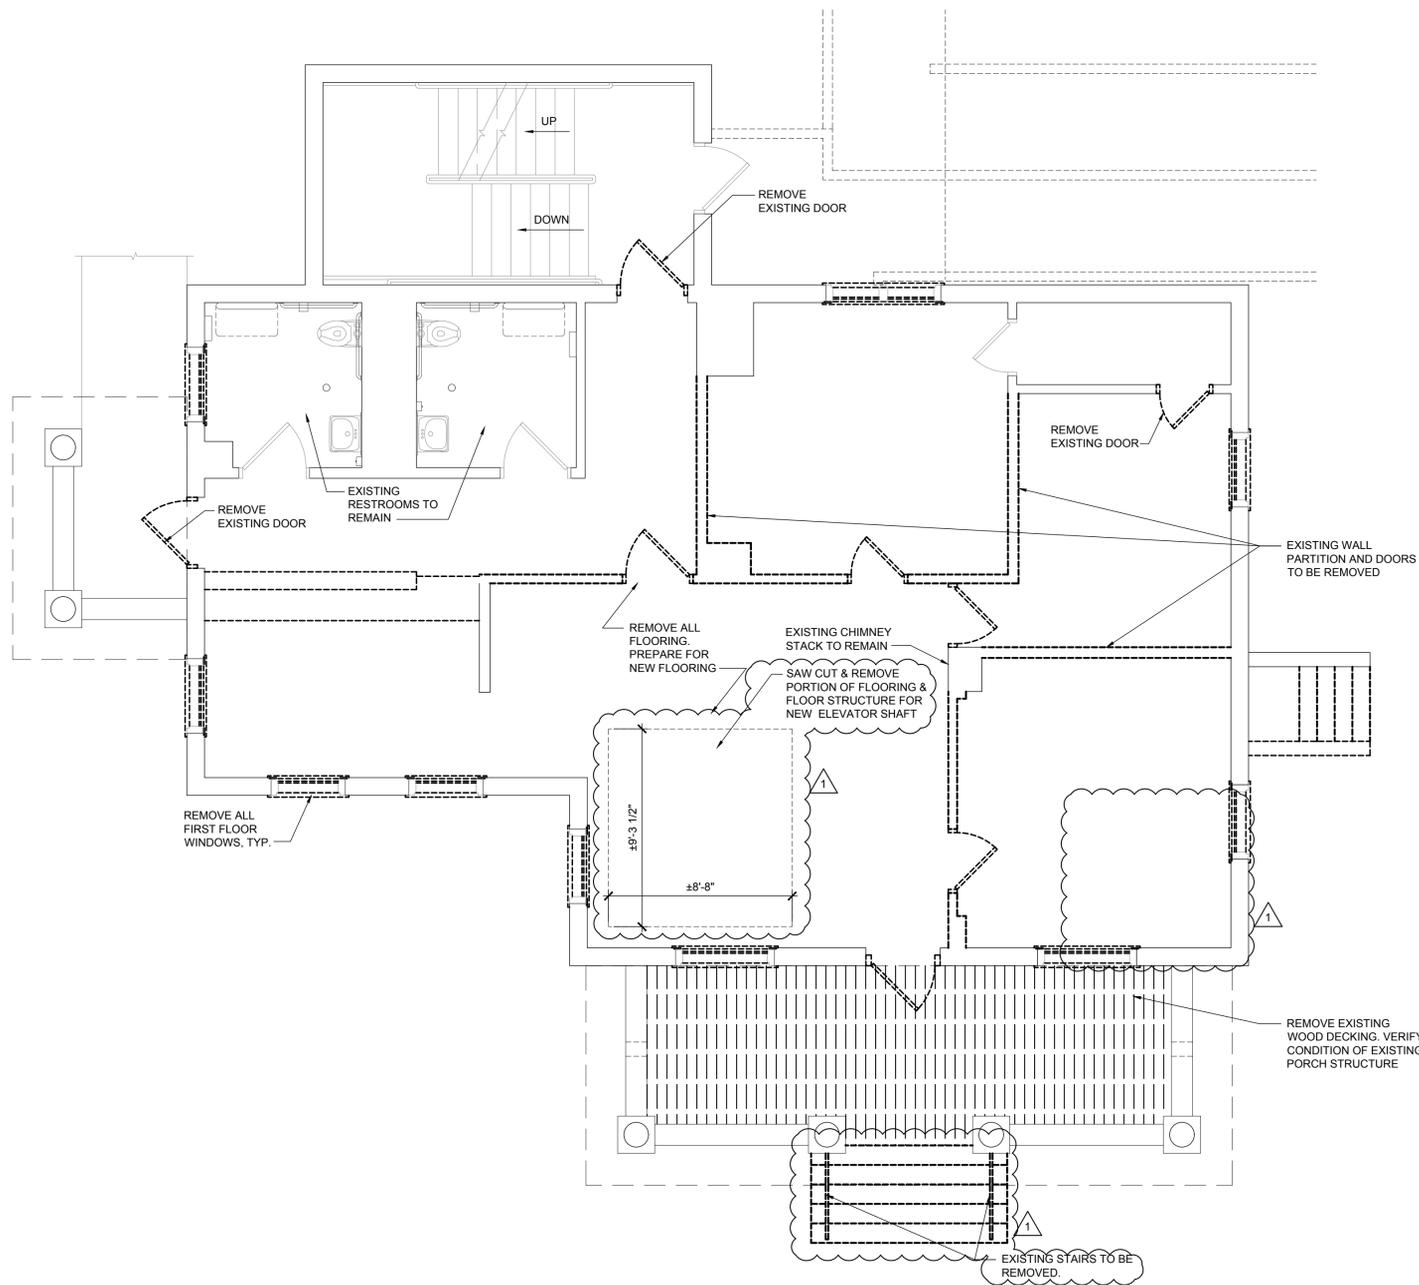
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drawn:	JB

sheet title:
BASEMENT DEMOLITION FLOOR PLAN

sheet number:
D101

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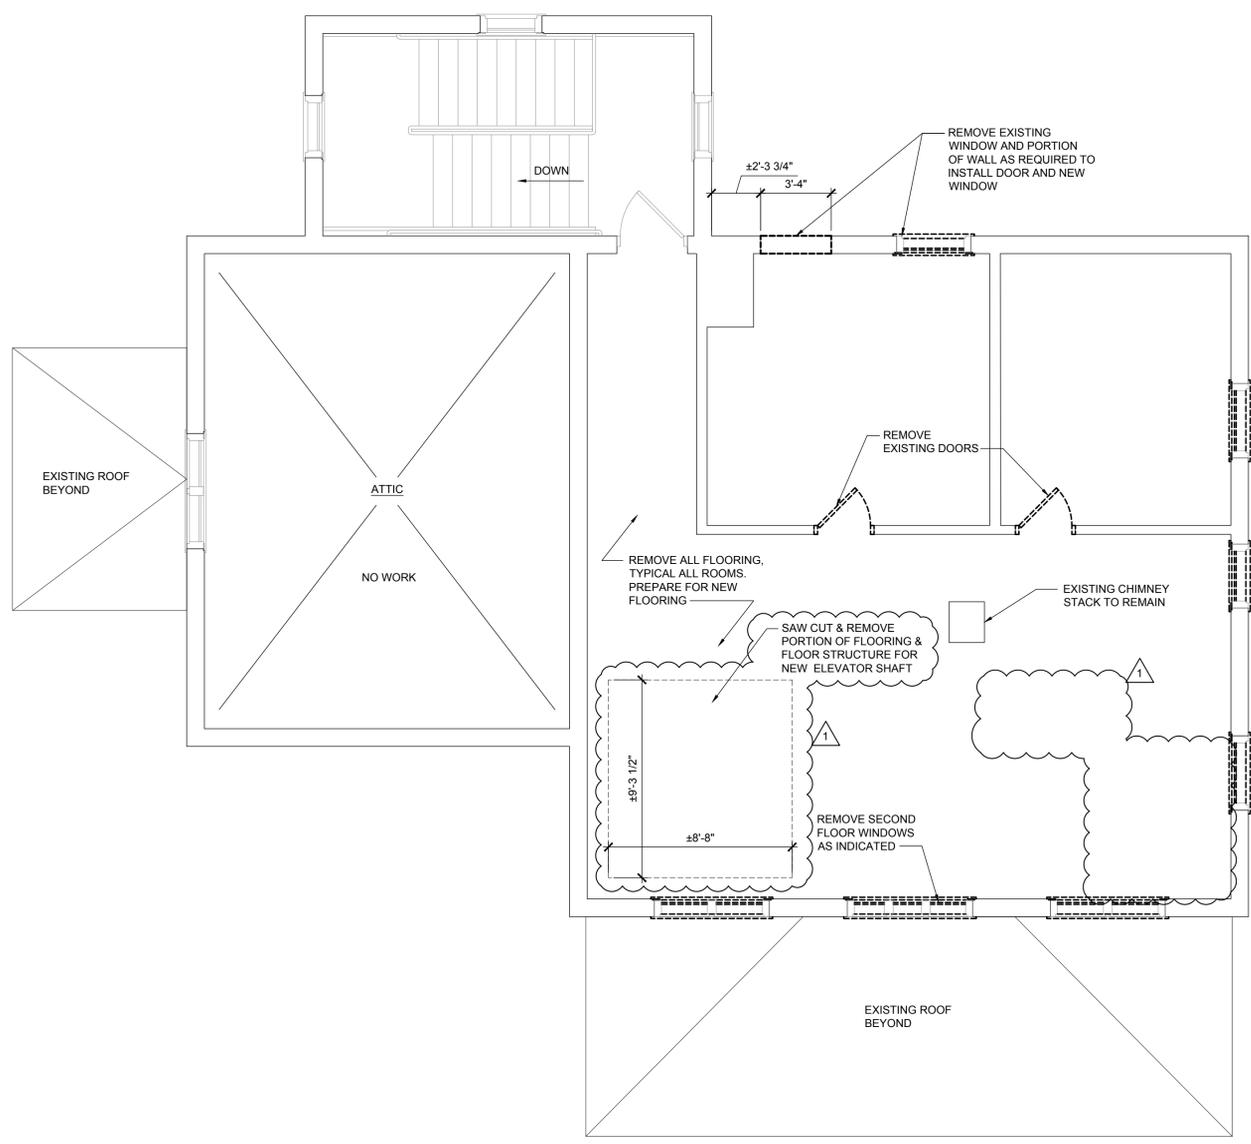
1 FIRST FLOOR DEMOLITION PLAN
SCALE: 1/4" = 1'-0"

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DEMOLITION LEGEND

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1 SECOND FLOOR DEMOLITION PLAN
SCALE: 1/4" = 1'-0"



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- J. THROUGHOUT DURATION OF WORK, OPEN TRENCHES SHALL BE PROTECTED AND COVERED BY STEEL PLATES.
- K. WHERE ANY PLUMBING, MECHANICAL, REFRIGERATION OR ELECTRICAL ITEMS, LINES, FIXTURES, ETC. HAVE BEEN REMOVED, TERMINATE AND CAP PIPES, CONDUIT LINES, ETC. BELOW FINISH FLOOR, BEHIND FACE OF WALL, OR ABOVE CEILING. REMOVE ABANDONED WIRE BACK TO SOURCE. TERMINATIONS SHALL BE PERFORMED IN ACCORDANCE WITH APPLICABLE CODES.
- L. PRIOR TO AND DURING DEMOLITION CONTRACTOR SHALL MAINTAIN ALL LIFE SAFETY AND EXIT DEVICES AS REQUIRED BY CITY ORDINANCES. NOTIFY BUILDING OWNER PRIOR TO MOVING OR TAMPERING WITH DEVICES. PROTECT ALL SMOKE DETECTORS FROM CONSTRUCTION DUST AND DEBRIS.
- M. PROTECT ALL PUBLIC AREAS FROM CONSTRUCTION DEBRIS, DUST, ETC.
- N. ANY WALL BEING REMOVED SHALL BE CONFIRMED BY THE CONTRACTOR AS BEING NON-LOAD BEARING BEFORE PROCEEDING WITH REMOVAL. IF LOAD-BEARING WALL(S) ARE FOUND DURING CONSTRUCTION, IT SHOULD BE BROUGHT DIRECTLY TO THE OWNER'S PROJECT MANAGER'S ATTENTION BEFORE PROCEEDING WITH THE REMOVAL OF THAT WALL.
- O. RETAIN ALL REMOVED EQUIPMENT AND FIXTURES FOR REUSE. COORDINATE WITH OWNER.

DEMOLITION LEGEND

- BUILDING ELEMENTS TO BE REMOVED.
- DASHED ITEMS INDICATED ON THIS PLAN REPRESENT ARCHITECTURAL ITEMS REMOVED OR REMOVED AND RELOCATED UNLESS OTHERWISE NOTED.

SPECIAL INSPECTION AND TESTING (IBC 2015 - 1704-1706)


- ALL TESTS AND INSPECTIONS SHALL BE PERFORMED BY AN INDEPENDENT TESTING AND INSPECTION AGENCY. THE SPECIAL INSPECTOR FROM THIS TESTING AGENCY SHALL OBSERVE THE WORK FOR CONFORMANCE TO THE DESIGN DRAWINGS AND SPECIFICATIONS.
- THE SPECIAL INSPECTOR SHALL FURNISH INSPECTION REPORTS TO THE BUILDING OFFICIAL. THE ENGINEER AND ARCHITECT OF RECORD, AND ALL OTHER DESIGNATED INDIVIDUALS, ALL DISCREPANCIES SHALL BE BROUGHT TO THE ATTENTION OF THE CONTRACTOR FOR CORRECTION, THEN TO THE PROPER DESIGN AUTHORITY AND TO THE BUILDING OFFICIAL, IF NOT CORRECTED.
- THE SPECIAL INSPECTOR SHALL SUBMIT A FINAL SIGNED REPORT STATING WHETHER THE WORK REQUIRING SPECIAL INSPECTION WAS, TO THE BEST OF THE INSPECTOR'S KNOWLEDGE, IN CONFORMANCE WITH THE APPROVED DESIGN DRAWINGS, SPECIFICATIONS, SOILS REPORT, AND APPLICABLE WORKMANSHIP PROVISIONS OF THE INTERNATIONAL BUILDING CODE.
- JOB SITE VISITS BY THE STRUCTURAL ENGINEER OF RECORD DOES NOT CONSTITUTE AN OFFICIAL SPECIAL INSPECTION.
- THE FOLLOWING ITEMS MARKED 'X' REQUIRE SPECIAL INSPECTIONS: (REFER TO IBC DESIGNATED ABOVE FOR FURTHER INFORMATION)

D	VERIFICATION AND INSPECTION	INSPECTION FREQUENCY	
		CONTINUOUS	PERIODIC
	CONCRETE CONSTRUCTION - 1705.3		
1	INSPECT REINFORCEMENT, INCLUDING PRESTRESSING TENDONS, AND VERIFY PLACEMENT		X
2	REINFORCING BAR WELDING:	N/A	
a	VERIFY WELABILITY OF REINFORCING BARS OTHER THAN ASTM A706		N/A
b	INSPECT SINGLE PASS FILLET WELDS, MAXIMUM 5/16"		N/A
c	INSPECT ALL OTHER WELDS	N/A	
3	INSPECT ANCHORS CAST IN CONCRETE		N/A
4	INSPECT ANCHORS POST-INSTALLED IN HARDENED CONCRETE MEMBERS:		
a	ADHESIVE ANCHORS INSTALLED IN HORIZONTALLY OR UPWARDLY INCLINED ORIENTATIONS TO RESIST SUSTAINED TENSION LOADS	N/A	
b	MECHANICAL ANCHORS AND ADHESIVE ANCHORS NOT DEFINED IN 4.a		X
5	VERIFY USE OF REQUIRED DESIGN MIX		X
6	PRIOR TO CONCRETE PLACEMENT, FABRICATE SPECIMENS FOR STRENGTH TESTS, PERFORM LUMP AND AIR CONTENT TESTS, AND DETERMINE THE TEMPERATURE OF THE CONCRETE	X	
7	INSPECT CONCRETE AND SHOTCRETE PLACEMENT FOR PROPER APPLICATION TECHNIQUES	X	
8	VERIFY MAINTENANCE OF SPECIFIED CURING TEMPERATURE AND TECHNIQUES		X
9	INSPECT PRESTRESSED CONCRETE:		
a	APPLICATION OF PRESTRESSING FORCES	N/A	
b	GROUTING OF BONDED PRESTRESSING TENDONS	N/A	
10	INSPECT ERECTION OF PRECAST CONCRETE MEMBERS		N/A
11	VERIFY IN-SITU CONCRETE STRENGTH, PRIOR TO STRESSING OF TENDONS IN POST-TENSIONED CONCRETE AND PRIOR TO REMOVAL OF SHORES AND FORMS FROM BEAMS AND STRUCTURAL SLABS		N/A
12	INSPECT FORMWORK FOR LOCATION AND DIMENSIONS OF THE CONCRETE MEMBER BEING FORMED		N/A
	WOOD CONSTRUCTION - 1705.5		
1	HIGH-LOAD DIAGRAMS		N/A
2	METAL-PLATE-CONNECTED WOOD TRUSSES SPANNING 60 FEET OR GREATER		N/A
3	FIELD GLUING	X	
4	NAILING, BOLTING, ANCHORING AND OTHER FASTENING OF COMPONENTS		X
	SOILS - 1705.6		
1	VERIFY MATERIALS BELOW SHALLOW FOUNDATIONS ARE ADEQUATE TO ACHIEVE THE DESIGN BEARING CAPACITY		X
2	VERIFY EXCAVATIONS ARE EXTENDED TO PROPER DEPTH AND HAVE REACHED PROPER MATERIAL		X
3	PERFORM CLASSIFICATION AND TESTING OF COMPACTED FILL MATERIALS		X
4	VERIFY USE OF PROPER MATERIALS, DENSITIES AND LIFT THICKNESS DURING PLACEMENT AND COMPACTION OF COMPACTED FILL	X	
5	PRIOR TO PLACEMENT OF COMPACTED FILL, INSPECT SUBGRADE AND VERIFY THAT SITE HAS BEEN PREPARED PROPERLY		X

ABBREVIATIONS

ANGLE	FD	FLOOR DRAIN	PERP	PERPENDICULAR
ANCHOR BOLT	FDN	FOUNDATION	PLWD	PLYWOOD
ADDITIONAL	FIN	FINISH	PP	PARTIAL PENETRATION
ALTERNATE	FLR	FLOOR	PREFAB	PREFABRICATED
ARCHITECTURAL	FRP	FIBERGLASS REINFORCED PLASTIC	PSF	POUNDS PER SQUARE FOOT
B OR BOT	FTG	FOOTING	PSI	POUNDS PER SQUARE INCH
BLDG	F/	FACE OF	PSL	PARALLEL STRAND LUMBER
BLKG	GA	GAGE	P-T	POST-TENSIONED
BMU	GALV	GALVANIZED	PT	PRESSURE TREATED
BR	GEOTECH	GEOTECHNICAL	R	RADIUS
BRB	GL	GLUE LAMINATED TIMBER	RD	ROOF DECK
BRG	GWB	GYPSPUM WALL BOARD	REF	REFER / REFERENCE
BTWN	H	HEADER	REINF	REINFORCING
C	HF	HEM-FIR	REQD	REQUIRED
CB	HGR	HANGER	RET	RETAINING
CIP	HD	HOLD-DOWN	RTU	ROOF TOP UNIT
C.J.	HORIZ	HORIZONTAL	SC	STEEL COLUMN
C.J.P	HP	HIGH POINT	SCB	SPECIAL CONCENTRIC BRACED
CLR	HSS	= TS (HOLLOW STRUCTURAL SECTION)	SCHED	SCHEDULE
CMU	IBC	INTERNATIONAL BUILDING CODE	SHTHG	SHEATHING
COL	ID	INSIDE DIAMETER	SIM	SIMILAR
CONC	IE	INVERT ELEVATION	SMF	SPECIAL MOMENT FRAME
CONN	INT	INTERIOR	SOG	SLAB ON GRADE SPECIFICATION
CONST	k	KIPS	SPEC	SQUARE
CONT	KSF	KIPS PER SQUARE FOOT	SQ	SQUARE
CP	L	LINEAL FOOT	SR	STUDRAIL
C/SINK	LL	LIVE LOAD	SF	SQUARE FOOT
CTRD	LLH	LONG LEG HORIZONTAL	SST	STAINLESS STEEL
CFS	LLV	LONG LEG VERTICAL	STAGG	STAGGER / STAGGERED
DB	LP	LOW POINT	STD	STANDARD
DBA	LV	LONGITUDINAL LAMINATED STRAND LUMBER	STIFF	STIFFENER
DBL	LONGIT	LONGITUDINAL LAMINATED STRAND LUMBER	STL	STEEL
DEMO	LSL	LAMINATED VENEER LUMBER	STRUCT	STRUCTURAL
DEV	LVL	LUMBER	SWWJ	SOLID WEB WOOD JOIST
DF	MAS	MASONRY	SYM	SYMMETRICAL
DIAG	MAX	MAXIMUM	T	TOP
DIST	MECH	MECHANICAL	TJ	TOP OF
DL	MEZZ	MEZZANINE	T&B	TOP & BOTTOM
DN	MFR	MANUFACTURER	TC AX LD	TOP CHORD AXIAL LOAD
DO	MIN	MINIMUM	TCX	TOP CHORD EXTENSION
DP	MISC	MISCELLANEOUS	TDS	TIE DOWN SYSTEM
DWG	MSW	MASONRY SHEAR WALL	T&G	TONGUE & GROOVE
(E)	MW	MASONRY WALL	THKND	THICKENED
EF	NIC	NOT IN CONTRACT	THRD	THREADED
EL	NTS	NOT TO SCALE	THRU	THROUGH
ELEC	OC	ORDINARY CONCENTRIC BRACED	TRANSV	TRANSVERSE
ELEV	OD	OUTSIDE DIAMETER	TYP	TYPICAL
EMBED	OF	OUTSIDE FACE	UBC	UNIFORM BUILDING CODE
EQ	OPNG	OPENING	UNO	UNLESS NOTED OTHERWISE
EQUIP	OPP	OPPOSITE	URM	UNREINFORCED MASONRY UNIT
EW	OWSJ	OPEN WEB STEEL JOIST	VERT	VERTICAL
EXP	OWWJ	OPEN WEB WOOD JOIST	W	WIDE
EXP JT	P	PLATE	W/O	WITHOUT
EXT	PAF	POWDER ACTUATED FASTENER	WF	WALL FOOTING
F	PC	PRECAST	WFS	WELDED HEADED STUD
			WP	WORKING POINT
			WWF	WELDED WIRE FABRIC PLUS OR MINUS
			±	

SYMBOL SCHEDULE

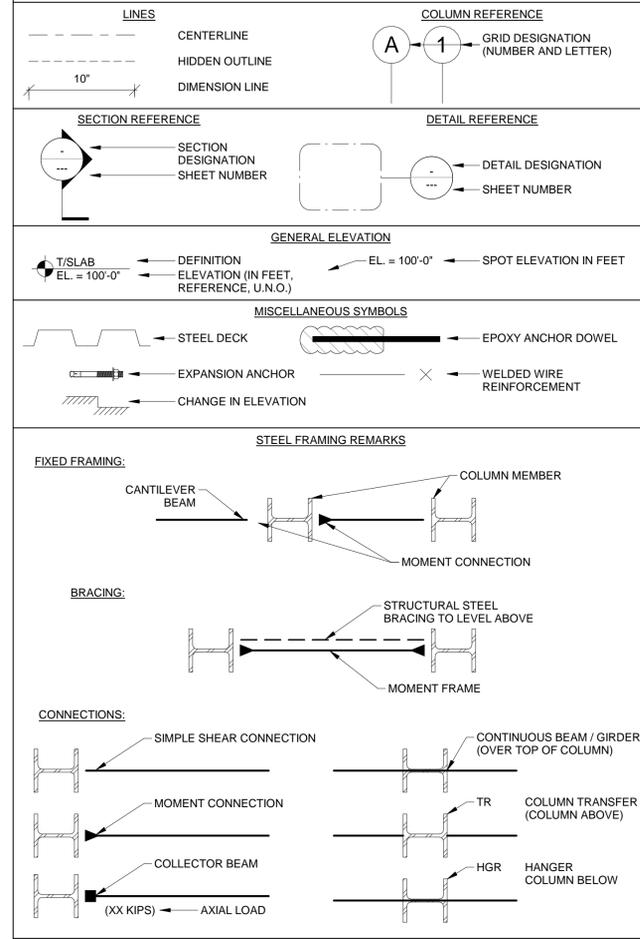

STRUCTURAL SHEET INDEX

S-0.0	STRUCTURAL NOTES
S-0.1	STRUCTURAL NOTES
S-1.0	FOUNDATION PLAN
S-2.0	FIRST FLOOR FRAMING PLAN
S-2.1	SECOND FLOOR FRAMING PLAN
S-2.2	ROOF FRAMING PLAN
S-2.3	NORTH RAMP FOUNDATION & FRAMING PLANS
S-3.0	FOUNDATION DETAILS
S-3.1	FOUNDATION DETAILS
S-4.0	FRAMING DETAILS
S-4.1	FRAMING DETAILS

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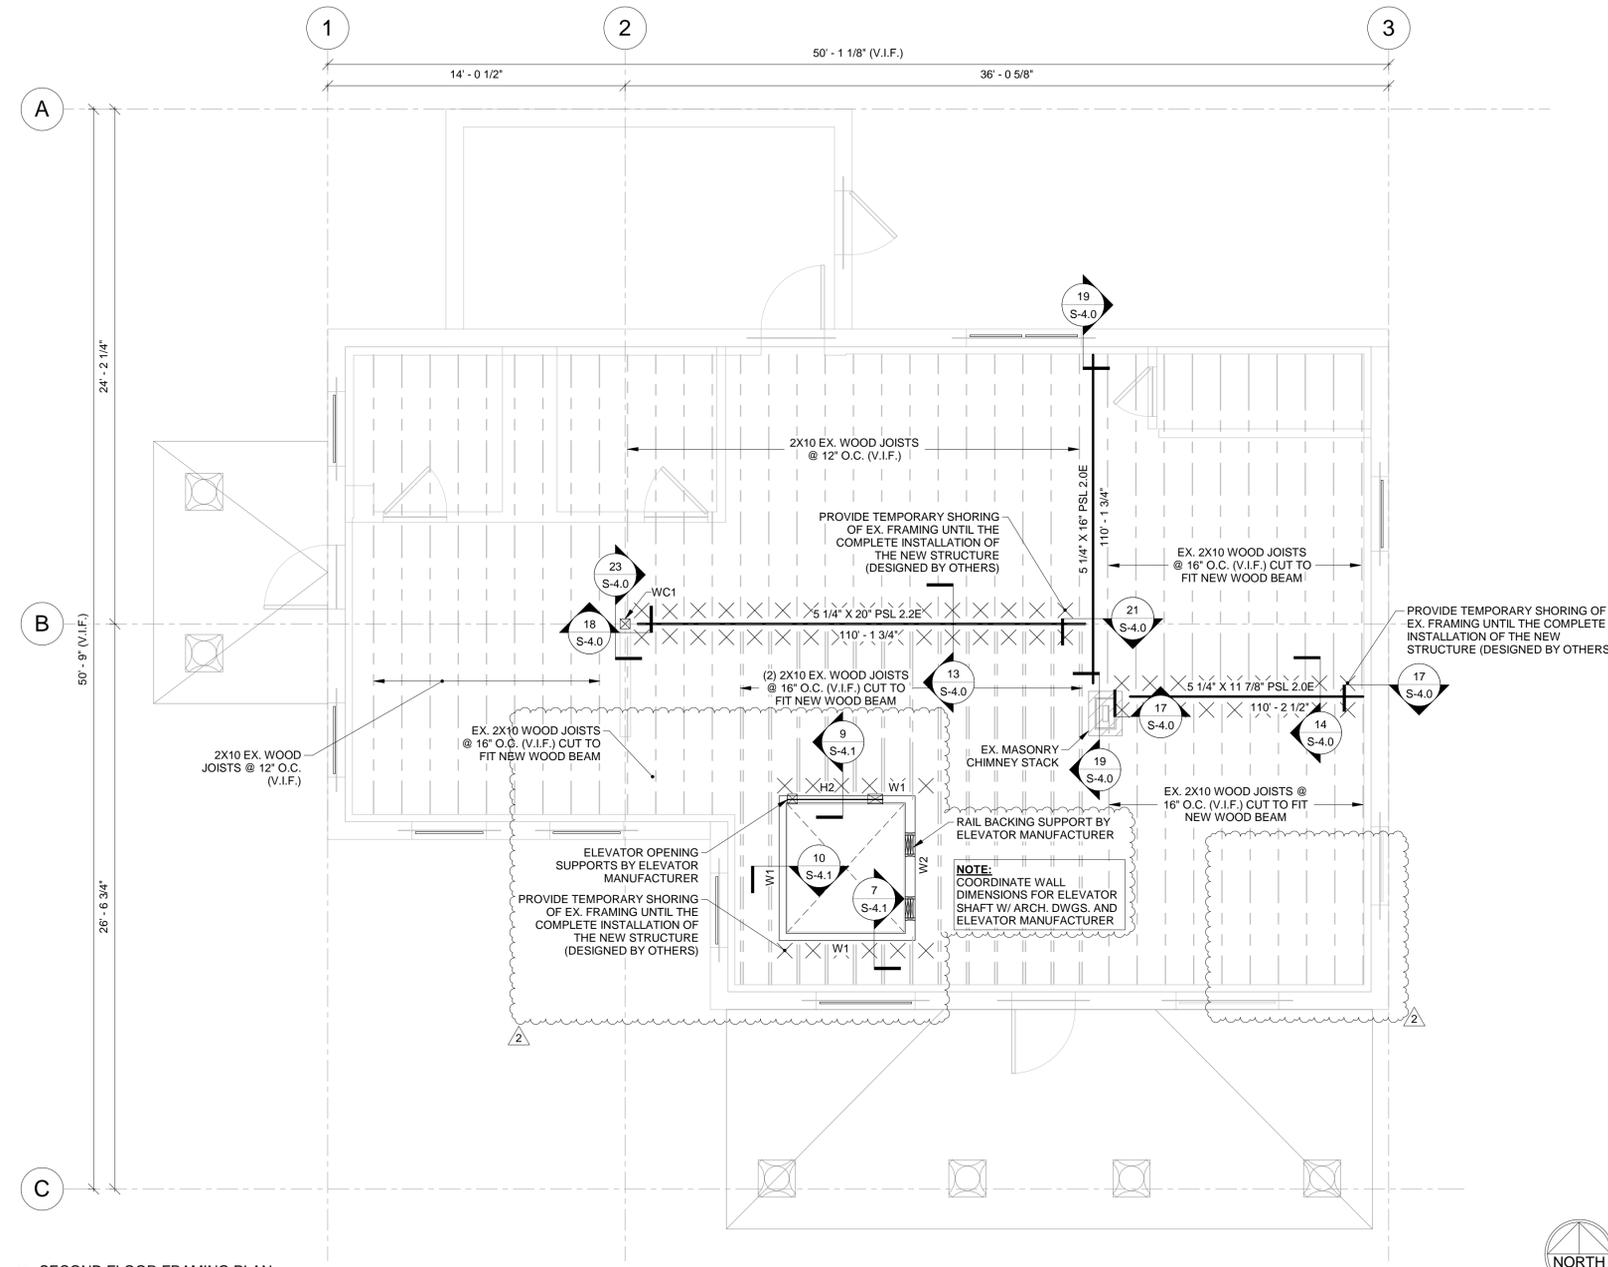
VOGELI HOUSE REMODEL

ISSUE

TO	DATE
PERMIT	7/21/21
PERMIT 1	8/6/21
ADDENDUM 2	8/27/21

CHECK: SMD
 DRAWN: DWK
 JOB: D2100051

S-0.1
 STRUCTURAL NOTES



1 SECOND FLOOR FRAMING PLAN
1/4" = 1'-0"

SECOND FLOOR FRAMING PLAN NOTES

1. 2ND FLOOR EL. = 110' - 2 1/2'
2. CONTRACTOR TO VERIFY WITH ARCHITECTURAL DRAWINGS ALL ELEVATIONS AND DIMENSIONS. SEE ARCHITECTURAL DRAWINGS FOR ELEVATIONS, OPENINGS AND DIMENSIONS NOT SHOWN.
3. CONTRACTOR TO VERIFY ALL DIMENSIONS PRIOR TO FABRICATION, CONSTRUCTION OR ERECTION. THE CONTRACTOR SHALL ASSUME RESPONSIBILITY FOR ANY DISCREPANCIES.
4. NO INFORMATION WAS PROVIDED ON THE EXISTING BRICK CHIMNEY STACK. ANALYSIS OF THE CHIMNEY STACK IS NOT IN OUR SCOPE.
5. ALL EXISTING STRUCTURE IS ASSUMED STRUCTURALLY ADEQUATE FOR PROPOSED OCCUPANCY. THE EXISTING STRUCTURE HAS BEEN USED FOR PUBLIC USE / AN OFFICE.
6. CONTRACTOR TO COORDINATE SIZE AND LOCATION OF ALL MECHANICAL/ELECTRICAL OPENINGS THAT REQUIRE FRAMING (WHETHER SPECIFIED OR NOT). ALL FRAMING MUST BE APPROVED BY THE STRUCTURAL ENGINEER PRIOR TO CONSTRUCTION.
7. VERIFY ALL MECHANICAL OPENINGS WITH M.E.P. DRAWINGS.
8. THE CONTRACTOR SHALL REPLACE ANY ITEMS DAMAGED DURING CONSTRUCTION.
9. SEE S-2.3 FOR REAR RAMP FOUNDATION & FRAMING PLANS.
10. SEE S-4.0 & S-4.1 FOR FRAMING DETAILS.
11. SEE S-0.0 & S-0.1 FOR GENERAL STRUCTURAL NOTES AND MORE INFORMATION.

KEY	
	INDICATES EX. WOOD STUD WALL
	INDICATES EX. WOOD GIRDER BEAM
	INDICATES EX. WOOD JOIST
	INDICATES EX. WOOD HEADER
	INDICATES EX. WOOD TRUSS
	INDICATES WOOD COLUMN
	INDICATES WOOD GIRDER BEAM
	INDICATES EX. STEEL LINTEL
	INDICATES TEMPORARY SHORING

ABBREVIATIONS	
EL	ELEVATION
T/	TOP OF
B/	BOTTOM OF
EA.	EACH
TYP.	TYPICAL
WC	WOOD COLUMN
MK.	MARK
W/	WITH
CB	COLUMN BASE
EX.	EXISTING

BEAM ANNOTATIONS	
XXXX	BEAM TYPE
XX'-XX'	BEAM ELEVATION

HEADER SCHEDULE					
MK.	SIZE AND MATERIAL	LENGTH	SUPPORTS		
			FULL HEIGHT KING STUD	JACK STUD	SECTION
H1	FLAT 2X4	3' - 0"	(1) 2X4	(1) 2X4	
H2	(2) 2X10	4' - 6"	(2) 2X4	(2) 2X4	

WOOD WALL SCHEDULE					
MK.	SIZE AND MATERIAL	SILL PLATE	SILL PLATE ANCHORAGE	TOP PLATE	REMARKS
W1	2X4 @ 16" O.C.	PRESSURE-TREATED CONT. 2X4	SIMPSON THD50400H ACREW ANCHORS @ 32" O.C.	CONT. DOUBLE 2X4	SEE ARCH. DWGS. FOR WALL FINISH
W2	2X6 @ 16" O.C.	PRESSURE-TREATED CONT. 2X6	SIMPSON THD50400H ACREW ANCHORS @ 32" O.C.	CONT. DOUBLE 2X6	SEE ARCH. DWGS. FOR WALL FINISH

COLUMN SCHEDULE		
COLUMN MARK	WC1	COLUMN MARK
T/2ND FLOOR	110' - 2 1/2'	T/2ND FLOOR
110' - 2 1/2'		110' - 2 1/2'
T/SLAB		T/SLAB
100' - 0"		100' - 0"
T/BASEMENT SLAB		T/BASEMENT SLAB
91' - 10"	91' - 10"	91' - 10"
COLUMN BASE	CB1	COLUMN BASE
COLUMN LOCATIONS	B-2	COLUMN LOCATIONS

AQUATIC \ CIVIL \ MECHANICAL \ ELECTRICAL \ PLUMBING \ TELECOMMUNICATION \ STRUCTURAL \ ACCESSIBILITY CONSULTING \ DESIGN & PROGRAM MANAGEMENT \ LAND SURVEY

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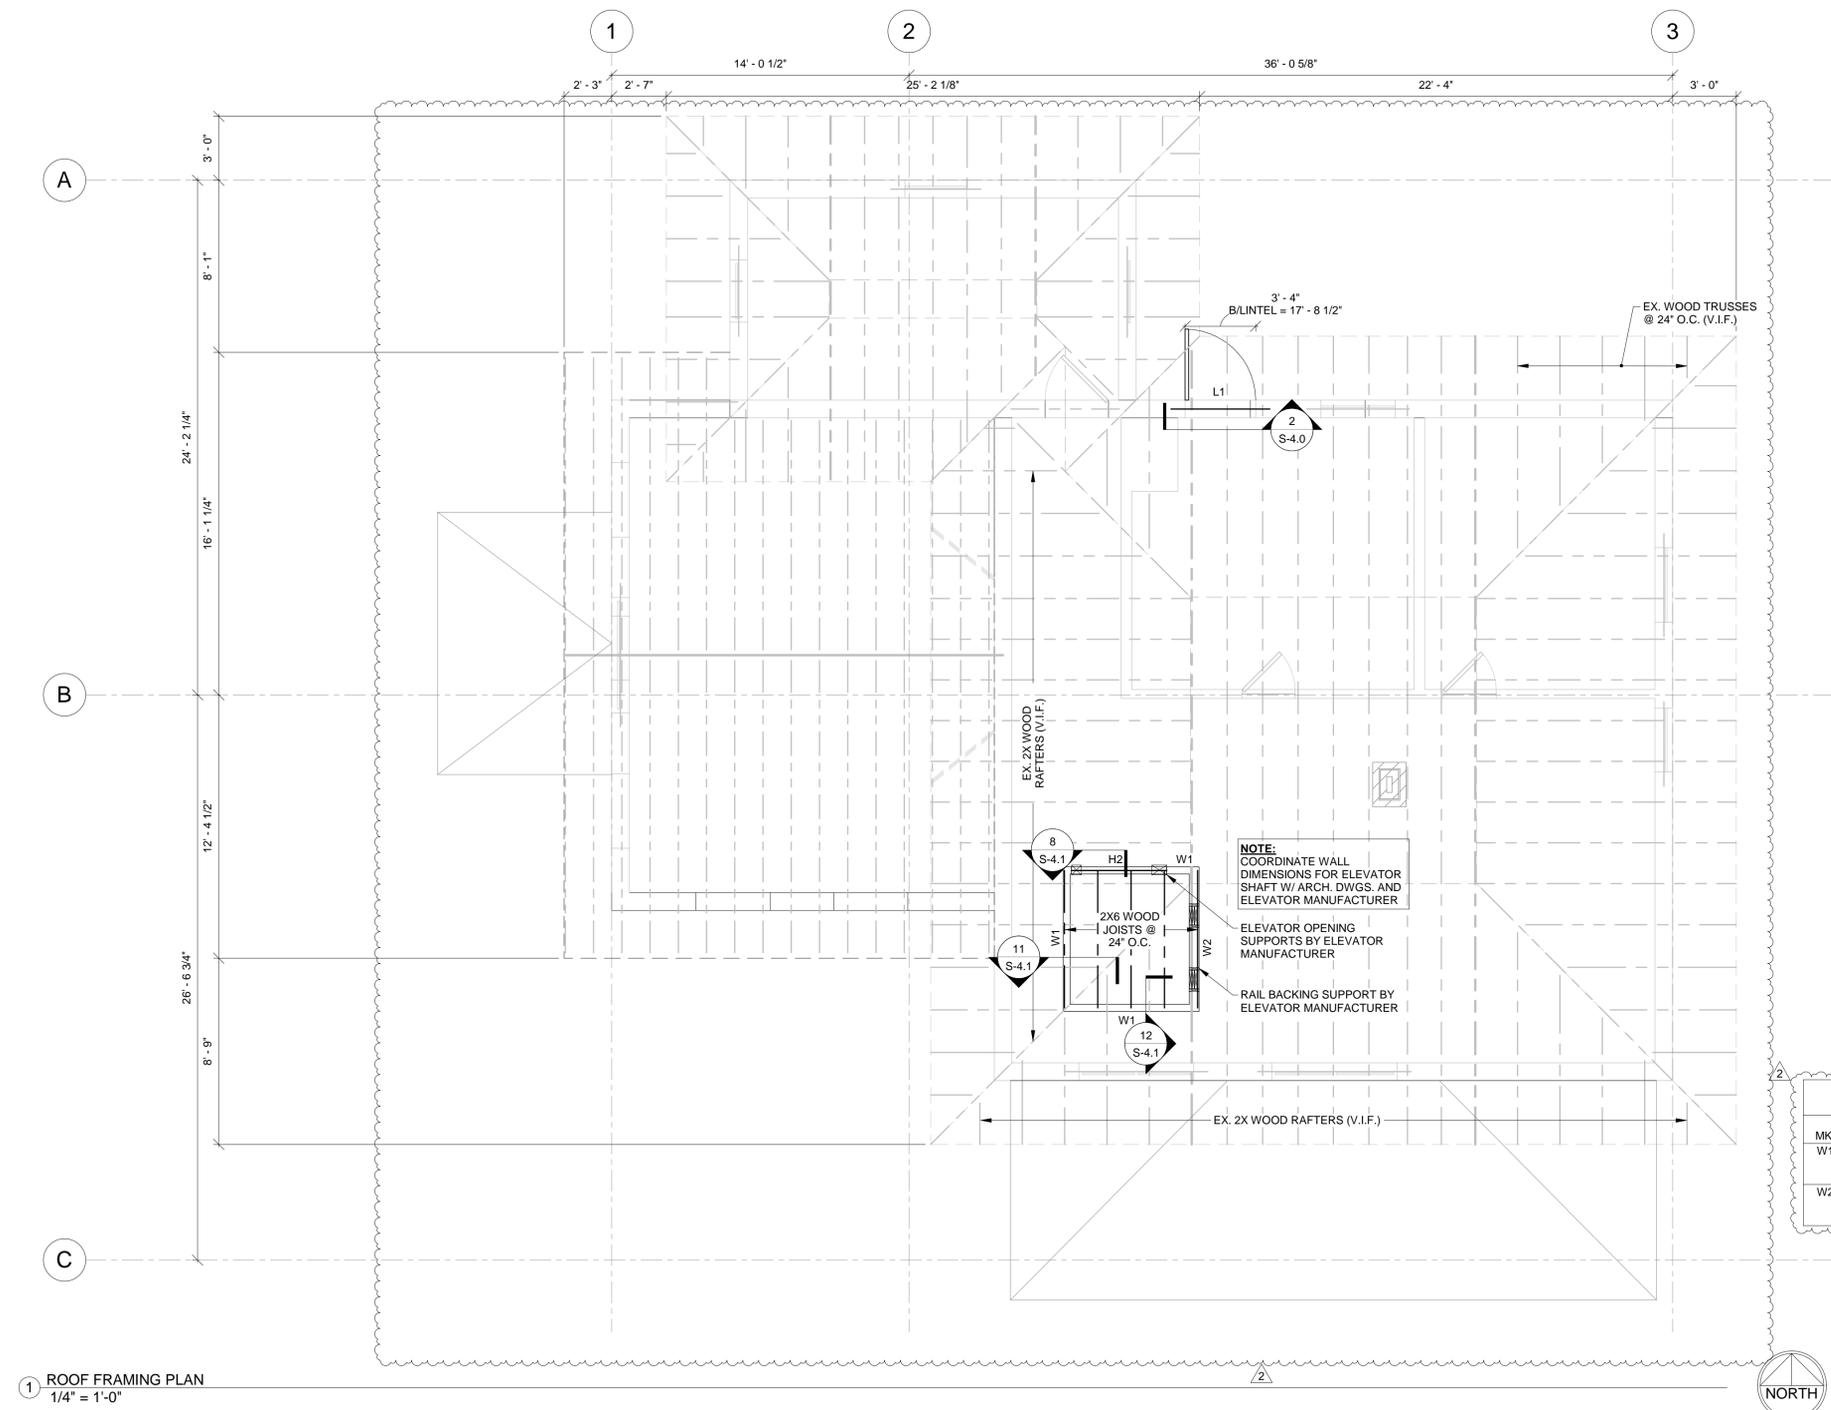
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Exp: 11/30/2022

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HOFFMAN ESTATES, IL 60189
VOGELI HOUSE REMODEL

CHECK: SMD
DRAWN: DWK
JOB: D2100051

S-2.1
SECOND FLOOR FRAMING PLAN



ROOF FRAMING PLAN NOTES

1. T/ROOF EL. = VARIES (SEE ARCH. DWGS.)
2. CONTRACTOR TO VERIFY WITH ARCHITECTURAL DRAWINGS ALL ELEVATIONS AND DIMENSIONS. SEE ARCHITECTURAL DRAWINGS FOR ELEVATIONS, OPENINGS AND DIMENSIONS NOT SHOWN.
3. CONTRACTOR TO VERIFY ALL DIMENSIONS PRIOR TO FABRICATION, CONSTRUCTION OR ERECTION. THE CONTRACTOR SHALL ASSUME RESPONSIBILITY FOR ANY DISCREPANCIES.
4. CONTRACTOR TO COORDINATE SIZE AND LOCATION OF ALL MECHANICAL/ELECTRICAL OPENINGS THAT REQUIRE FRAMING (WHETHER SPECIFIED OR NOT). ALL FRAMING MUST BE APPROVED BY THE STRUCTURAL ENGINEER PRIOR TO CONSTRUCTION.
5. VERIFY ALL MECHANICAL OPENINGS WITH M.E.P. DRAWINGS.
6. THE CONTRACTOR SHALL REPLACE ANY ITEMS DAMAGED DURING CONSTRUCTION.
7. WEIGHTS OF ALL ROOFTOP UNITS SHALL BE VERIFIED PRIOR TO FABRICATION OF STEEL.
8. SEE S-2.3 FOR REAR RAMP FOUNDATION & FRAMING PLANS.
9. SEE S-4.0 & S-4.1 FOR FRAMING DETAILS.
10. SEE S-0.0 & S-0.1 FOR GENERAL STRUCTURAL NOTES AND MORE INFORMATION.

KEY

- INDICATES EX. WOOD STUD WALL
- INDICATES EX. GIRDER BEAM
- INDICATES EX. WOOD JOIST
- INDICATES EX. WOOD HEADER
- INDICATES EX. WOOD TRUSS
- INDICATES WOOD COLUMN
- INDICATES STEEL LINTEL
- INDICATES EX. STEEL LINTEL

ABBREVIATIONS

- EL. ELEVATION
- T/ TOP OF
- B/ BOTTOM OF
- EA. EACH
- TYP. TYPICAL
- MK. MARK
- W/ WITH
- WC WOOD COLUMN
- EX. EXISTING

BEAM ANNOTATIONS

- XXXX — BEAM TYPE
- XX'-XX" — BEAM ELEVATION

LINTEL SCHEDULE

MK.	SIZE	OPENING LENGTH	BEARING PLATE	BEARING PLATE CONNECTION	WALL BEARING EA. END	SECTION
L1	2L3-1/2X3-1/2X5/16	3'-4"	7 1/2" X 8" X 3/8"	1/4" FILLET WELD	8"	

HEADER SCHEDULE

MK.	SIZE AND MATERIAL	LENGTH	SUPPORTS		SECTION
			FULL HEIGHT KING STUD	JACK STUD	
H1	FLAT 2X4	3'-0"	(1) 2X4	(1) 2X4	
H2	(2) 2X10	4'-6"	(2) 2X4	(2) 2X4	

WOOD WALL SCHEDULE

MK.	SIZE AND MATERIAL	SILL PLATE	SILL PLATE ANCHORAGE	TOP PLATE	REMARKS
W1	2X4 @ 16" O.C.	PRESSURE-TREATED CONT. 2X4	SIMPSON THD50400H ACREW ANCHORS @ 32" O.C.	CONT. DOUBLE 2X4	SEE ARCH. DWGS. FOR WALL FINISH
W2	2X6 @ 16" O.C.	PRESSURE-TREATED CONT. 2X6	SIMPSON THD50400H ACREW ANCHORS @ 32" O.C.	CONT. DOUBLE 2X6	SEE ARCH. DWGS. FOR WALL FINISH

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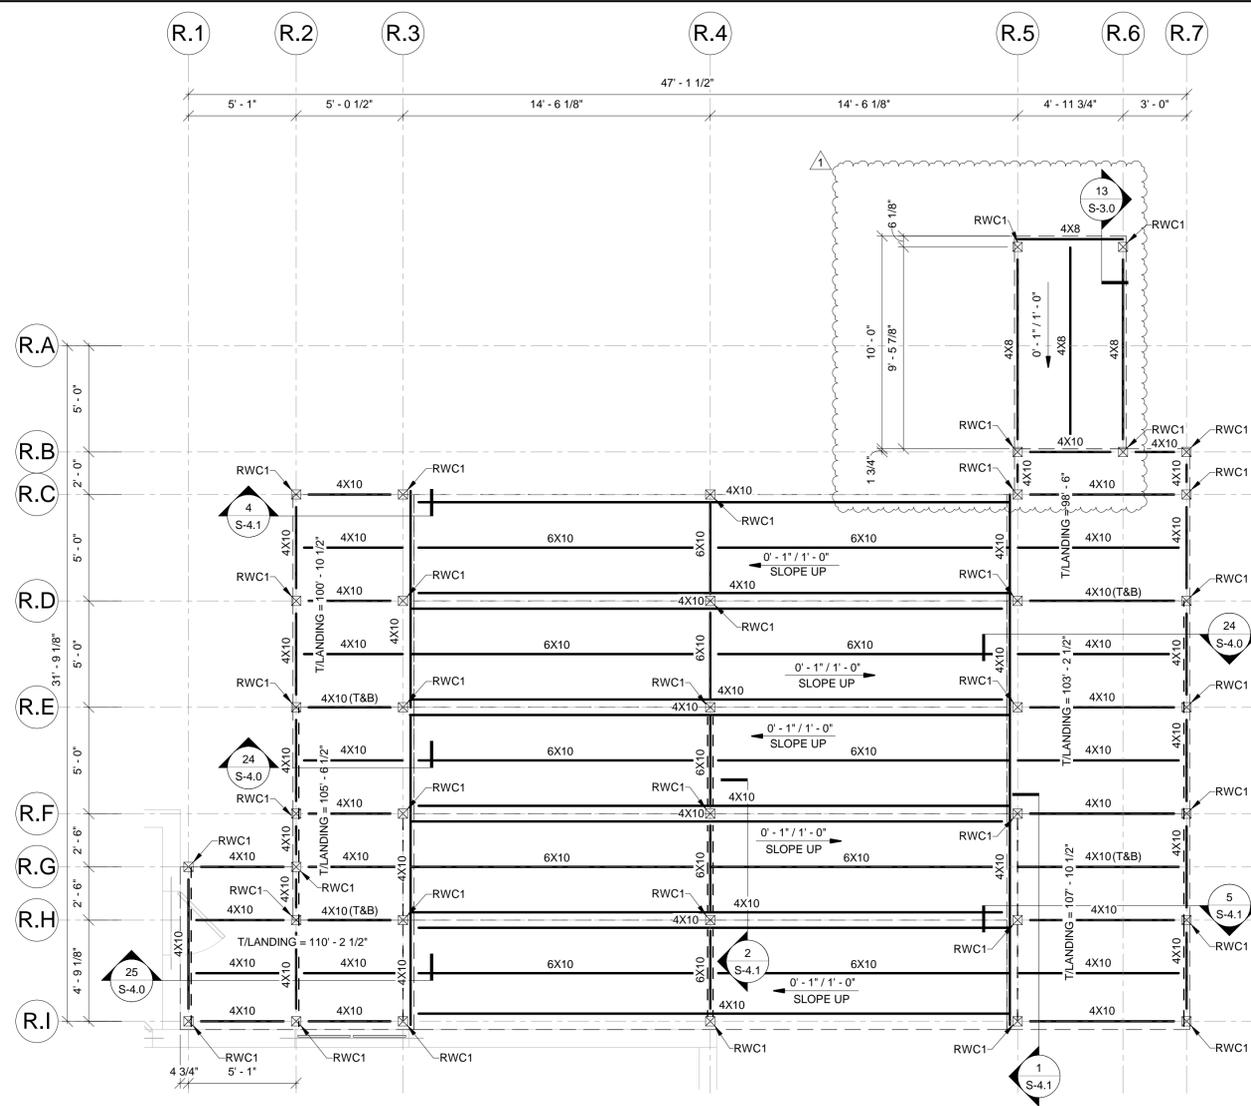


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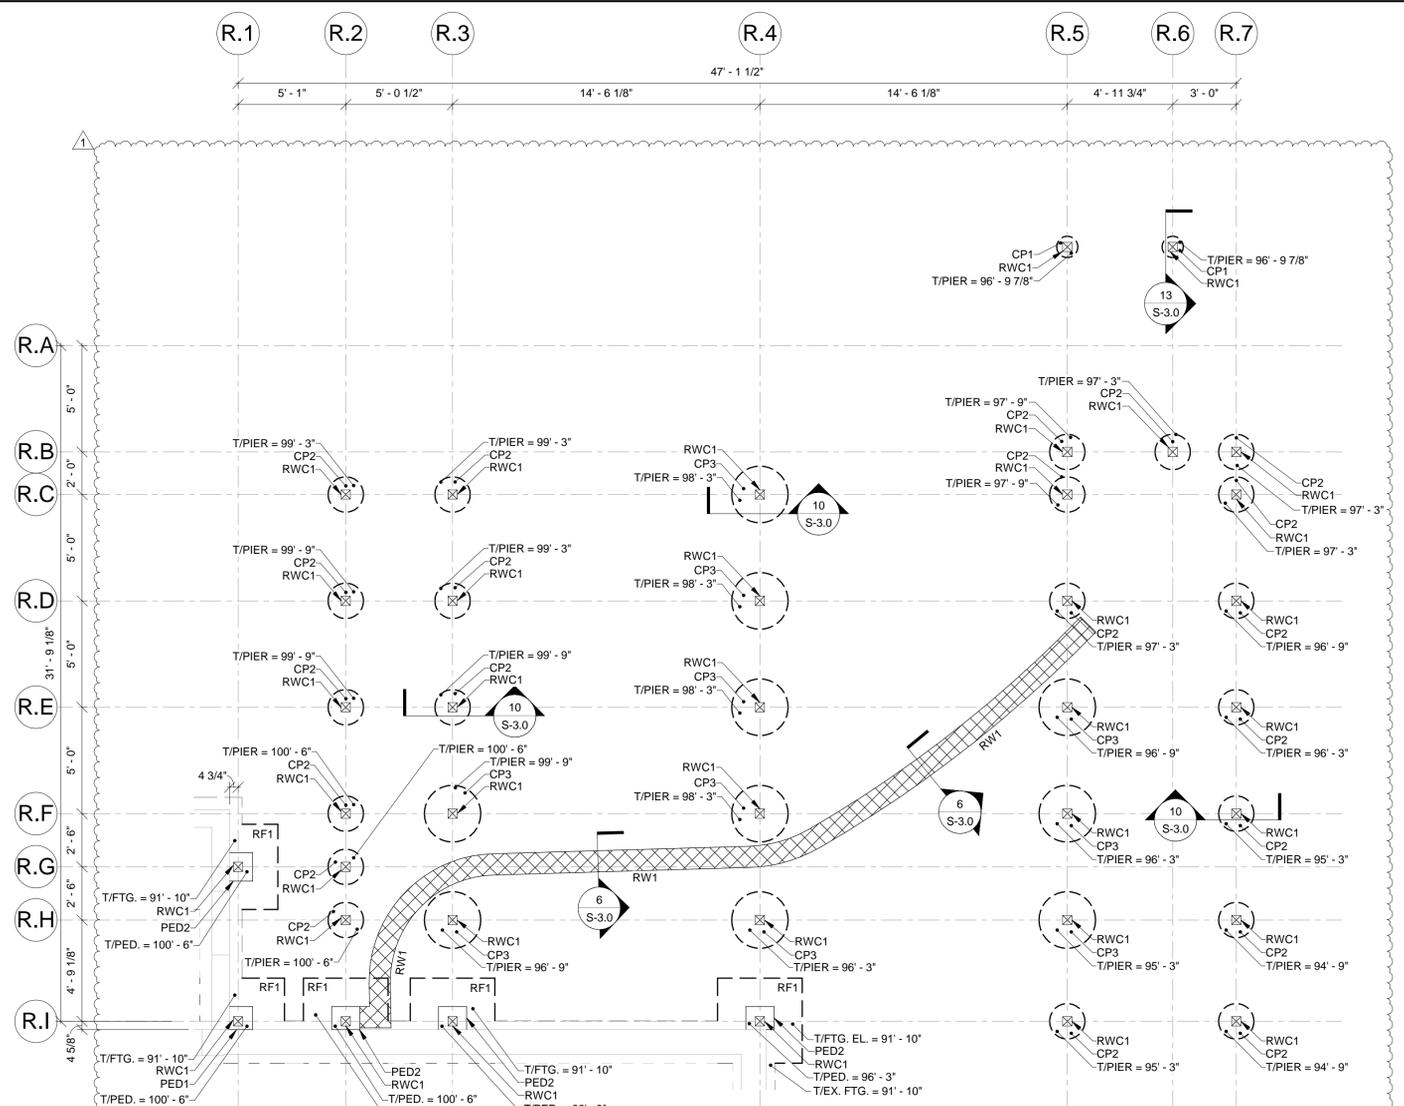
HOFFMAN ESTATES PARK DISTRICT
650 W HIGGINS ROAD
HOFFMAN ESTATES, IL 60169
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ISSUE	
TO	DATE
PERMIT	7/21/21
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ADDENDUM	8/27/21

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2 NORTH RAMP FRAMING PLAN
1/4" = 1'-0"



1 NORTH RAMP FOUNDATION PLAN
1/4" = 1'-0"

NORTH RAMP FRAMING PLAN NOTES

1. T/LANDING EL. = VARIES (SEE ARCH. DWGS.)
2. CONTRACTOR TO VERIFY WITH ARCHITECTURAL DRAWINGS ALL ELEVATIONS AND DIMENSIONS. SEE ARCHITECTURAL DRAWINGS FOR ELEVATIONS, OPENINGS AND DIMENSIONS NOT SHOWN.
3. CONTRACTOR TO VERIFY ALL DIMENSIONS PRIOR TO FABRICATION, CONSTRUCTION OR ERECTION. THE CONTRACTOR SHALL ASSUME RESPONSIBILITY FOR ANY DISCREPANCIES.
4. THE CONTRACTOR SHALL REPLACE ANY ITEMS DAMAGED DURING CONSTRUCTION.
5. SEE S-4.0 & S-4.1 FOR FRAMING DETAILS
6. SEE S-0.0 & S-0.1 FOR GENERAL STRUCTURAL NOTES AND MORE INFORMATION.

KEY		ABBREVIATIONS	
	INDICATES EX. WOOD STUD WALL	EL.	ELEVATION
	INDICATES WOOD BRACING	T/	TOP OF
	INDICATES WOOD BEAM	B/	BOTTOM OF
	INDICATES WOOD HEADER	EA.	EACH
	INDICATES WOOD COLUMN	TYP.	TYPICAL
		RWC	WOOD COLUMN
		MK.	MARK
		W/	WIDTH
		CB	COLUMN BASE
		EX.	EXISTING
		W	WOOD STUD WALL
		H	HEADER
BEAM ANNOTATIONS			
XXXX	←	BEAM TYPE	
XX-XX	←	BEAM ELEVATION	
XXXX	←	BEAM TYPE (SLOPED)	
XX-XX	←	BEAM ELEVATION (H.P. & L.P.)	

RETAINING WALL SCHEDULE			
MK.	TYPE	REINFORCEMENT TYPE	EMBEDMENT DEPTH
RW1	AB CLASSIC BLOCK	0" BLOCK AND NO-FINES CONCRETE TOTAL DEPTH	12" MIN

CONCRETE PEDESTAL SCHEDULE			
CONCRETE STRENGTH: f _c = 4000 PSI. REBAR: F _y = 60,000 PSI			
MK.	DIMENSIONS	TIES	VERTICAL BARS
PED1	13" X 13"	(3) #5 BARS AT TOP, REMAINING @ 10' O.C.	(4) #5
PED2	13" X 16"	(3) #5 BARS AT TOP, REMAINING @ 10' O.C.	(4) #5

RAMP SUPPORT COLUMN SCHEDULE		
MK.	COLUMN TYPE	COLUMN BASE
RWC1	5 1/4" X 5 1/4" PSL 1.8E	SIMPSON MPB66Z

RAMP SUPPORT FOOTING SCHEDULE				
MIN. NET ALLOWABLE SOIL BEARING PRESSURE = 2000 PSF				
MK.	LENGTH	WIDTH	THICKNESS	REINFORCEMENT
RF1	4'-0"	4'-0"	12"	(5) #5 (5) #5

CONCRETE PIER SCHEDULE				
MIN. NET ALLOWABLE SOIL BEARING PRESSURE = 2000 PSF				
MK.	OUTSIDE DIAMETER	VERTICAL	HORIZONTAL TIES	DEPTH BELOW GRADE
CP1	12"	(3) #4	(3) #3 BARS AT TOP, REMAINING @ 10' O.C.	3'-6"
CP2	20"	(8) #4	(3) #3 BARS AT TOP, REMAINING @ 10' O.C.	3'-6"
CP3	32"	(13) #5	(3) #4 BARS AT TOP, REMAINING @ 10' O.C.	4'-6"

NORTH RAMP FOUNDATION PLAN NOTES

1. T/EX. SLAB ELEVATION EL. = 91'-10" (V.I.F.)
2. T/FOOTING EL. = 91'-10"
3. CONCRETE STRENGTH: f_c = 4000 PSI AT 28 DAYS MIN.
4. DESIGN ASSUMES MIN. NET ALLOWABLE SOIL BEARING PRESSURE = 2000 PSF (NO GEOTECHNICAL REPORT)
5. SUBGRADE SOIL PREPARATION TO BE COORDINATED WITH GEOTECHNICAL REPORT.
6. EX. WALL FOOTING REINFORCEMENT SHALL CONTINUE THROUGH COLUMN SPREAD FOOTING (TYP.)
7. SEE SITE AND CIVIL PLANS FOR ALL FINAL GRADE ELEVATIONS AND ALL EXTERIOR CONCRETE SIDE WALKS.
8. CONTRACTOR TO VERIFY WITH ARCHITECTURAL DRAWINGS ALL ELEVATIONS AND DIMENSIONS. SEE ARCHITECTURAL DRAWINGS FOR ELEVATIONS, OPENINGS AND DIMENSIONS NOT SHOWN.
9. SEE S-3.0 FOR FOUNDATION DETAILS
10. SEE S-0.0 & S-0.1 FOR GENERAL STRUCTURAL NOTES AND MORE INFORMATION.

KEY		ABBREVIATIONS	
	INDICATES CONCRETE PIER	U.N.O	UNLESS NOTED OTHERWISE
	INDICATES FOOTING	CONC.	CONCRETE
	INDICATES EX. FOUNDATION	WF	CONTINUOUS WALL FOOTING
	INDICATES EX. CONCRETE STEM WALL	EL.	ELEVATION
	INDICATES RETAINING WALL	THK.	THICK
	INDICATES SLAB EDGE	T/	TOP OF
	INDICATES WOOD COLUMN	FTG/F	FOOTING
		TYP.	TYPICAL
		CONT.	CONTINUOUS
		FDN	FOUNDATION
		W/	WITH
		SIM.	SIMILAR
		S	CONCRETE SLAB ON GRADE
		WC	WOOD COLUMN
		CB	COLUMN BASE
		EX.	EXISTING
		RW	RETAINING WALL


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AQUATIC CIVIL MECHANICAL ELECTRICAL PLUMBING TELECOMMUNICATION STRUCTURAL ACCESSIBILITY CONSULTING DESIGN & PROGRAM MANAGEMENT LAND SURVEY


HOFFMAN ESTATES PARK DISTRICT
 650 W HIGGINS ROAD
 HOFFMAN ESTATES, IL 60189
VOGELI HOUSE REMODEL

CHECK: SMD
 DRAWN: DWK
 JOB: D2100051


S-2.3
 NORTH RAMP
 FOUNDATION &
 FRAMING PLANS

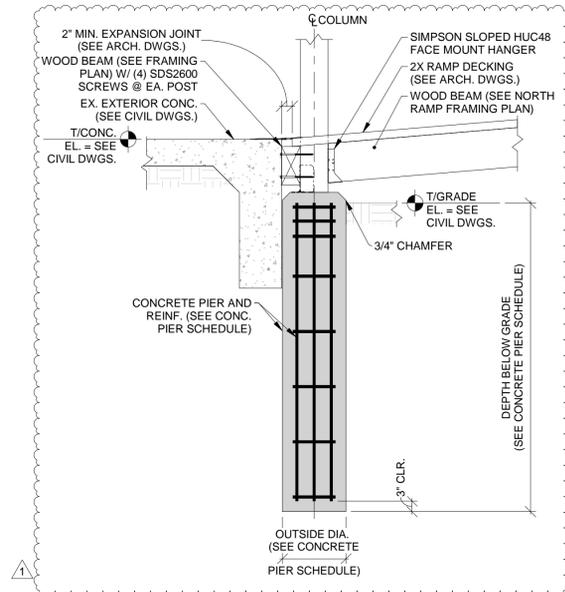


13 WOOD COLUMN @ CONCRETE PIER W/ EXTERIOR CONC.
3/4" = 1'-0"

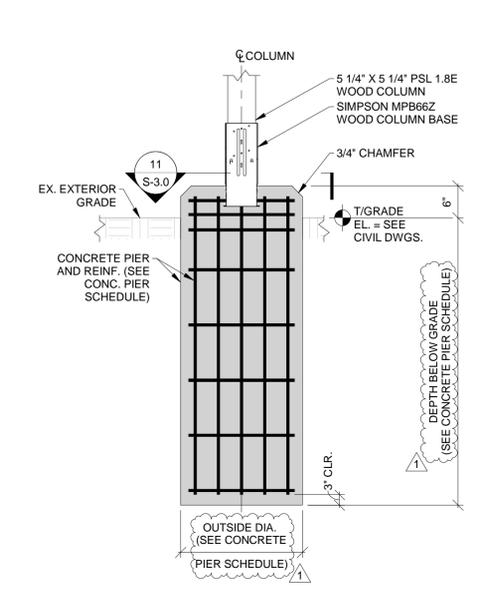


10 WOOD COLUMN @ CONCRETE PIER SECTION
3/4" = 1'-0"

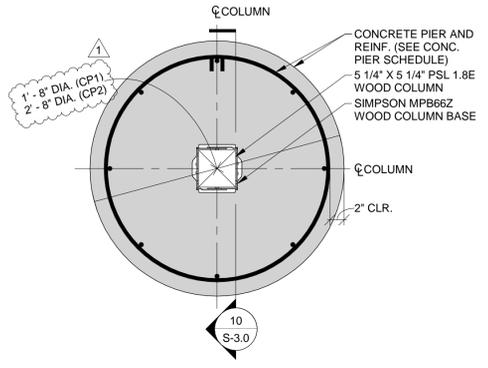


11 WOOD COLUMN @ CONCRETE PIER PLAN
1" = 1'-0"

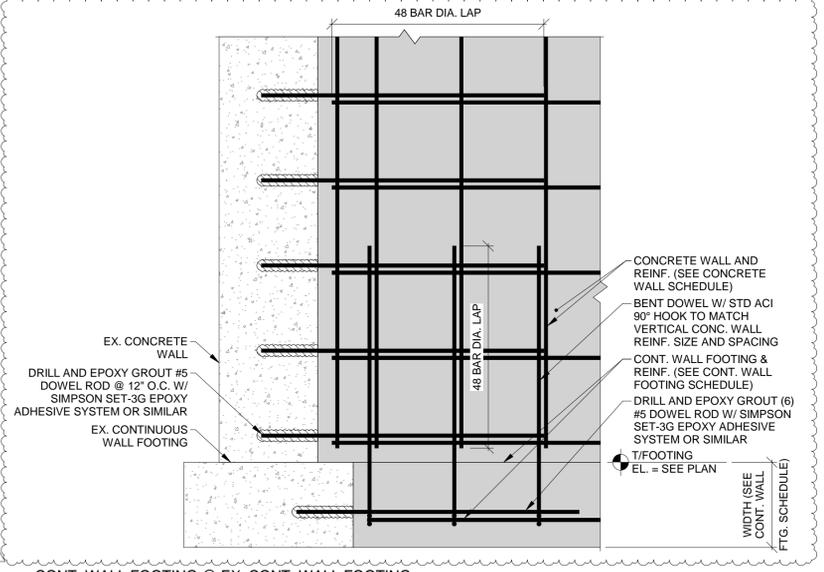


12 CONT. WALL FOOTING @ EX. CONT. WALL FOOTING
1" = 1'-0"

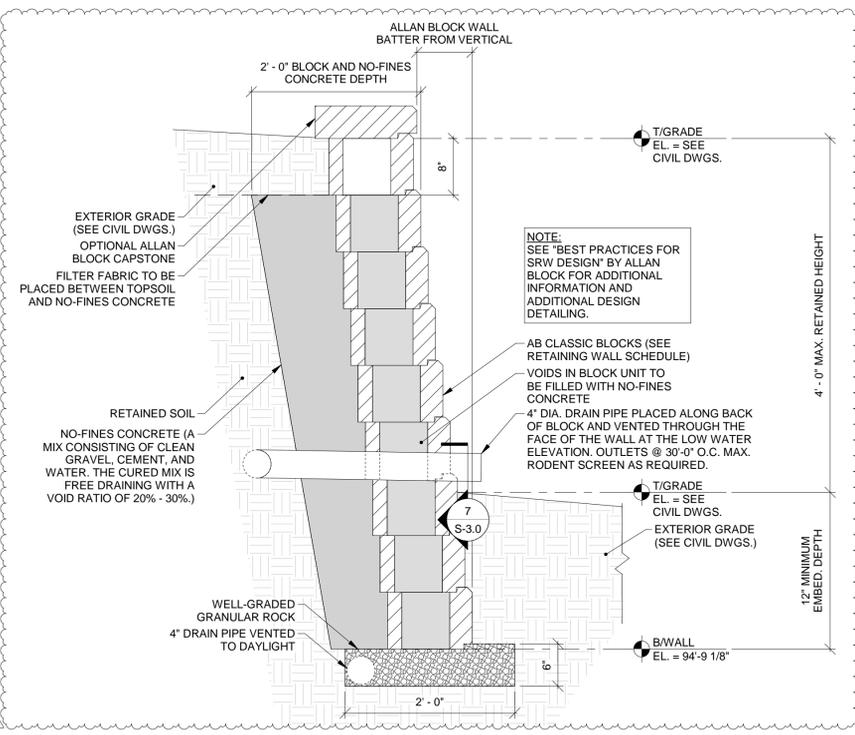


6 AB RETAINING WALL DETAIL
1" = 1'-0"

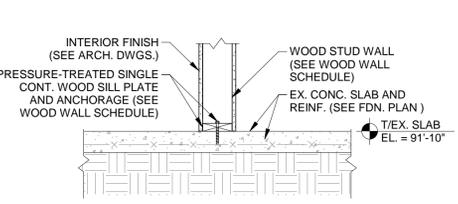


8 NEW WOOD STUD WALL ON EX. CONCRETE SLAB
3/4" = 1'-0"

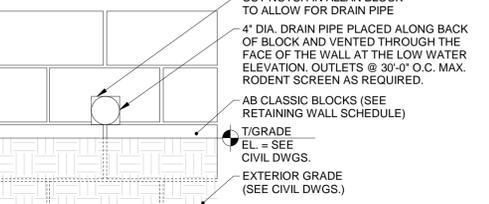


7 DRAIN PIPE DETAIL
1" = 1'-0"

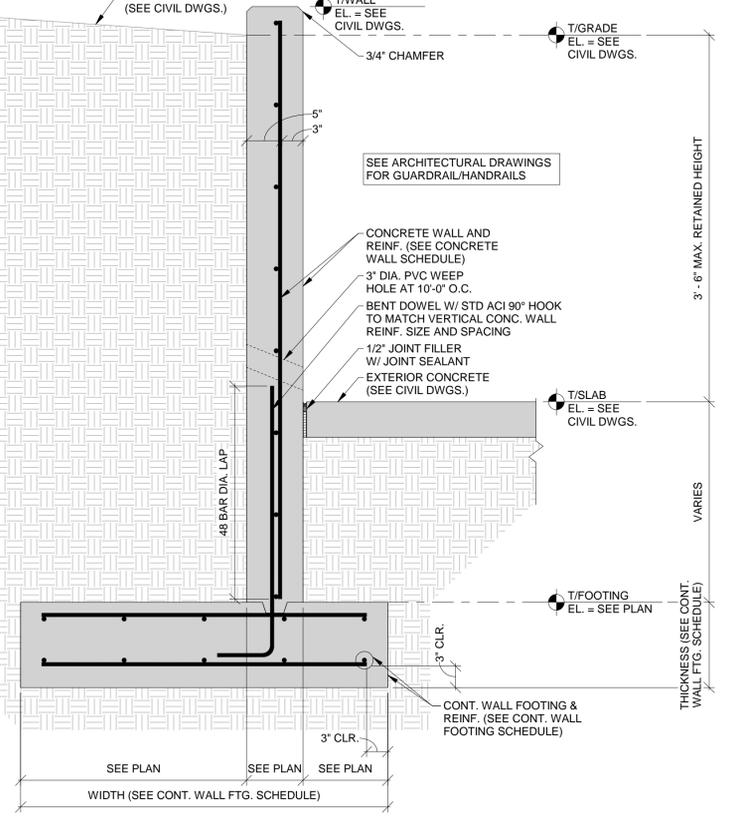


9 CONT. WALL FOOTING @ CONCRETE RETAINING WALL
1" = 1'-0"

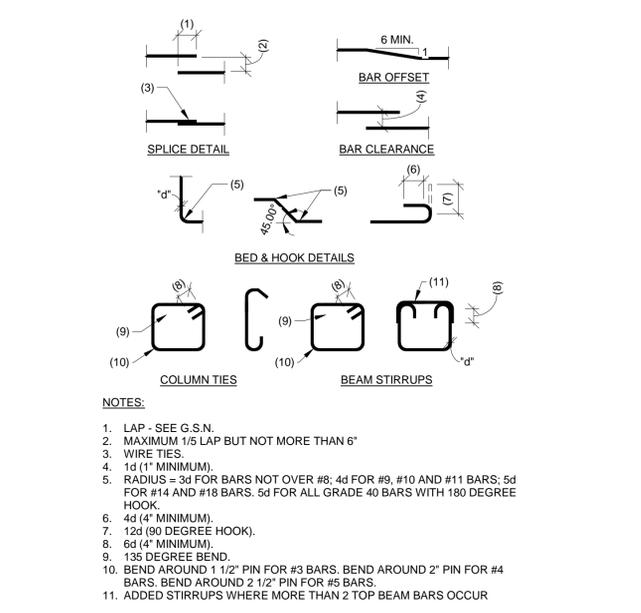


1 TYP. CONCRETE REINFORCING BAR DETAILS
3/4" = 1'-0"

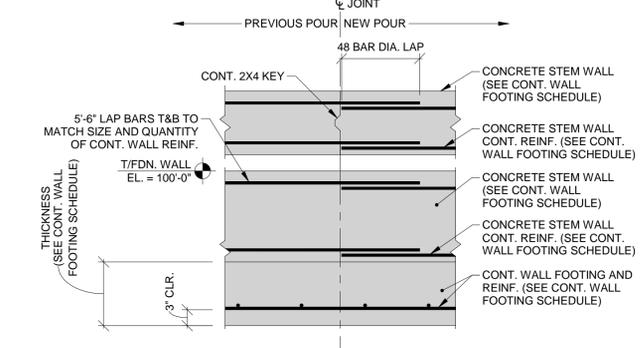


2 TYP. FOUNDATION WALL CONSTRUCTION JOINT
3/4" = 1'-0"

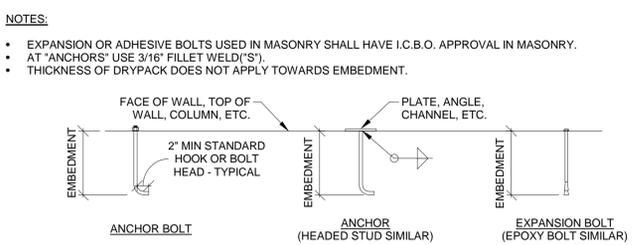

3 TYP. BOLTS IN MASONRY DETAIL
3/4" = 1'-0"

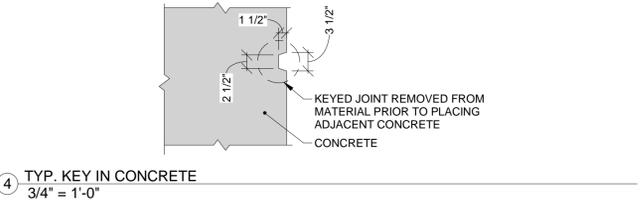


4 TYP. KEY IN CONCRETE
3/4" = 1'-0"

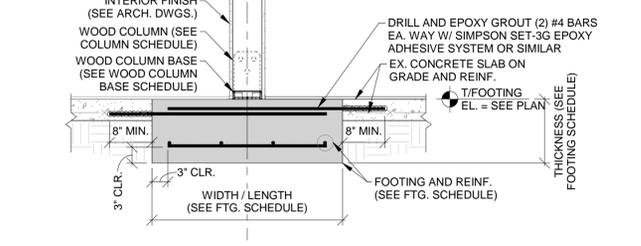


5 NEW INTERIOR WOOD COLUMN INTO EX. SLAB W/ FOOTING
3/4" = 1'-0"

GENERAL NOTES:

- PRESSURE TREATED SINGLE 2X CONT. WOOD SILL PLATE AND ANCHORAGE (SEE WOOD WALL OR WOOD SHEAR WALL SCHEDULE, SEE FDN. PLAN FOR T/CONC. ELEVATION)
- 2X WOOD STUDS @ 16" O.C. (U.N.O.) W/ (2) 16d END NAILS OR 8d TOE NAILS EA. END TO TOP AND SILL PLATES (SEE WOOD WALL OR WOOD SHEAR WALL SCHEDULE)
- CONT. DOUBLE 2X WOOD TOP PLATE (SEE WOOD WALL OR WOOD SHEAR WALL SCHEDULE), NAILED TOGETHER W/ 16d @ 16" O.C. (U.N.O.)
- AS A TEMPORARY BRACING, USE 1X4 OR 1X6 DIAGONAL LET-IN BRACE 2 EA. CORNER (OR NEAR THE CORNER) & @ MAX. 25' INTERVALS; ALT. SIMPSON WB STRAPS, INSTALLED IN PAIRS.
- NAIL BRACE TO PLATES, STUDS, & BLOCKING W/ (3) 8d @ EA. BR'G.
- MIN. 45, MAX 60; BRACE TO COVER MIN. (3) STUD SPACES.
- TOP PLATE SPLICES TO OCCUR DIRECTLY ABOVE STUD OR POST & SHALL LAP MIN. 6'-0"
- (2) 10d NAILS @ 4" O.C.
- 2X BLOCKING AS REQUIRED PER U.B.C.
- OPENING WHERE OCCURS (SEE ARCH. DWGS.)
- 2X TRIMMER W/ 16d @ 12" O.C. STAGGERED TO KING STUD EA. SIDE OF OPENING (U.N.O.)
- FULL HEIGHT (2) 2X KING STUDS EA. SIDE (SEE HEADER SCHEDULE)
- (2) 2X JACK STUDS EA. SIDE (SEE HEADER SCHEDULE)
- SIMPSON A35 ANGLE EA. SIDE (U.N.O.)
- HEADER (SEE HEADER SCHEDULE)
- CONT. 2X WOOD SILL PLATE W/ 16d NAILS @ 12" O.C. (NAILS SHALL BE @ 3" O.C. WHEN OPENING OCCURS @ WOOD SHEAR WALL)
- 2X WOOD CRIPPLE STUDS @ 16" O.C. (U.N.O.)
- CONT. 2X WOOD WINDOW SILL (U.N.O.)
- TOE NAILING
- PLYWOOD SHEAR PANEL (SEE WOOD WALL OR WOOD SHEAR WALL SCHEDULE)
- TYP. BRIDGING @ PANEL EDGES
- SHEAR WALL END POSTS (SEE WOOD SHEAR WALL SCHEDULE)
- EDGE NAILING (SEE WOOD WALL OR WOOD SHEAR WALL SCHEDULE)
- INTERMEDIATE NAILING (SEE WOOD WALL OR WOOD SHEAR WALL SCHEDULE)
- EXTEND PLYWOOD ABOVE TOP PLATE IF INDICATED ON PLAN OR DETAILS.
- HOLD-DOWN OR POST ANCHOR (SEE HOLD-DOWN SCHEDULE)
- NAIL CORNER & MULTIPLE STUDS TOGETHER W/ 16d @ 12" O.C. STAGGERED.
- CORNER STUDS OR POST PER PLAN
- SIMPSON CS16 STRAP TO CONNECT HEADER AND FIRST STUD THAT IS NOT A JACK OR KING STUD

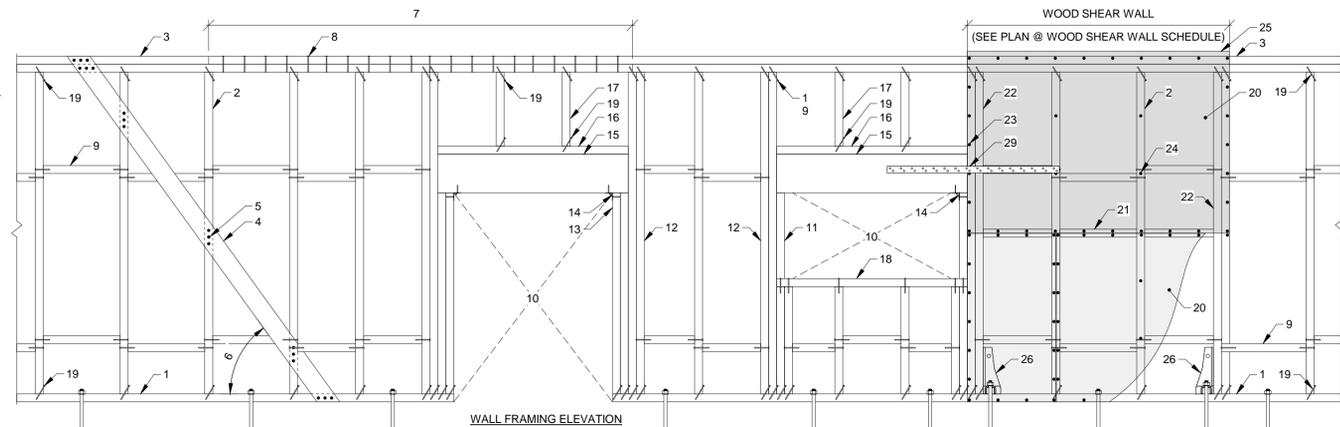


WALL FRAMING ELEVATION
CORNER STUDS
WALL INTERSECTION
SHEAR WALL INTERSECTION
CORNER @ SHEAR WALL

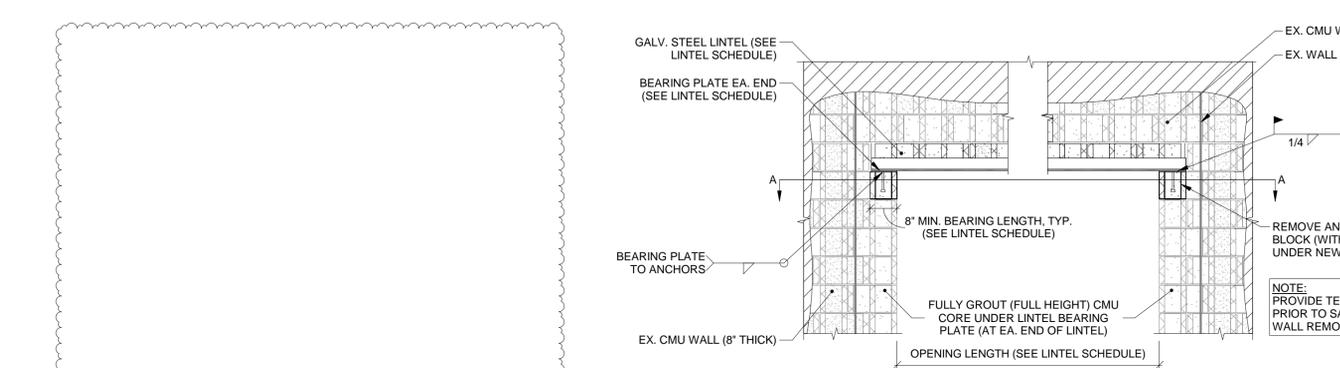

1 TYP. WOOD STUD WALL FRAMING
3/4" = 1'-0"
12 TYP. HEADER DETAIL
3/4" = 1'-0"




13 EX. JOISTS TO NEW PSL BEAM
1" = 1'-0"
14 EX. JOISTS TO NEW BEAM
1" = 1'-0"

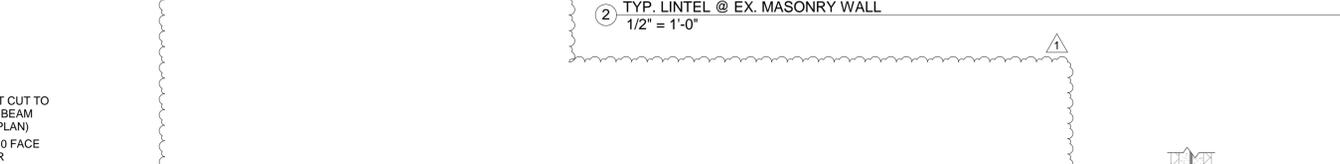


24 WOOD BEAM TO WOOD BEAM @ RAMP LANDING
1" = 1'-0"




25 DECK LANDING @ EX. MASONRY WALL
1" = 1'-0"

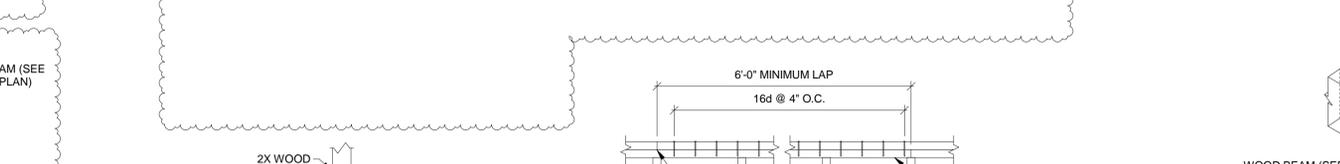


6 TYP. SPLICE OF TOP PLATES
3/4" = 1'-0"

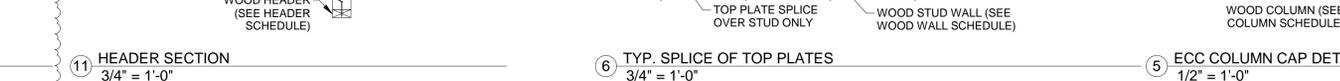


5 ECC COLUMN CAP DETAIL
1/2" = 1'-0"

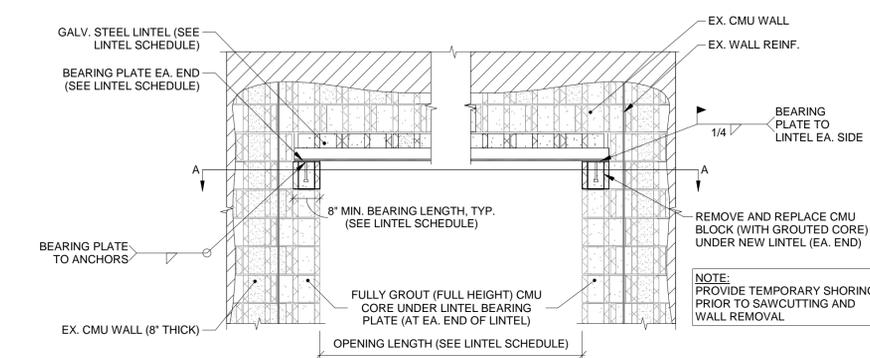


2 TYP. LINTEL @ EX. MASONRY WALL
1/2" = 1'-0"

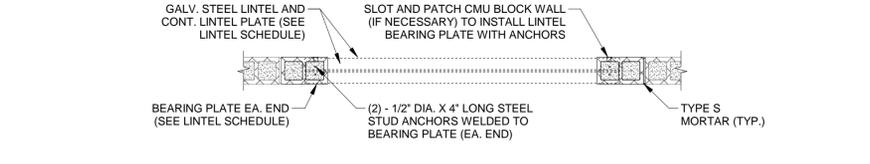


SECTION A-A

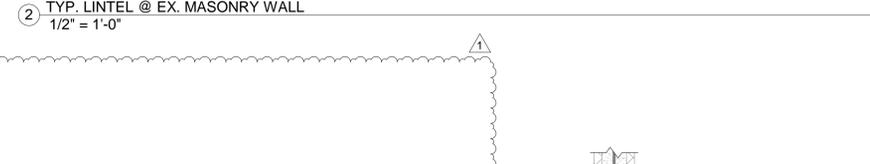


3 TYP. DOUBLE ANGLE LINTEL SECTION
3/4" = 1'-0"

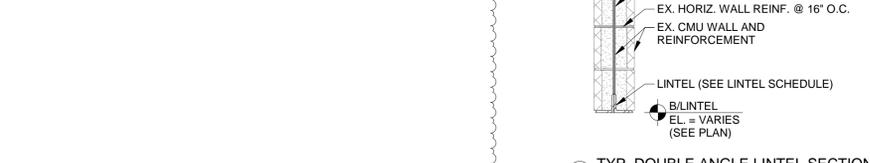


WELD EX. VERTICAL WALL REINF. TO LINTEL (TYP.)
EX. HORIZ. WALL REINF. @ 16" O.C.
EX. CMU WALL AND REINFORCEMENT
LINTEL (SEE LINTEL SCHEDULE)
B/LINTEL EL. = VARIES (SEE PLAN)

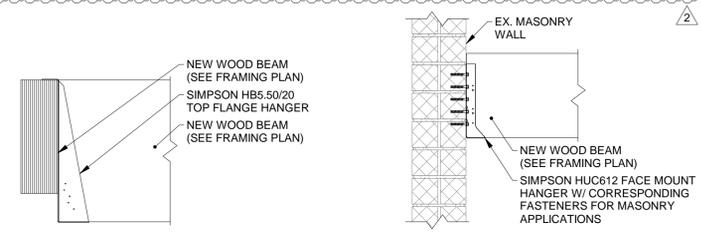


21 PSL TO PSL BEAM CONN.
1" = 1'-0"

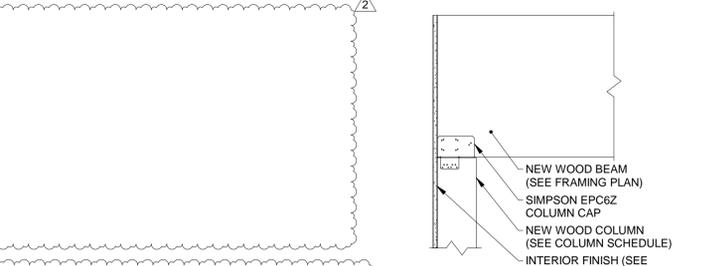


17 NEW PSL WOOD BEAM TO EX. WALL
1" = 1'-0"

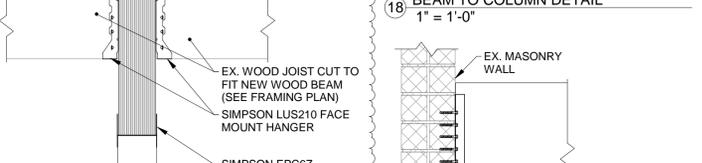

18 BEAM TO COLUMN DETAIL
1" = 1'-0"

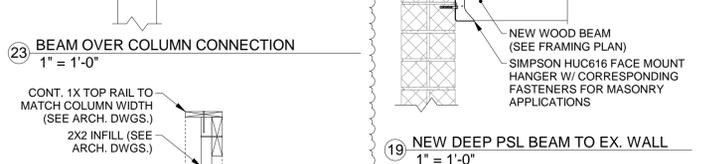

23 BEAM OVER COLUMN CONNECTION
1" = 1'-0"

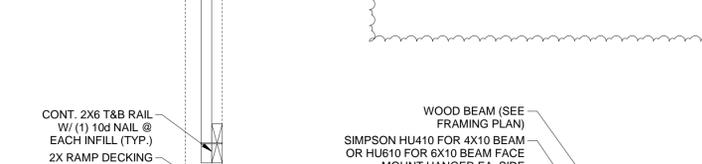

19 NEW DEEP PSL BEAM TO EX. WALL
1" = 1'-0"




13 EX. JOISTS TO NEW PSL BEAM
1" = 1'-0"




14 EX. JOISTS TO NEW BEAM
1" = 1'-0"




24 WOOD BEAM TO WOOD BEAM @ RAMP LANDING
1" = 1'-0"

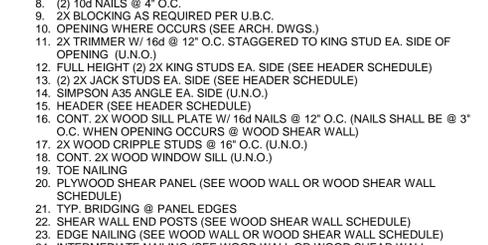

NEW WOOD BEAM TO EX. MASONRY WALL
NEW WOOD BEAM (SEE FRAMING PLAN)
SIMPSON HUC612 FACE MOUNT HANGER W/ CORRESPONDING FASTENERS FOR MASONRY APPLICATIONS

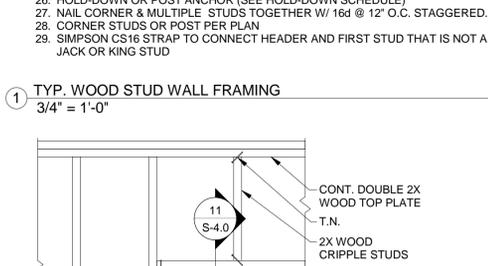


NEW WOOD BEAM TO EX. MASONRY WALL
NEW WOOD BEAM (SEE FRAMING PLAN)
SIMPSON EPC6Z COLUMN CAP
NEW WOOD COLUMN (SEE COLUMN SCHEDULE)
INTERIOR FINISH (SEE ARCH. DWGS.)

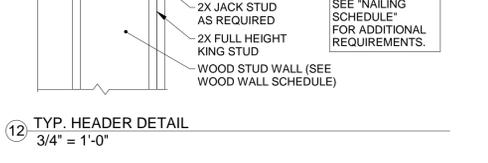

NEW WOOD BEAM TO EX. MASONRY WALL
NEW WOOD BEAM (SEE FRAMING PLAN)
SIMPSON HUC616 FACE MOUNT HANGER W/ CORRESPONDING FASTENERS FOR MASONRY APPLICATIONS




NEW WOOD BEAM TO EX. MASONRY WALL
NEW WOOD BEAM (SEE FRAMING PLAN)
SIMPSON HUC616 FACE MOUNT HANGER W/ CORRESPONDING FASTENERS FOR MASONRY APPLICATIONS

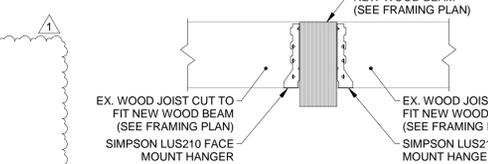


NEW WOOD BEAM TO EX. MASONRY WALL
NEW WOOD BEAM (SEE FRAMING PLAN)
SIMPSON HUC616 FACE MOUNT HANGER W/ CORRESPONDING FASTENERS FOR MASONRY APPLICATIONS




NEW WOOD BEAM TO EX. MASONRY WALL
NEW WOOD BEAM (SEE FRAMING PLAN)
SIMPSON HUC616 FACE MOUNT HANGER W/ CORRESPONDING FASTENERS FOR MASONRY APPLICATIONS

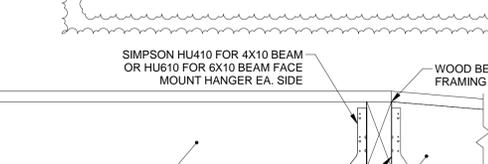


NEW WOOD BEAM TO EX. MASONRY WALL
NEW WOOD BEAM (SEE FRAMING PLAN)
SIMPSON HUC616 FACE MOUNT HANGER W/ CORRESPONDING FASTENERS FOR MASONRY APPLICATIONS

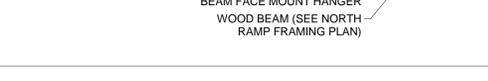


NEW WOOD BEAM TO EX. MASONRY WALL
NEW WOOD BEAM (SEE FRAMING PLAN)
SIMPSON HUC616 FACE MOUNT HANGER W/ CORRESPONDING FASTENERS FOR MASONRY APPLICATIONS

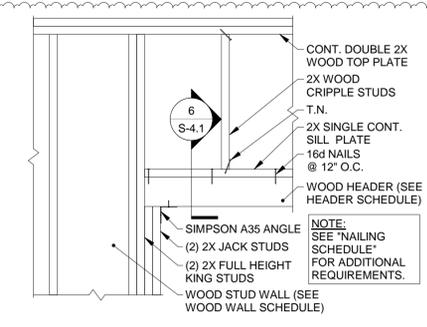


8 TYP. WOOD HEADER
3/4" = 1'-0"

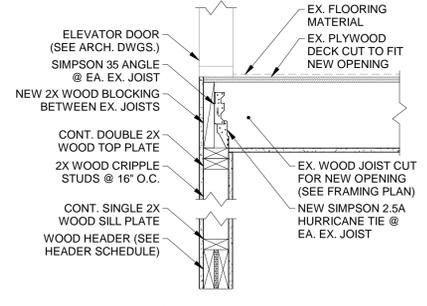


9 EX. WOOD JOIST @ NEW WOOD HEADER
1" = 1'-0"

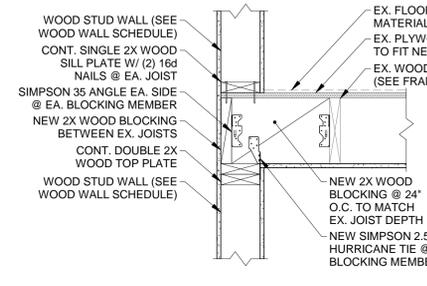


10 EX. WOOD JOIST PARALLEL TO NEW WOOD STUD WALL
1" = 1'-0"

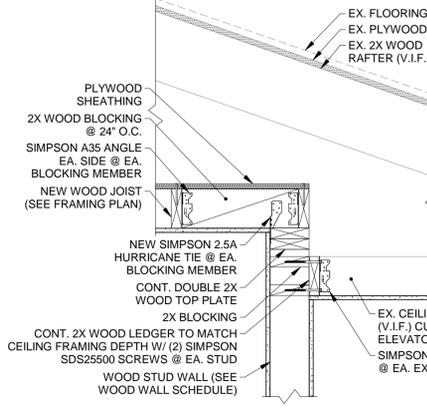


11 EX. CEILING JOISTS TO NEW WOOD STUD WALL
1" = 1'-0"

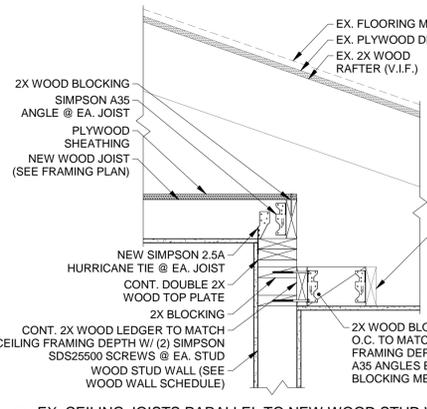


12 EX. CEILING JOISTS PARALLEL TO NEW WOOD STUD WALL
1" = 1'-0"

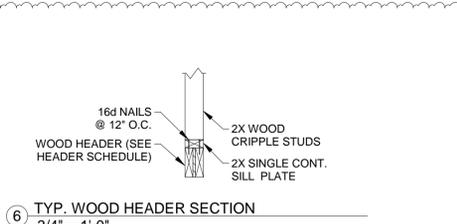


6 TYP. WOOD HEADER SECTION
3/4" = 1'-0"

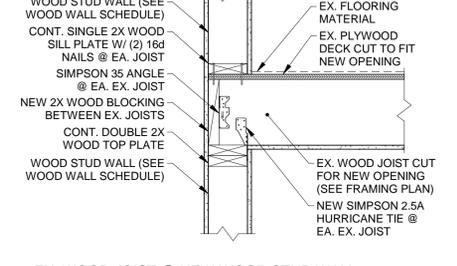


7 EX. WOOD JOIST @ NEW WOOD STUD WALL
1" = 1'-0"

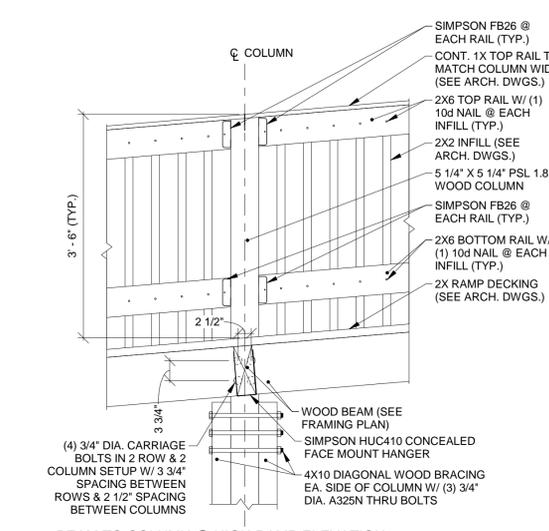


3 BEAM TO COLUMN @ HIGH RAMP ELEVATION
3/4" = 1'-0"

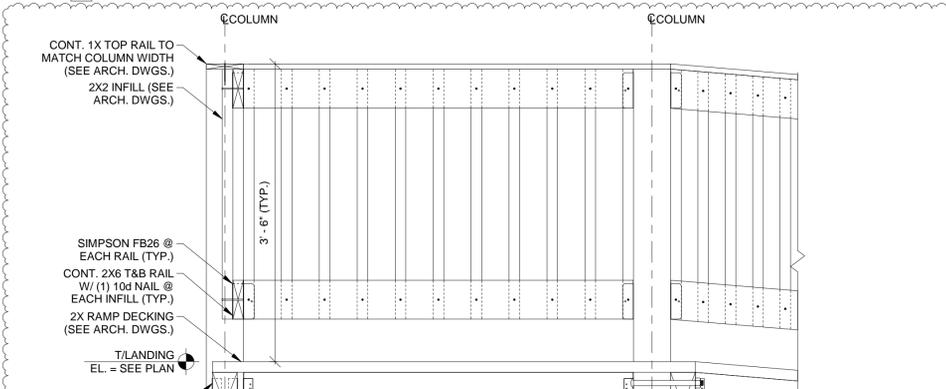


4 WOOD BEAMS @ WOOD POSTS
1" = 1'-0"

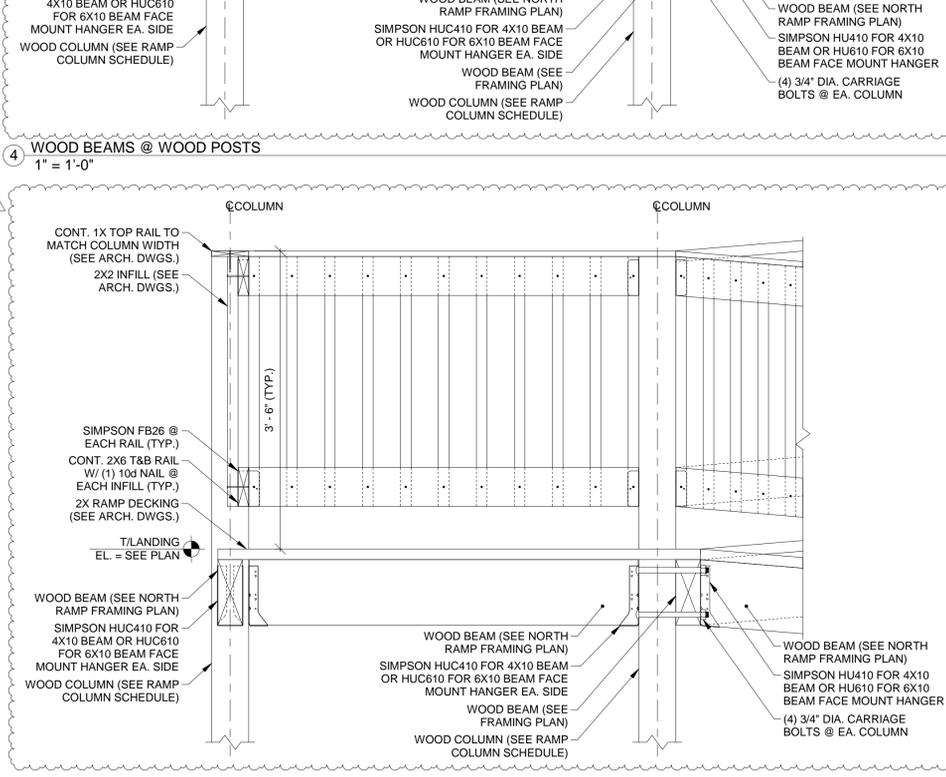

5 WOOD BEAMS AT WOOD POSTS
1" = 1'-0"

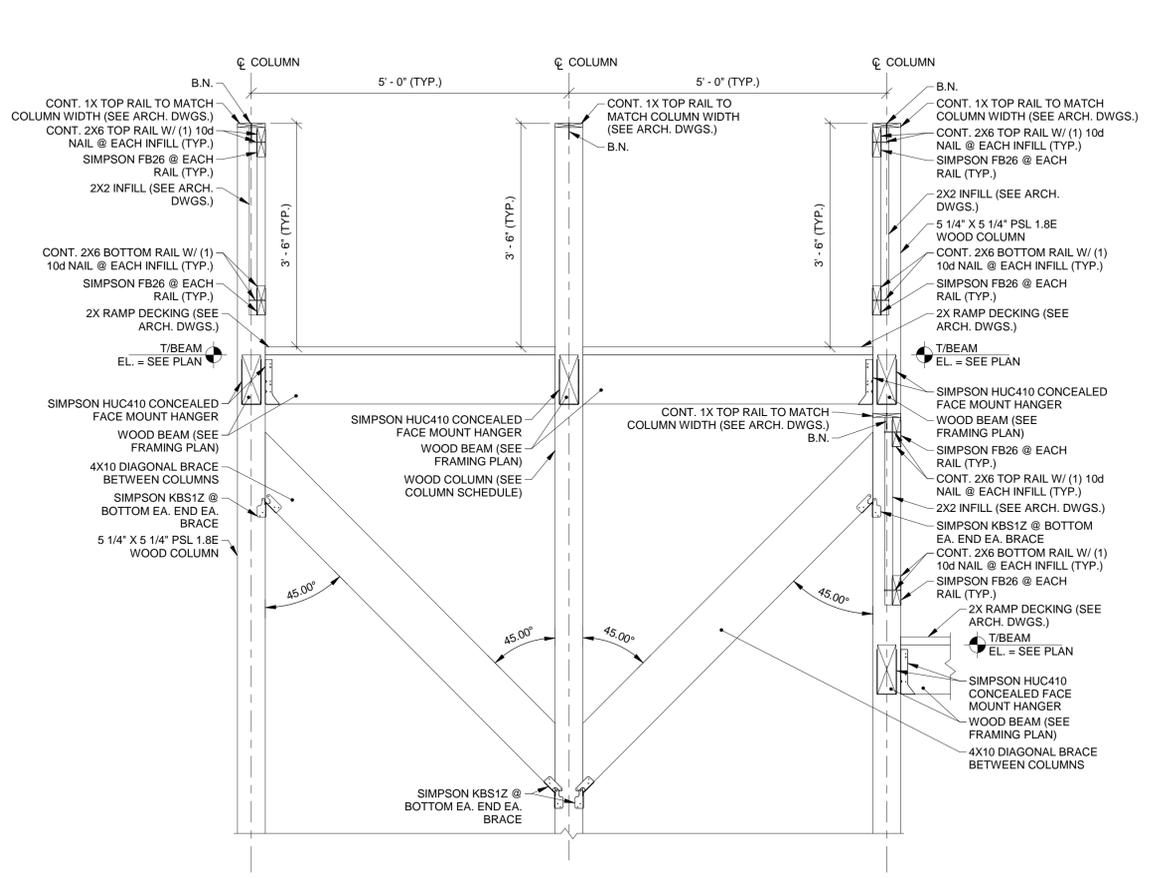

1 RAMP SECTION @ LANDING
3/4" = 1'-0"

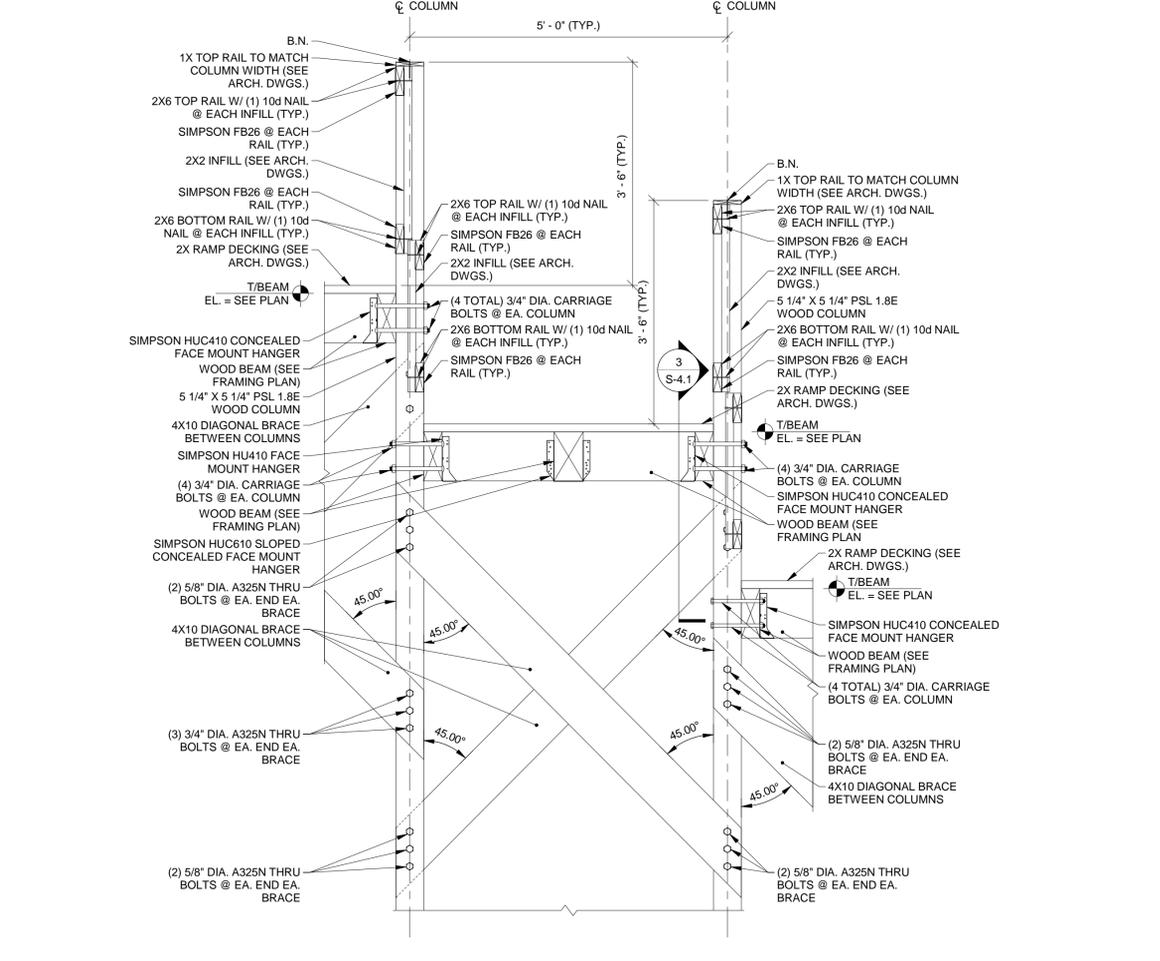

2 RAMP SECTION @ SLOPE
3/4" = 1'-0"

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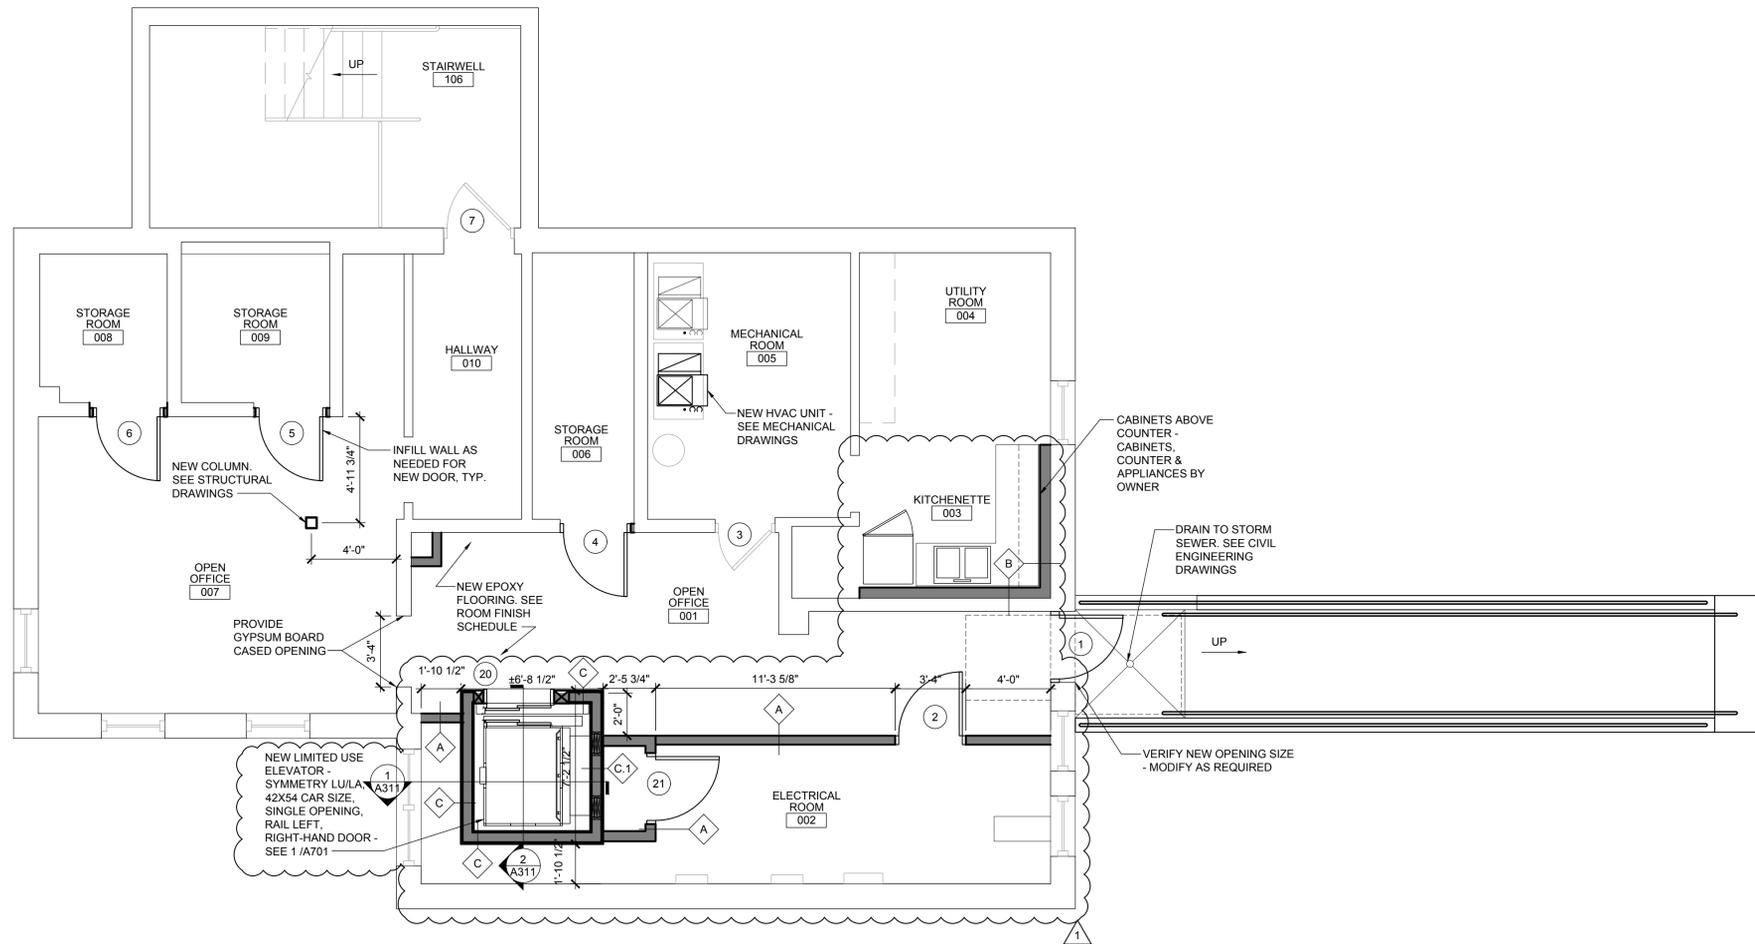
STRUCTURAL ENGINEER
 JEFFERY S. GUTOWSKY
 061-005847
 STATE OF ILLINOIS
 SIGNED: 8/27/21
 Exp: 1/30/2022

HOFFMAN ESTATES PARK DISTRICT
 650 W HIGGINS ROAD
 HOFFMAN ESTATES, IL 60109
VOGELI HOUSE REMODEL



ISSUE
 TO PERMIT DATE
 PERMIT 1 7/21/21
 PERMIT 2 8/6/21
 ADDENDUM 2 8/27/21

CHECK: SMD
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S-4.1
 FRAMING DETAILS


1 BASEMENT FLOOR PLAN
SCALE: 1/4" = 1'-0"



- ### FLOOR PLAN GENERAL NOTES
- ALL CONTRACTORS TO VERIFY EXISTING SITE CONDITIONS AND DIMENSIONS BEFORE ANY WORK IS TO BEGIN. NOTIFY ARCHITECT OF DISCREPANCIES.
 - ALL WORK TO BE DONE IN ACCORDANCE WITH ALL GOVERNING STATE AND LOCAL CODES, ORDINANCES, AND AMENDMENTS.
 - WATER RESISTANT GYPSUM BOARD OR CEMENT BOARD SHALL BE USED AT ALL WALLS IN TOILET ROOM, BEHIND ALL PLUMBING FIXTURES, AND ANY WET LOCATIONS - SEE PARTITION SCHEDULE FOR MORE INFORMATION.
 - PROVIDE ALL REQUIRED IN WALL BLOCKING FOR ALL WALL MOUNTED EQUIPMENT, MILLWORK, SHELVING, AND ACCESSORIES.
 - MOUNT ALL FIXTURES & ACCESSORIES AT HEIGHTS CONFORMING WITH ALL GOVERNING CODES & ACCESSIBILITY REQUIREMENTS.
 - ALL WOOD BLOCKING AND PLYWOOD TO BE FIRE TREATED.
 - FIRE EXTINGUISHERS ARE SUPPLIED AND INSTALLED BY THE G.C. QUANTITIES AND LOCATIONS TO BE COORDINATED W/ THE LOCAL FIRE DEPARTMENT.
 - COORDINATE SIZE AND LOCATION OF ALL DUCT SHAFT OPENINGS IN WALLS AND FLOORS. SEE MECHANICAL AND ELECTRICAL DRAWINGS.
 - ALL DIMENSIONS ARE NOMINAL & ARE FROM FACE OF GYPSUM BOARD, SHEATHING, OR SUBSTRATE.
 - REFER TO THE EQUIPMENT PLAN AND EQUIPMENT SCHEDULE FOR MORE INFORMATION ON THE EQUIPMENT. EQUIPMENT SHOWN ON THIS PLAN IS FOR REFERENCE ONLY.
 - PROVIDE CONTINUOUS BEAD OF CLEAR SILICONE SEALANT AT INTERIOR SIDE OF ALL WALL TRANSITIONS. SEAL ALL NEW AND EXISTING OPENINGS IN FLOORS, STRUCTURAL DECK AND EXTERIOR WALLS IN ORDER TO PROVIDE A WEATHER TIGHT SEAL.
 - ALL WALLS ARE AT 90° UNLESS NOTED OTHERWISE.
 - PROPERLY PREPARE & CLEAN SUBSTRATES & SURFACES AS REQUIRED TO ACCEPT FINISHES, MATERIALS, TREATMENTS, ETC.
 - G.C. SHALL PROVIDE FINAL CLEANING OF STORE AT END OF CONSTRUCTION.

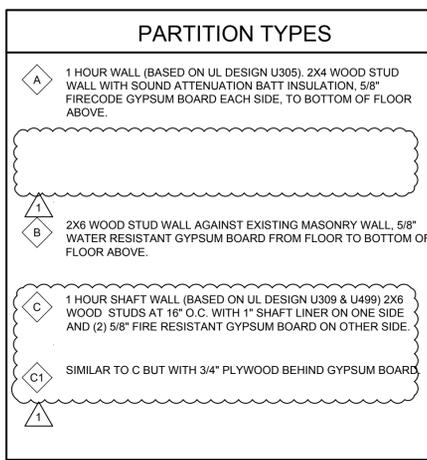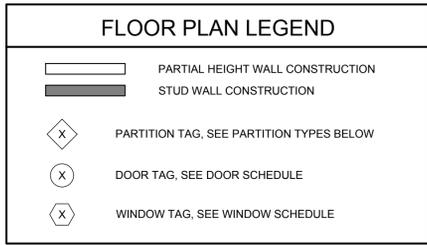

API ARCHITECTS
 2078 PARKWAY AVENUE
 OFFICE 312.505.1542
 60412
 Expires: November 30, 2020
 Hoffmann Estates Park District - Vogelei House Remodel
 650 WEST HIGGINS ROAD
 HOFFMAN ESTATES, IL 60169
 project no. D2100051
 date: 07.21.2021
 revision 1: 08.27.2021
 revision 2:
 revision 3:
 revision 4:
 checked: CJA
 drawn: JIB
 sheet title: BASEMENT FLOOR PLAN
 sheet number: A101

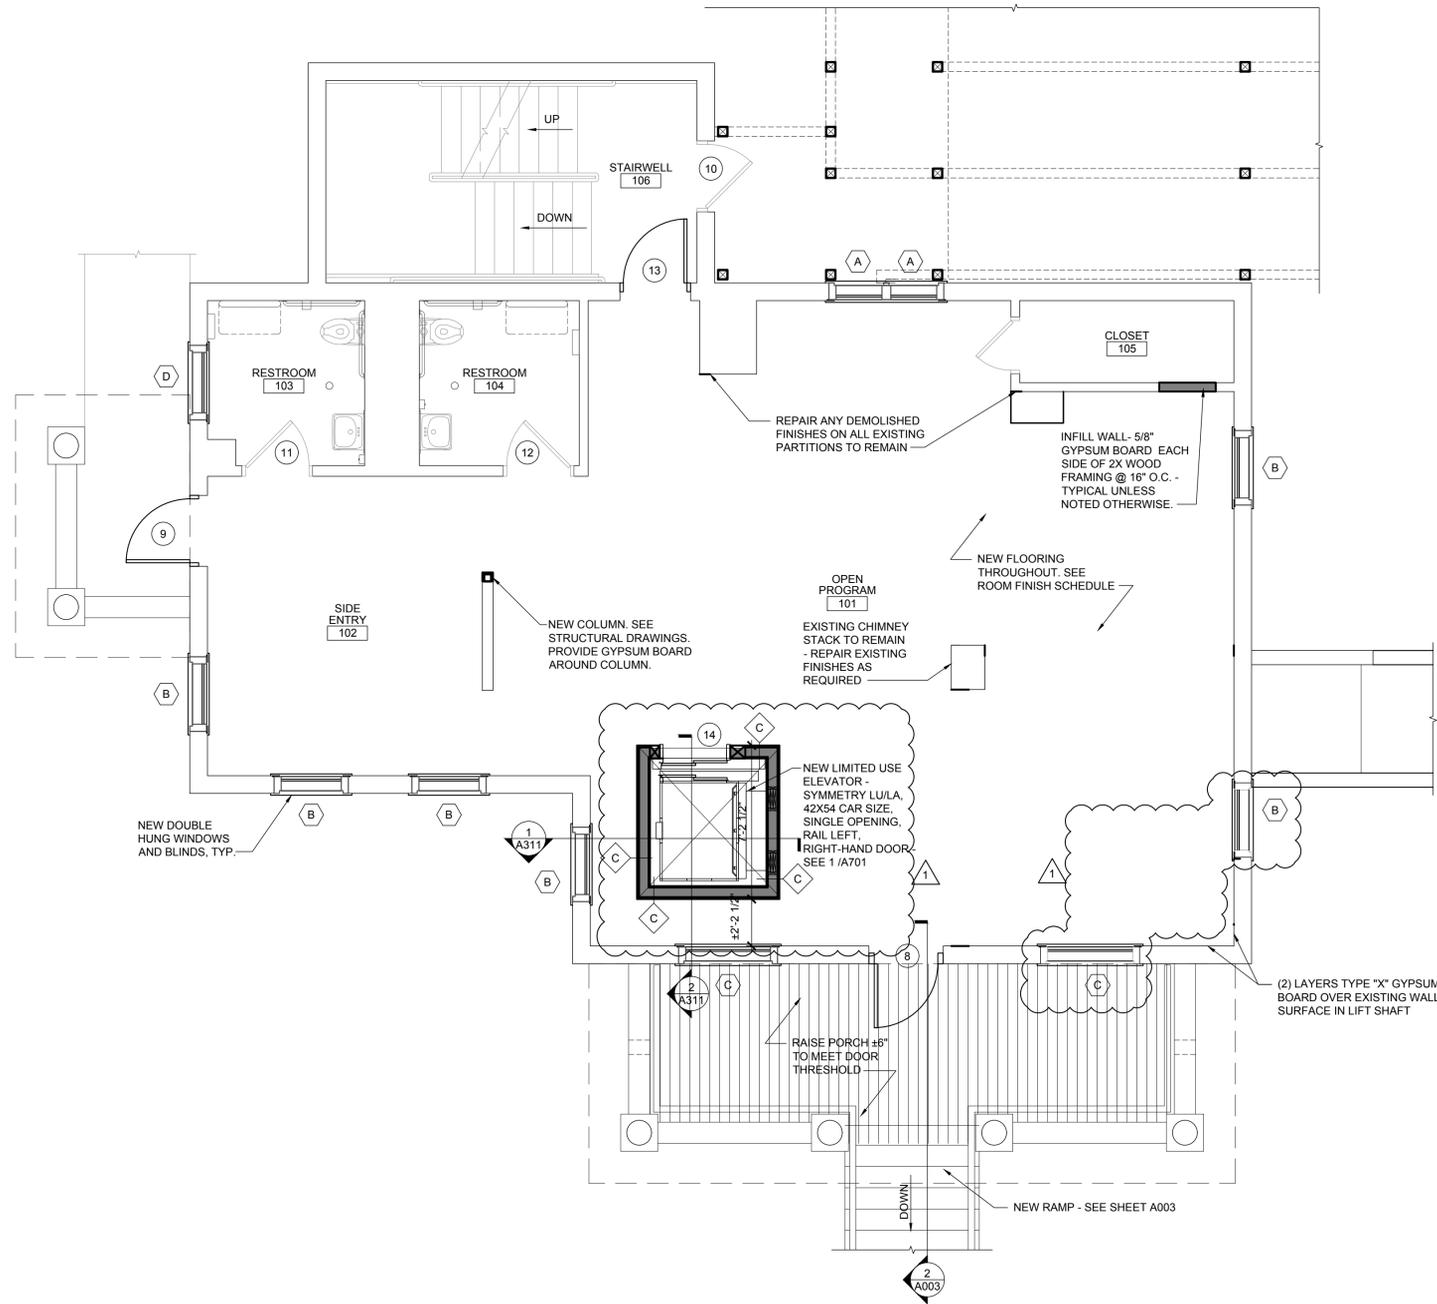

1 FIRST FLOOR PLAN
SCALE: 1/4" = 1'-0"



FLOOR PLAN GENERAL NOTES

- A. ALL CONTRACTORS TO VERIFY EXISTING SITE CONDITIONS AND DIMENSIONS BEFORE ANY WORK IS TO BEGIN. NOTIFY OWNER OF DISCREPANCIES.
- B. ALL WORK TO BE DONE IN ACCORDANCE WITH ALL GOVERNING STATE AND LOCAL CODES, ORDINANCES, AND AMENDMENTS.
- C. WATER RESISTANT GYPSUM BOARD OR CEMENT BOARD SHALL BE USED AT ALL WALLS IN TOILET ROOM, BEHIND ALL PLUMBING FIXTURES, AND ANY WET LOCATIONS - SEE PARTITION SCHEDULE FOR MORE INFORMATION.
- D. PROVIDE ALL REQUIRED IN WALL BLOCKING FOR ALL WALL MOUNTED EQUIPMENT, MILLWORK, SHELVING, AND ACCESSORIES.
- E. MOUNT ALL FIXTURES & ACCESSORIES AT HEIGHTS CONFORMING WITH ALL GOVERNING CODES & ACCESSIBILITY REQUIREMENTS.
- F. ALL WOOD BLOCKING AND PLYWOOD TO BE FIRE TREATED.
- G. FIRE EXTINGUISHERS ARE SUPPLIED AND INSTALLED BY THE G.C. QUANTITIES AND LOCATIONS TO BE COORDINATED W/ THE LOCAL FIRE DEPARTMENT.
- H. COORDINATE SIZE AND LOCATION OF ALL DUCT SHAFT OPENINGS IN WALLS AND FLOORS. SEE MECHANICAL AND ELECTRICAL DRAWINGS.
- I. ALL DIMENSIONS ARE NOMINAL & ARE FROM FACE OF GYPSUM BOARD, SHEATHING, OR SUBSTRATE.
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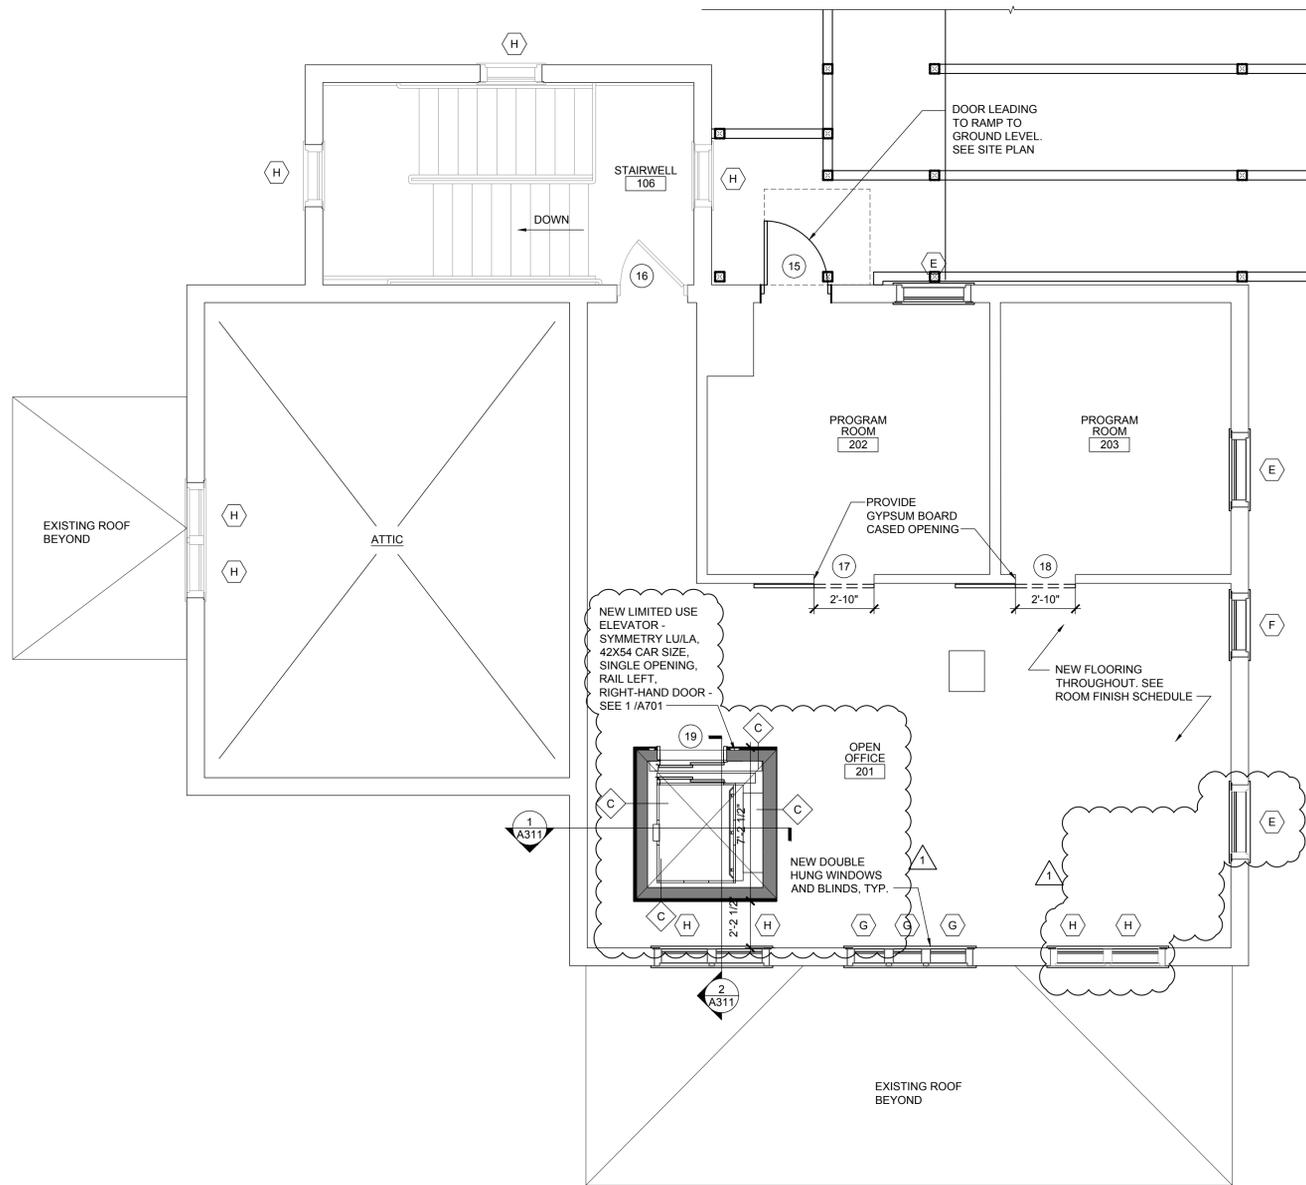
FLOOR PLAN LEGEND

- PARTIAL HEIGHT WALL CONSTRUCTION
- STUD WALL CONSTRUCTION
- PARTITION TAG, SEE PARTITION TYPES BELOW
- DOOR TAG, SEE DOOR SCHEDULE
- WINDOW TAG, SEE WINDOW SCHEDULE

PARTITION TYPES

- 1 HOUR WALL (BASED ON UL DESIGN U305) 2X4 WOOD STUD WALL WITH SOUND ATTENUATION BATT INSULATION, 5/8" FIRECODE GYPSUM BOARD EACH SIDE, TO BOTTOM OF FLOOR ABOVE.
- 2X6 WOOD STUD WALL AGAINST EXISTING MASONRY WALL, 5/8" WATER RESISTANT GYPSUM BOARD FROM FLOOR TO BOTTOM OF FLOOR ABOVE.
- 1 HOUR SHAFT WALL (BASED ON UL DESIGN U309 & U499) 2X6 WOOD STUDS AT 16" O.C. WITH 1" SHAFT LINER ON ONE SIDE AND (2) 5/8" FIRE RESISTANT GYPSUM BOARD ON OTHER SIDE.

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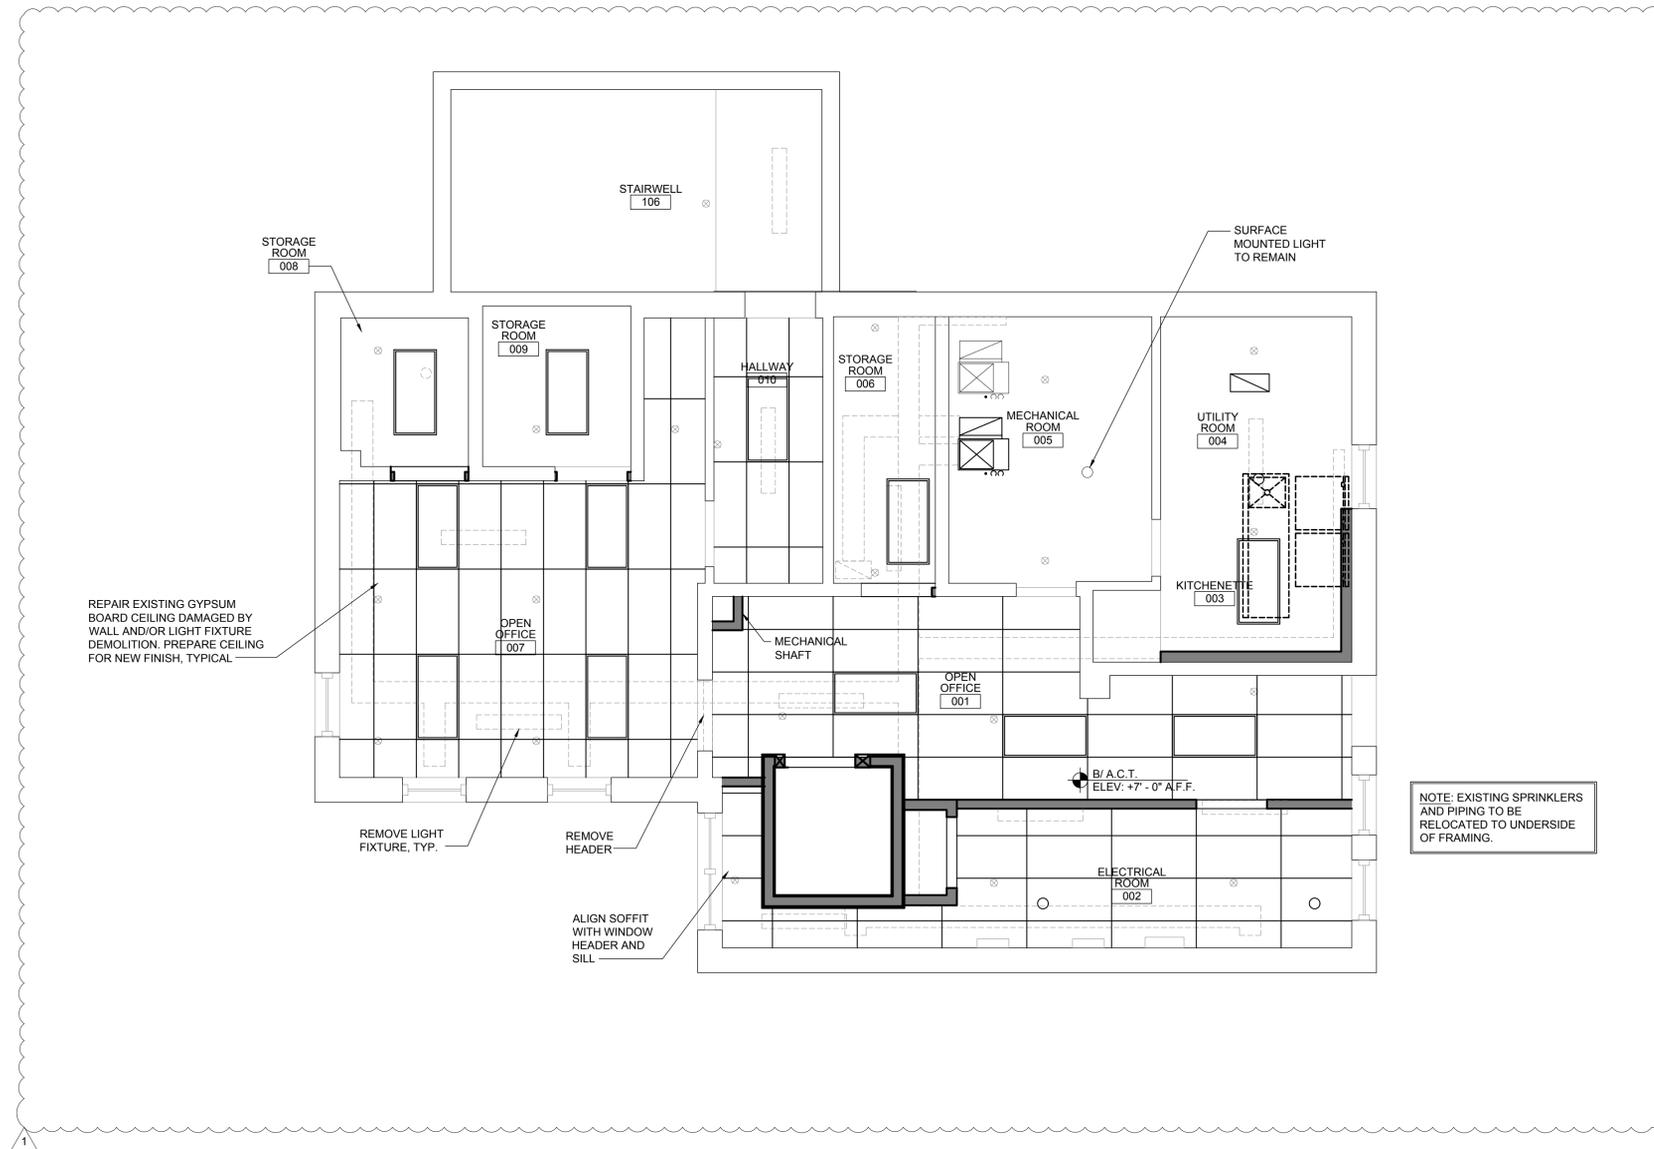
1 SECOND FLOOR PLAN
SCALE: 1/4" = 1'-0"



- ### FLOOR PLAN GENERAL NOTES
- ALL CONTRACTORS TO VERIFY EXISTING SITE CONDITIONS AND DIMENSIONS BEFORE ANY WORK IS TO BEGIN. NOTIFY OWNER OF DISCREPANCIES.
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- ### FLOOR PLAN LEGEND
- PARTIAL HEIGHT WALL CONSTRUCTION
 - STUD WALL CONSTRUCTION
 - PARTITION TAG, SEE PARTITION TYPES BELOW
 - DOOR TAG, SEE DOOR SCHEDULE
 - WINDOW TAG, SEE WINDOW SCHEDULE

- ### PARTITION TYPES
- 1 HOUR WALL (BASED ON UL DESIGN U395) 2X4 WOOD STUD WALL WITH SOUND ATTENUATION BATT INSULATION, 5/8" FIRECODE GYPSUM BOARD EACH SIDE, TO BOTTOM OF FLOOR ABOVE.
 - 2X6 WOOD STUD WALL AGAINST EXISTING MASONRY WALL, 5/8" WATER RESISTANT GYPSUM BOARD FROM FLOOR TO BOTTOM OF FLOOR ABOVE.
 - 1 HOUR SHAFT WALL (BASED ON UL DESIGN U309 & U499) 2X6 WOOD STUDS AT 16" O.C. WITH 1" SHAFT LINER ON ONE SIDE AND (2) 5/8" FIRE RESISTANT GYPSUM BOARD ON OTHER SIDE.




- ### REFLECTED CEILING PLAN GENERAL NOTES
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 - C. ALL DIMENSIONS ARE FROM FACE OF SUBSTRATE UNLESS NOTED OTHERWISE.
 - D. ALL CEILING HEIGHTS ARE TAKEN FROM PROJECT 0'-0".
 - E. SEE ELECTRICAL DRAWINGS FOR LIGHTING SCHEDULE AND SPECIFICATIONS.
 - F. PLACE ALL LIGHT FIXTURES IN THE CENTER OF TILES UNLESS NOTED OTHERWISE. ALIGN ALL FIXTURES IN THESE AREAS IN BOTH DIRECTIONS AND LAYOUT GRID AS SHOWN ON THE DRAWINGS SO THAT ALIGNMENT IS CONSISTENT. FIELD VERIFY GRID LAYOUT FOR PROPER FIXTURE LAYOUT.
 - G. COORDINATE LOCATION OF LIGHT FIXTURES AND POWER SUPPLY WITH ELECTRICAL DRAWINGS.
 - H. CONTRACTOR TO SUBMIT LIGHTING CUTS TO OWNER FOR APPROVAL PRIOR TO ORDERING. CONTRACTOR SHALL VERIFY LIGHTING CATALOG NUMBER WITH ELECTRICAL DRAWINGS AND NOTIFY THE OWNER OF ANY DISCREPANCIES.
 - I. GENERAL CONTRACTOR TO COORDINATE LIGHT FIXTURE CLEARANCE REQUIREMENTS WITH ABOVE CEILING UTILITIES, I.E. PLUMBING, CONDUIT & DUCTWORK, BEFORE COMMENCING WORK.
 - J. PAINT ALL EXPOSED DUCT WORK, PIPING, CONDUIT, AS INDICATED ON THE REFLECTED CEILING PLANS, FLOOR PLANS, AND ELEVATIONS.
 - K. PAINT ALL DIFFUSERS TO MATCH ADJACENT CEILING FINISHES UNLESS NOTED OTHERWISE.
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 - N. GENERAL CONTRACTOR TO PROVIDE POWER FOR EXTERIOR SIGNAGE. COORDINATE WITH TENANT'S SIGNAGE CONTRACTOR.
 - O. GENERAL CONTRACTOR TO INSTALL CONDUIT AND PULL STRINGS IN CEILING AS REQUIRED BY CODE FOR LOW VOLTAGE SYSTEMS. COORDINATE WITH OWNER'S SOUND SYSTEM VENDOR AND SECURITY CAMERA VENDOR.
 - P. GENERAL CONTRACTOR TO COORDINATE LOCATION OF ALL FIRE ALARM DEVICES PRIOR TO INSTALLATION.

REFLECTED CEILING PLAN LEGEND

XXX ELEV: 'X' - 'X"	INDICATES CEILING HEIGHT
[Symbol]	4'-0" SURFACE MOUNT LIGHT FIXTURE. SEE ELECTRICAL DRAWINGS
[Symbol]	2'-0" x 4'-0" LAY-IN LIGHT FIXTURE. SEE ELECTRICAL DRAWINGS
○	RECESSED DOWN LIGHT. SEE ELECTRICAL DRAWINGS
○	SURFACE MOUNTED SINGLE BULB LIGHT SOCKET. SEE ELECTRICAL DRAWINGS
⊗	EMERGENCY EXIT SIGN. SEE ELECTRICAL DRAWINGS
●	SPRINKLER HEAD

1 BASEMENT REFLECTED CEILING PLAN
SCALE: 1/4" = 1'-0"



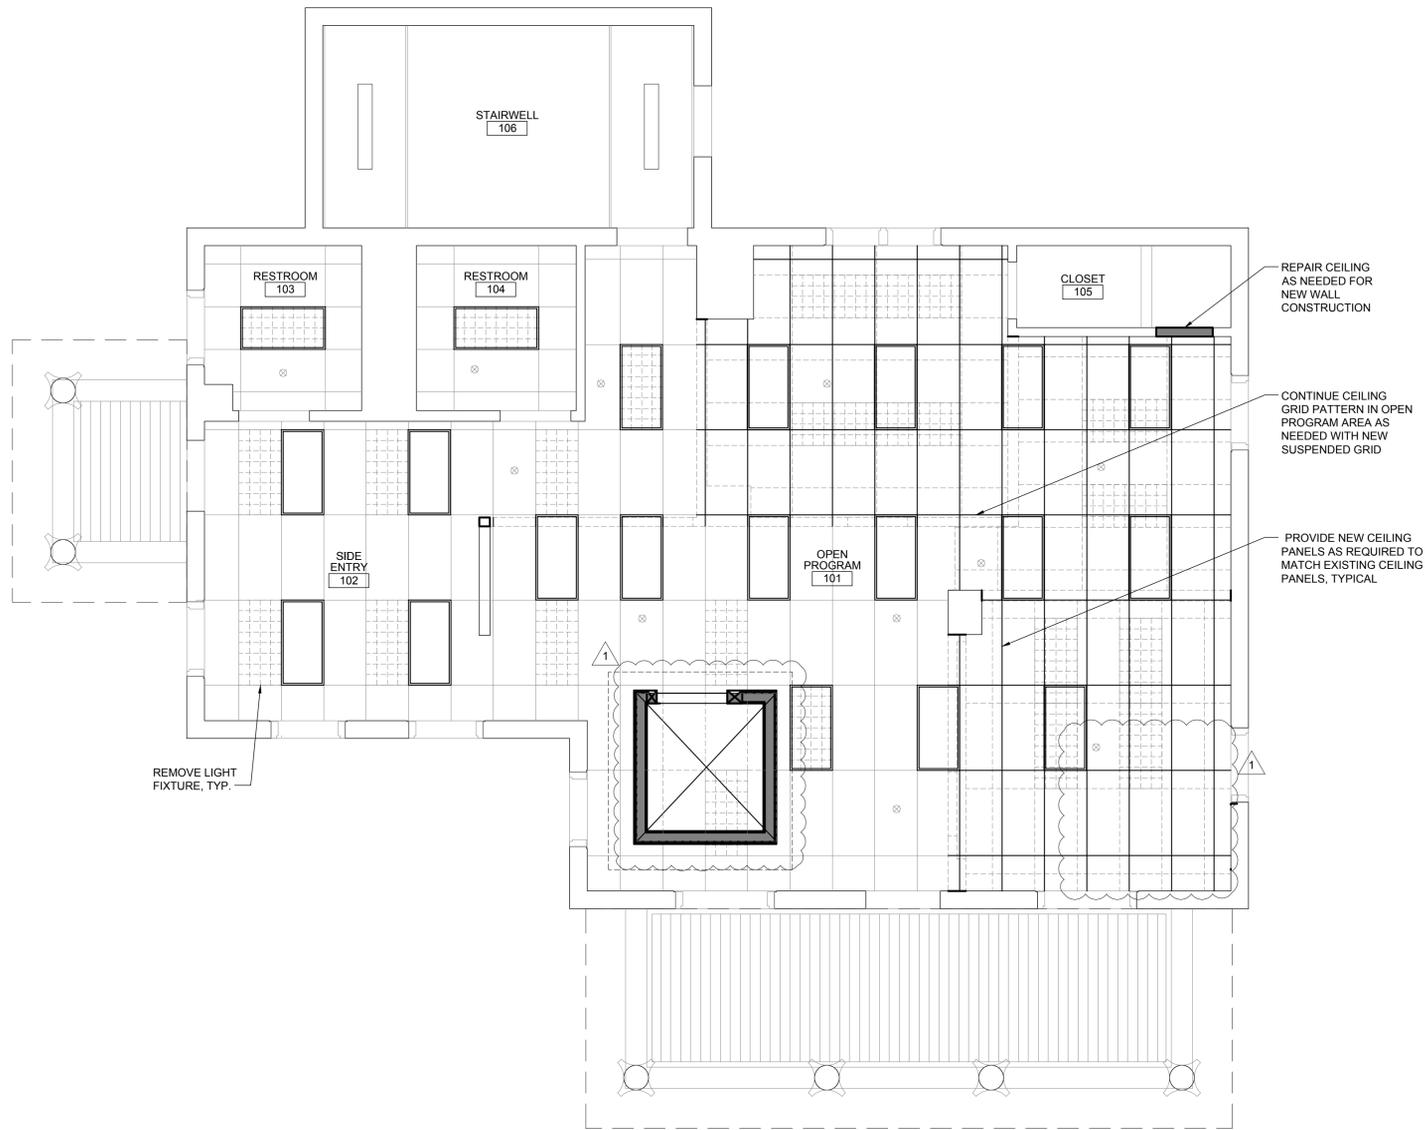

1 FIRST FLOOR REFLECTED CEILING PLAN
SCALE: 1/4" = 1'-0"




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REFLECTED CEILING PLAN LEGEND

- 
 INDICATES CEILING HEIGHT
- 
 4'-0" SURFACE MOUNT LIGHT FIXTURE, SEE ELECTRICAL DRAWINGS
- 
 2'-0" x 4'-0" LAY-IN LIGHT FIXTURE, SEE ELECTRICAL DRAWINGS
- 
 RECESSED DOWN LIGHT, SEE ELECTRICAL DRAWINGS
- 
 SURFACE MOUNTED SINGLE BULB LIGHT SOCKET, SEE ELECTRICAL DRAWINGS
- 
 EMERGENCY EXIT SIGN, SEE ELECTRICAL DRAWINGS
- 
 SPRINKLER HEAD



REFLECTED CEILING PLAN GENERAL NOTES

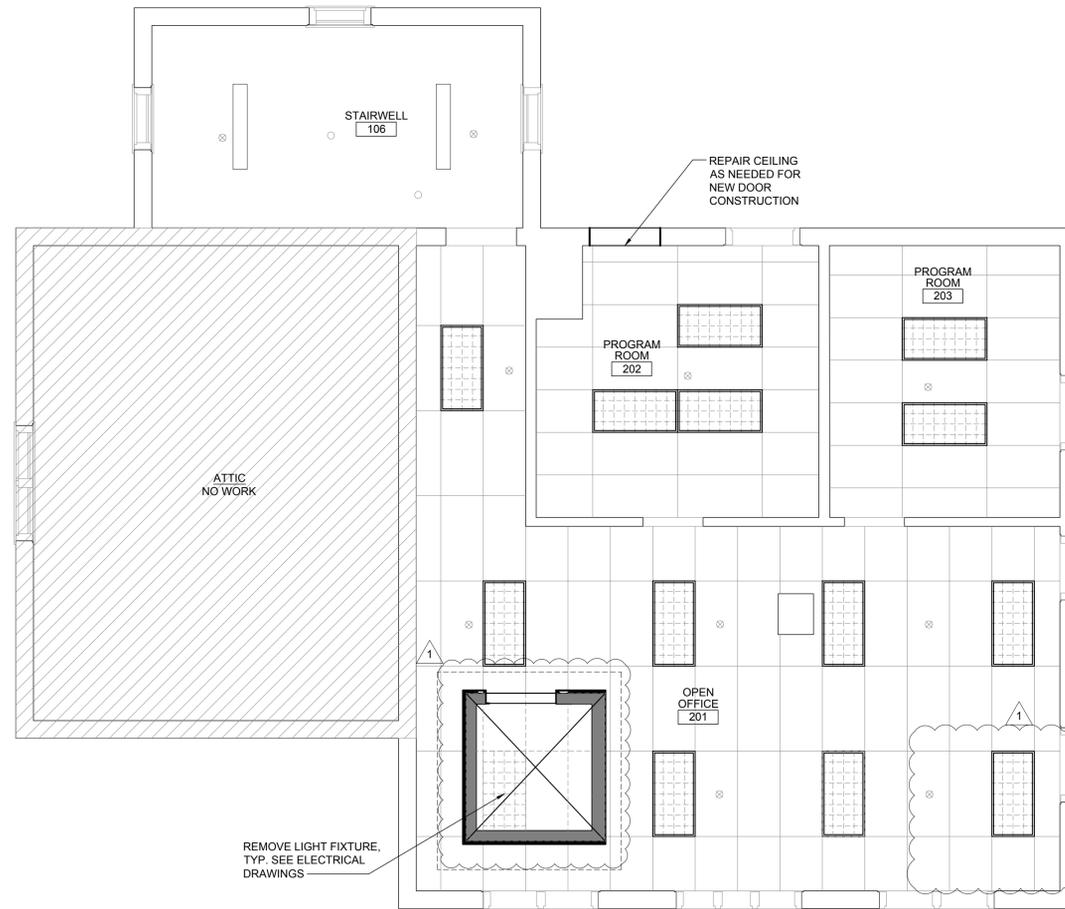
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- 2'-0" x 4'-0" LAY-IN LIGHT FIXTURE, SEE ELECTRICAL DRAWINGS
- RECESSED DOWN LIGHT, SEE ELECTRICAL DRAWINGS
- SURFACE MOUNTED SINGLE BULB LIGHT SOCKET, SEE ELECTRICAL DRAWINGS
- EMERGENCY EXIT SIGN, SEE ELECTRICAL DRAWINGS
- SPRINKLER HEAD

1 SECOND FLOOR REFLECTED CEILING PLAN
SCALE: 3/16" = 1'-0"







1 WEST ELEVATION
SCALE: 3/16" = 1'-0"

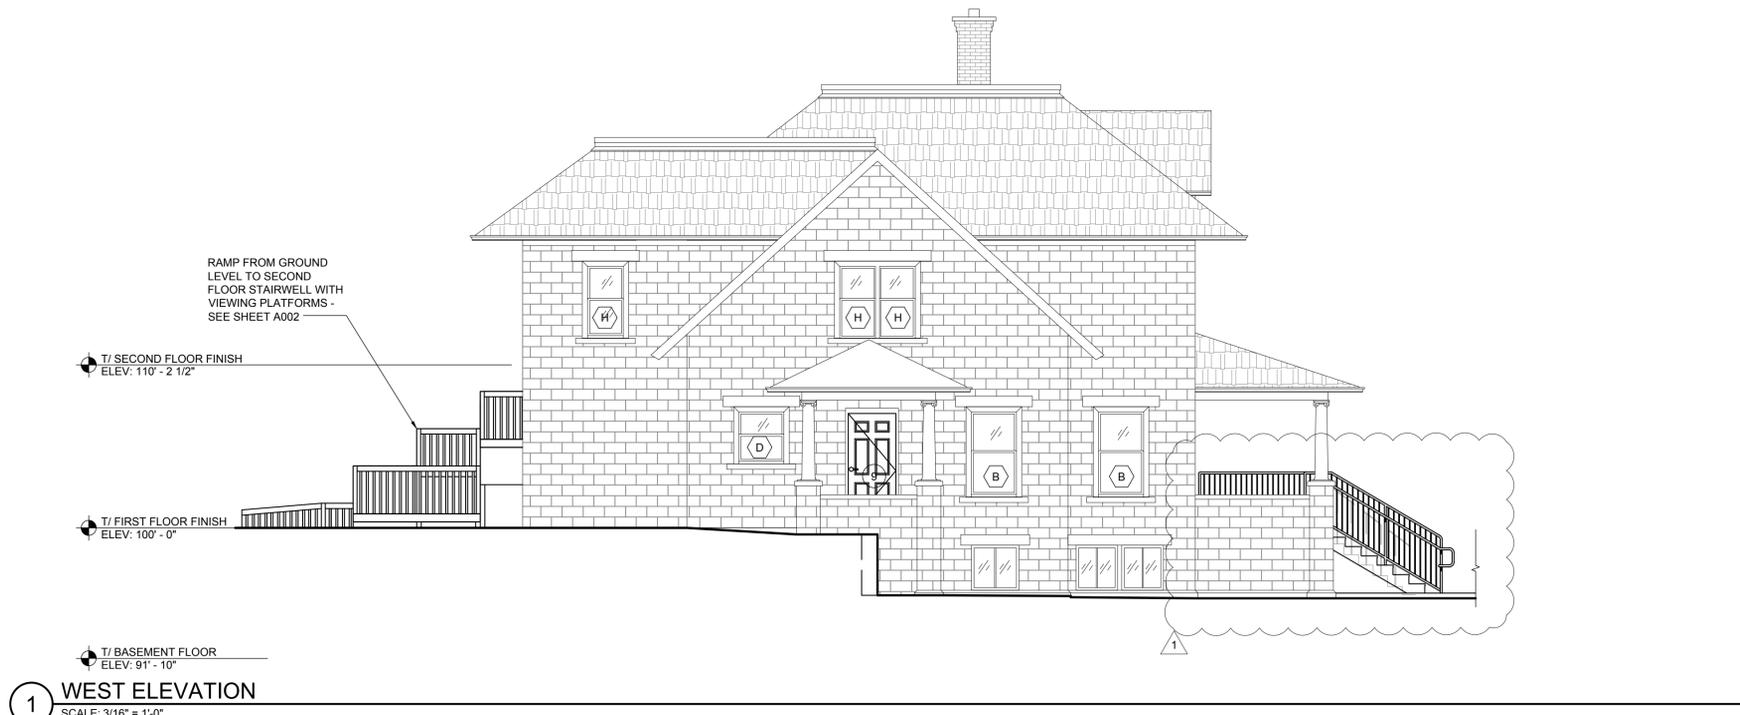

2 SOUTH ELEVATION
SCALE: 3/16" = 1'-0"

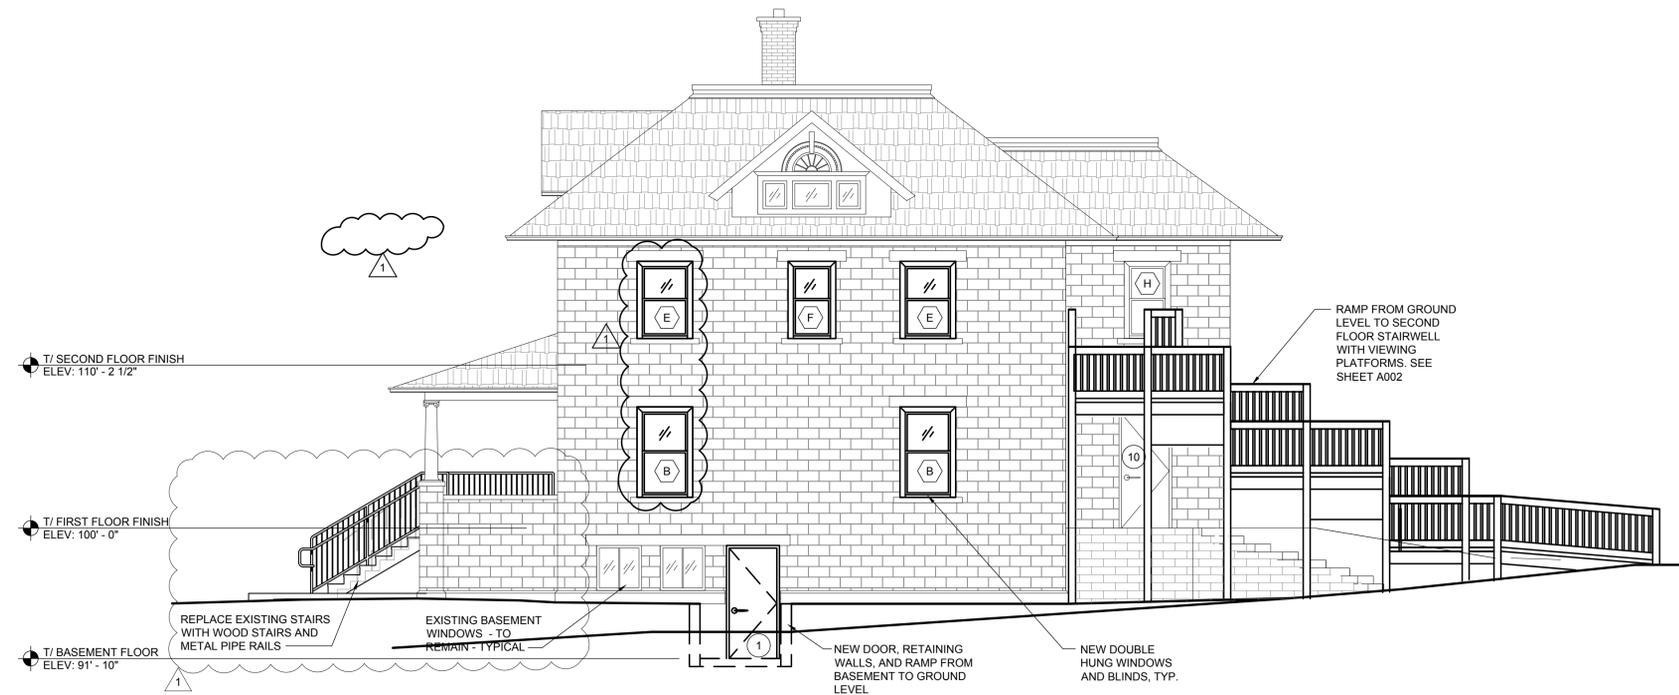

1 EAST ELEVATION
SCALE: 3/16" = 1'-0"

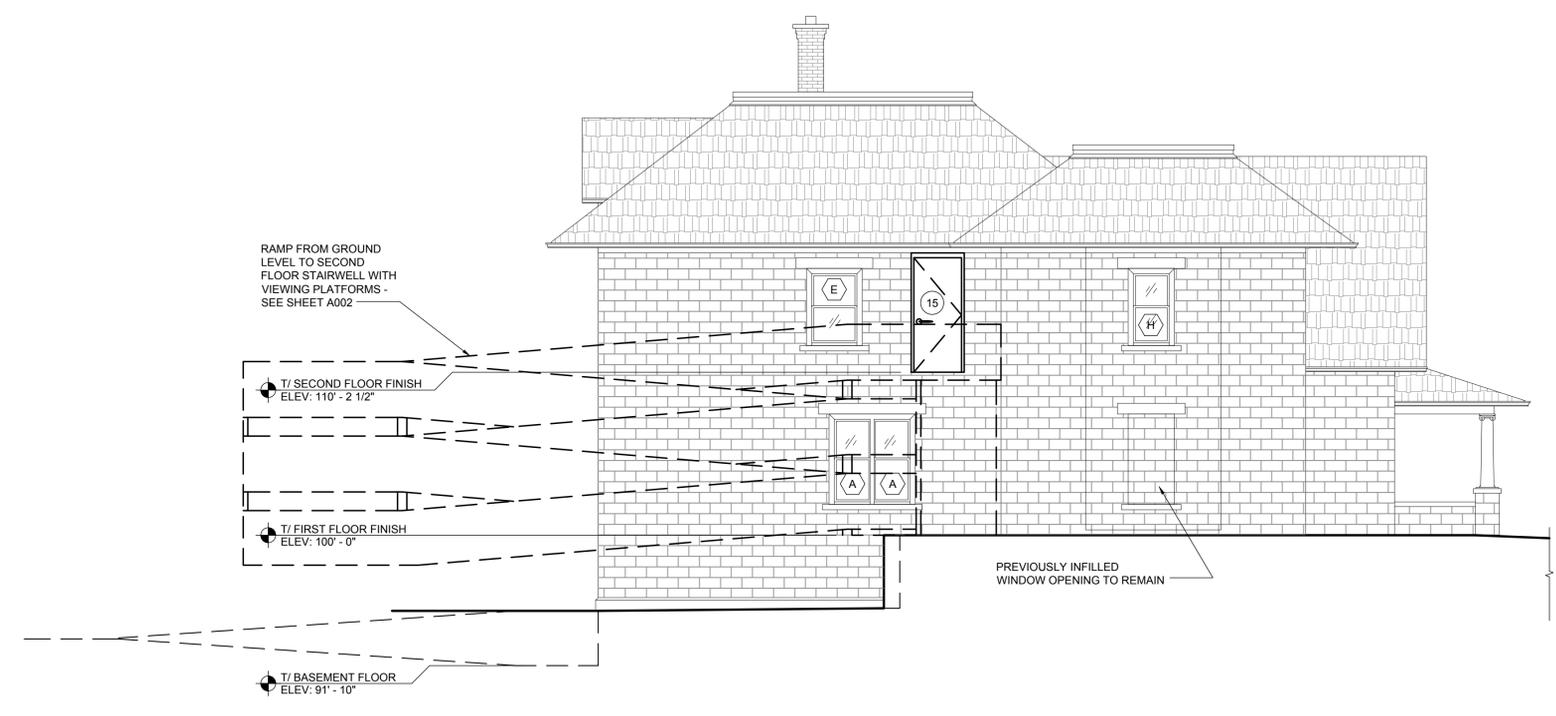

2 NORTH ELEVATION
SCALE: 3/16" = 1'-0"


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 OFFICE: 312.505.1542

Hoffmann Estates Park District - Vogeley House Remodel
 650 West Higgins Road
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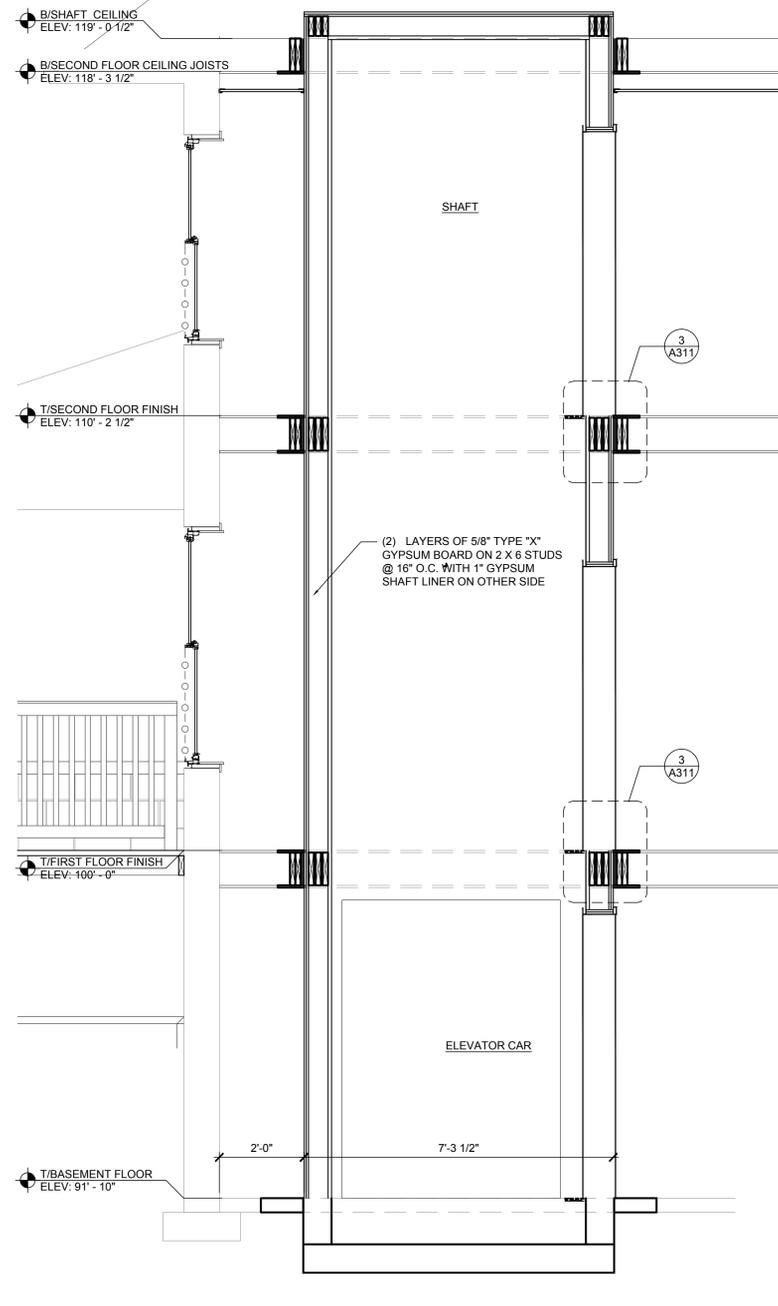
project no. D2100051
 date: 07.21.2021
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 revision 4:
 checked: CA
 drawn: JB

sheet title: BUILDING ELEVATIONS
 sheet number: A202

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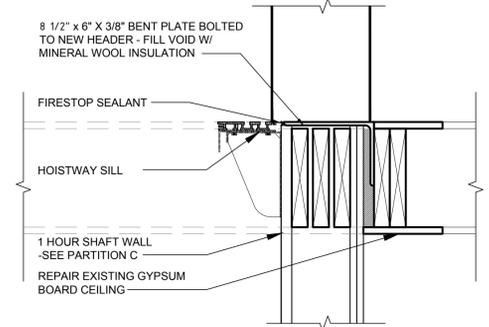


1 WALL SECTION
SCALE: 3/4" = 1'-0"

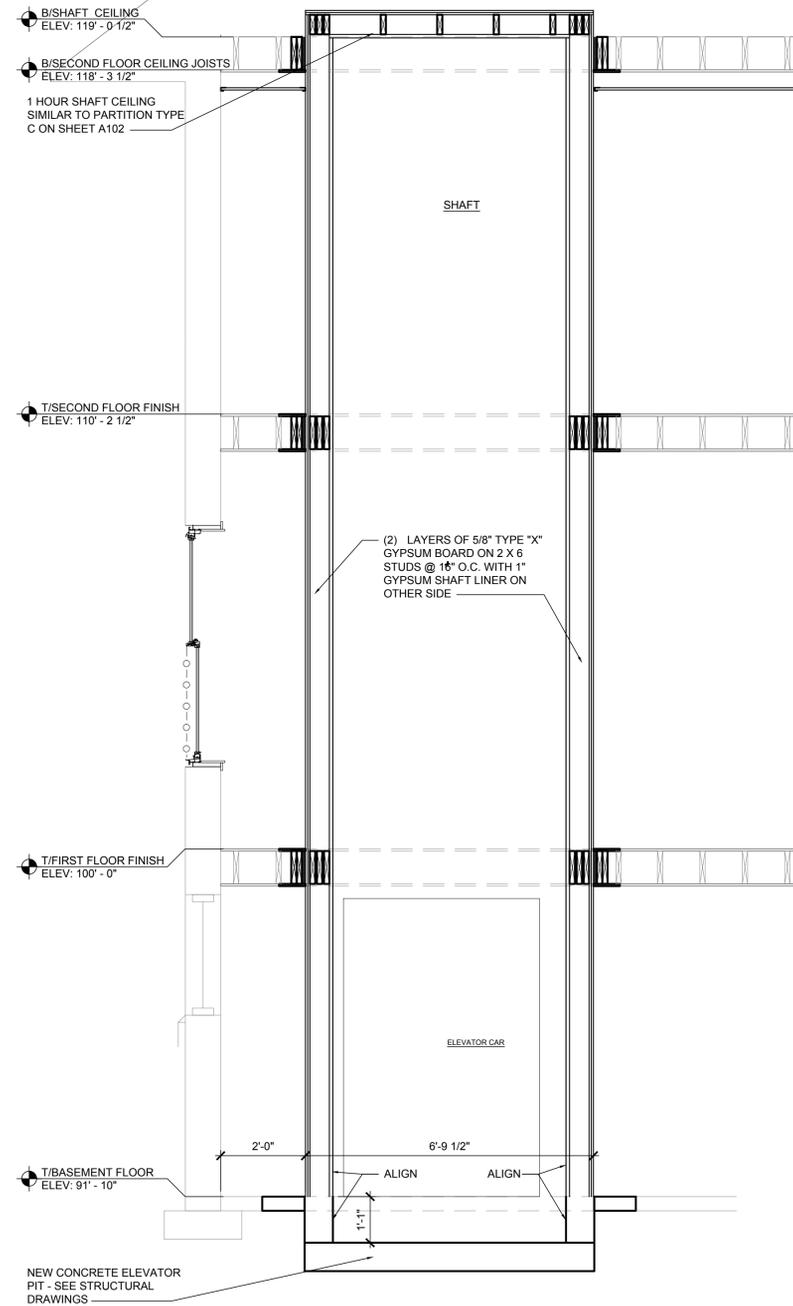

2 WALL SECTION
SCALE: 3/4" = 1'-0"

NOTE:
COORDINATE SHAFT WALL
DIMENSIONS/REQUIREMENTS
WITH ELEVATOR
MANUFACTURER



3 DETAIL
SCALE: 1 1/2" = 1'-0"

ROOM FINISH SCHEDULE									COMMENTS
ROOM NUMBER	ROOM NAME	FLOOR FINISH	BASE FINISH	WALL		CEILING			
				MATERIAL	FINISH	MATERIAL	FINISH	HEIGHT	
001	OPEN OFFICE	EPOXY	-	MASON.	P1	ACT1.	MATCH EXIST.	7'-0"	PREPARE EXIST. SURFACES TO RECEIVE NEW FINISH
002	ELECTRIC ROOM	EPOXY	-	MASON/G.B.	P1	ACT1.	MATCH EXIST.	7'-0"	PREPARE EXIST. SURFACES TO RECEIVE NEW FINISH
003	KITCHENETTE	EPOXY	-	G.B.	P1	G.B.	P1	EXIST.	PREPARE EXIST. SURFACES TO RECEIVE NEW FINISH
004	UTILITY ROOM	EPOXY	-	MASON.	P1	G.B.	P1	EXIST.	PREPARE EXIST. SURFACES TO RECEIVE NEW FINISH
005	MECHANICAL ROOM	EPOXY	-	MASON.	P1	G.B.	P1	EXIST.	PREPARE EXIST. SURFACES TO RECEIVE NEW FINISH
006	STORAGE ROOM	EPOXY	-	MASON/G.B.	P1	G.B.	P1	EXIST.	PREPARE EXIST. SURFACES TO RECEIVE NEW FINISH
007	OPEN OFFICE	EPOXY	-	MASON.	P1	ACT1.	MATCH EXIST.	7'-0"	PREPARE EXIST. SURFACES TO RECEIVE NEW FINISH
008	STORAGE ROOM	EPOXY	-	MASON.	P1	G.B.	P1	EXIST.	PREPARE EXIST. SURFACES TO RECEIVE NEW FINISH
009	STORAGE ROOM	EPOXY	-	MASON.	P1	G.B.	P1	EXIST.	PREPARE EXIST. SURFACES TO RECEIVE NEW FINISH
010	HALLWAY	EPOXY	-	MASON/G.B.	P1	ACT1.	MATCH EXIST.	7'-0"	PREPARE EXIST. SURFACES TO RECEIVE NEW FINISH
011	MECHANICAL ROOM	EPOXY	-	G.B.	P1	G.B.	P1	EXIST.	PREPARE EXIST. SURFACES TO RECEIVE NEW FINISH
101	OPEN PROGRAM	CARPET	-	G.B.	P1	ACT1.	MATCH EXIST.	MATCH EXIST.	PREPARE EXIST. SURFACES TO RECEIVE NEW FINISH
102	SIDE ENTRY	CARPET	-	G.B.	P1	ACT1.	MATCH EXIST.	MATCH EXIST.	PREPARE EXIST. SURFACES TO RECEIVE NEW FINISH
103	RESTROOM	EXIST.	-	G.B.	P1	ACT1.	MATCH EXIST.	MATCH EXIST.	PREPARE EXIST. SURFACES TO RECEIVE NEW FINISH
104	RESTROOM	EXIST.	-	G.B.	P1	ACT1.	MATCH EXIST.	MATCH EXIST.	PREPARE EXIST. SURFACES TO RECEIVE NEW FINISH
105	CLOSET	CARPET	-	G.B.	P1	ACT1.	MATCH EXIST.	MATCH EXIST.	PREPARE EXIST. SURFACES TO RECEIVE NEW FINISH
106	STAIRWELL	EXIST.	-	MASON.	P1	ACT1.	MATCH EXIST.	MATCH EXIST.	PREPARE EXIST. SURFACES TO RECEIVE NEW FINISH
201	OPEN OFFICE	CARPET	-	G.B.	P1	ACT1.	MATCH EXIST.	MATCH EXIST.	PREPARE EXIST. SURFACES TO RECEIVE NEW FINISH
202	PROGRAM ROOM	CARPET	-	G.B.	P1	ACT1.	MATCH EXIST.	MATCH EXIST.	PREPARE EXIST. SURFACES TO RECEIVE NEW FINISH
203	PROGRAM ROOM	CARPET	-	G.B.	P1	ACT1.	MATCH EXIST.	MATCH EXIST.	PREPARE EXIST. SURFACES TO RECEIVE NEW FINISH

CB CEMENT BOARD - TO BE USED IN ALL WET AREAS (INCLUDING SHOWERS, MOP SINKS, ETC.)
GB GYPSUM BOARD
WRGB WATER-RESISTANT GYPSUM BOARD - TO BE USED IN ALL DAMP AND TILED AREAS (INCLUDING RESTROOMS, ETC.)
PLYWD PLYWOOD - TO BE USED IN WALL AREAS WITH EQUIPMENT MOUNTING (INCLUDING KITCHENS, ELECTRICAL ROOMS, ETC.)

ROOM FINISH NOTES:
 • ALL FINISH SAMPLES TO BE APPROVED BY OWNER PRIOR TO ORDER AND INSTALLATION.
 • INTERIOR FINISH AT EXIT WAYS TO BE MINIMUM CLASS II. (FLAME SPREAD 26-75, SMOKE DEVELOPED 0-450)
 • INTERIOR FINISH AT ALL OTHER PUBLIC AREAS TO BE MINIMUM CLASS III. (FLAME SPREAD 76-200, SMOKE DEVELOPED 0-450)
 • ALL PAINTED SURFACES TO RECEIVE (1) COAT PRIMER AND (2) FINISH COATS AS REQUIRED FOR FULL COVERAGE.
 • ALL HOLLOW METAL DOORS AND FRAMES TO RECEIVE (1) COAT OF PRIMER AND (2) FINISH COATS OF SEMI-GLOSS PAINT.
 • ALL GROUT JOINTS TO RECEIVE (2) COATS OF MANUFACTURER'S RECOMMENDED SEALER.

Common Specifications
For LU/LA elevator equipment



Standard Features

- Rated capacity: 1,400 lb. (635 kg)
- Lifting height: up to 25'0" standard
- Power supply: 208/230 VAC, 1 PH, 30 amp, 60 Hz
- Speed: 30 fpm (15 M/3)
- Automatic self-leveling
- 2:1 roped hydraulic drive system
- Smooth start and stop
- Two-stop operation
- 36 inch doors, automatic horizontally sliding, two speed hoistway and car door, full-height light curtain
- Pit depth:
 - ASME A17.1 year 2013 & prior: standard 13 inches with elastomeric bumpers and alternative means (bottom car clearance device)
 - ASME A17.1 year 2016: standard 14 inches with buffer springs and alternative means (bottom car clearance device)
- Overhead: 11'0" standard or 8'10" (106 inches) with alternative means (top car clearance device)
- Selective Collective Programmable Logic Controller (PLC)
- Car-mounted directional indicator with audible signals
- 4 HP submersible pump and motor for quiet operation
- Two-speed control valve
- Low oil protection
- Single-stage hydraulic jack and two 3/4 inch aircraft cables using wedge sockets
- 8 lb. T-rail
- Heavy-duty rollers and guides
- Homing timer
- Digital position indicator
- ADA hands-free phone
- Passing chime
- Single opening
- Three-year limited parts warranty

Safety Features

- Keypad in-car stop switch and alarm button
- Emergency lighting in car interior
- Uninterruptible Power Supply (UPS) for car lowering and operation of car and hoistway doors in the event of a power failure
- Emergency manual lowering
- Slack/broken cable safety brake device
- Overspeed valve
- ETL, UL or CSA certified components
- Tactile/braille characters
- Elastomeric bumpers (ASME A17.1 year 2013 & prior) or buffer springs (ASME A17.1 year 2016)

Car Features

- 7'0" interior car height
- Ivory powder coated painted steel or ~~Unfinished Red Oak Flat Panel car walls with matching ceiling~~
- Brushed Stainless Steel car entrance on steel car (strike column, return column and transom)
- Matching entrance on wood car
- Ivory powder coat painted steel 3'0" x 6'8" Two Speed Doors
- Brushed Stainless Steel handrail
- Unfinished plywood floor with sill set for 1/4 inch (flooring by others)
- Four recessed LED lights with Black Trim rings

Optional Features

- Up to six stops
- Custom wood cars
- Stainless steel cars
- Laminate applied car panels
- Overspeed governor
- Speed: 40 fpm with variance
- 50'0" travel with variance and derated capacity
- Three-Phase motor and controller (208/230 VAC, 3 PH, 20 amp, 5 HP)
- Buffer springs (minimum 14 inch pit required)
- Landing position indicator
- Hoistway access
- Phase 1 and Phase 2 fire service
- Phone line monitoring system
- Green drive system by adding environmentally friendly hydraulic oil
- Ventilation system

Platform Sizes

- (Custom sizes and designs available)
- ~~48" W x 54" D standard~~
 - 42" W x 54" D standard
 - ~~42" W x 60" D optional~~
 - ~~51" W x 54" D optional~~

Enter/Exit Configurations

- Enter/Exit same side standard
- ~~90° Adjacent optional~~
- ~~Straight Through optional~~

* Wood cars require fire coat to be added in commercial settings

Symmetry LU/LA elevators are designed to comply with ASME A17.1 Section 5.2 and the Americans with Disabilities Act (ADA).

All LU/LA elevators are limited by speed, travel and capacity in order to comply with applicable code.

symmetryelevator.com • 877.375.1428



1 LIMITED USE/LIMITED APPLICATION ELEVATOR

SCALE:

INTERIOR FINISH LEGEND (X)						
TAG	ITEM DESCRIPTION	MANUFACTURER	PRODUCT NUMBER / COLOR	SIZE / SPECS	GROUT	COMMENTS
ACT1	SUSPENDED ACOUSTICAL CEILING SYSTEM	MATCH EXIST.	-	-	-	-
CARPET	TBD BY OWNER	-	-	-	-	-
EPOXY	TBD BY OWNER	-	-	-	-	-
P1	INTERIOR PAINT	SHERWIN WILLIAMS	WHITE - EXACT COLOR TBD BY OWNER	-	-	-
P2	INTERIOR PAINT	SHERWIN WILLIAMS	TBD BY OWNER	-	-	HOLLOW METAL DOOR & FRAME
P3	EXTERIOR PAINT	SHERWIN WILLIAMS	TBD BY OWNER	-	-	HOLLOW METAL DOOR & FRAME




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 revision 2:
 revision 3:
 revision 4:
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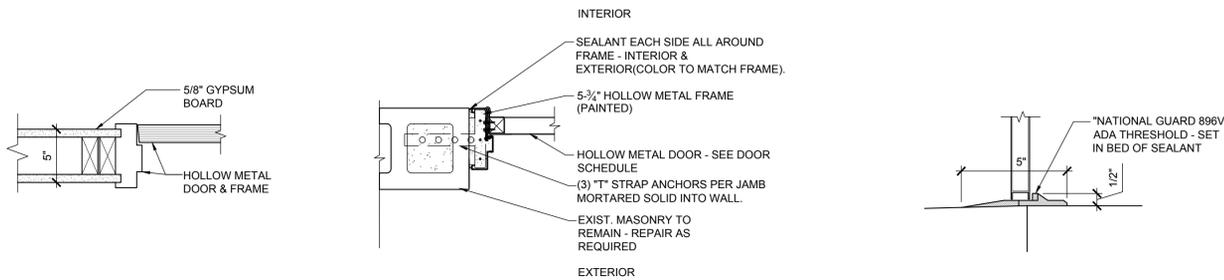
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HOFFMAN ESTATES PARK DISTRICT - VOGELI HOUSE REMODEL
650 WEST HIGGINS ROAD
HOFFMAN ESTATES, IL 60169

sheet title:
ROOM FINISH SCHEDULE
 sheet number:
A701




1 DOOR ELEVATIONS
SCALE: 1/4" = 1'-0"

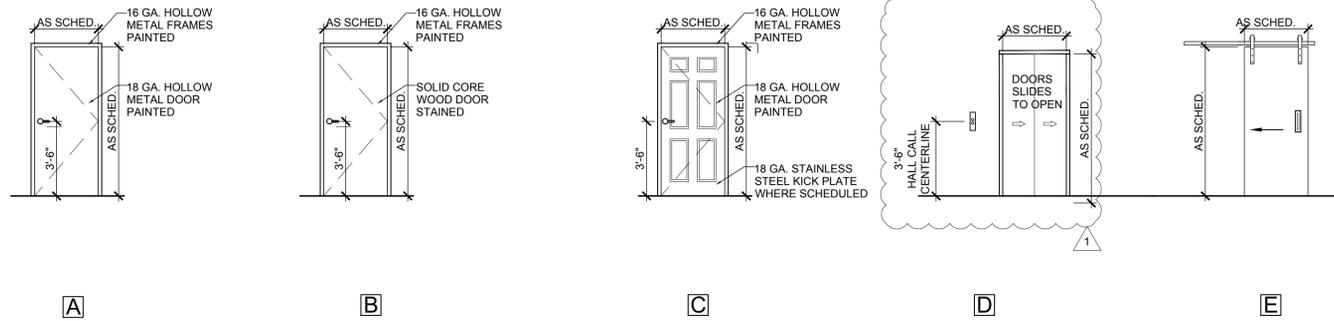

2 DOOR JAMB
SCALE: 1 1/2" = 1'-0"

3 DOOR JAMB
SCALE: 1 1/2" = 1'-0"

4 DOOR THRESHOLD
SCALE: 1 1/2" = 1'-0"

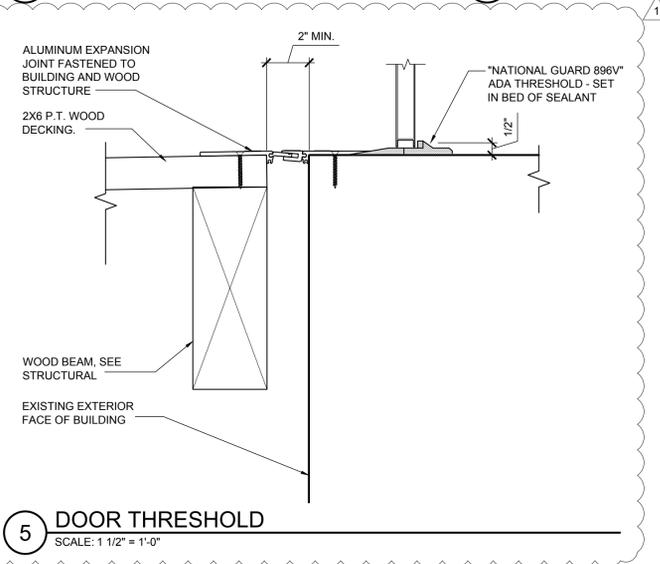

5 DOOR THRESHOLD
SCALE: 1 1/2" = 1'-0"

DOOR SCHEDULE (X)										
TAG	ROOM NAME	DOOR SIZE	FRAME SIZE	DOOR TYPE	MATERIAL DOOR / FRAME	THRESHOLD DETAIL	JAMB DETAIL	HARDWARE	FIRE RATING	COMMENTS
1	RAMP	3'-0" x 7'-0"	3'-4" x 7'-2"	A	H.M.	4/A702	3/A702	SET 1	-	EXTERIOR DOOR, INSULATED U=-.10 MAX.
2	ELECTRICAL ROOM	3'-0" x 7'-0"	3'-4" x 7'-2"	A	H.M.	-	2/A702	SET 2	1-HOUR	
3	MECHANICAL ROOM	EXIST. TO REMAIN								
4	STORAGE ROOM	3'-0" x 7'-0"	3'-4" x 7'-2"	B	S.C./H.M.	-	2/A702	SET 2	-	
5	STORAGE ROOM	3'-0" x 7'-0"	3'-4" x 7'-2"	B	S.C./H.M.	-	2/A702	SET 2	-	
6	STORAGE ROOM	3'-0" x 7'-0"	3'-4" x 7'-2"	B	S.C./H.M.	-	2/A702	SET 2	-	
7	STAIRWELL	EXIST. TO REMAIN								
8	OPEN PROGRAM	3'-0" x 7'-0"	3'-4" x 7'-2"	C	H.M.	4/A702	3/A702	SET 1	-	EXTERIOR DOOR, INSULATED U=-.10 MAX.
9	SIDE ENTRY	3'-0" x 7'-0"	3'-4" x 7'-4"	C	H.M.	4/A702	3/A702	SET 1	-	EXTERIOR DOOR, INSULATED U=-.10 MAX.
10	STAIRWELL	EXIST. TO REMAIN								
11	RESTROOM	EXIST. TO REMAIN								
12	RESTROOM	EXIST. TO REMAIN								
13	STAIRWELL	3'-0" x 7'-0"	3'-4" x 7'-4"	A	H.M.	-	3/A702	SET 3	1-HOUR	
14	HOISTWAY*	3'-0" x 6'-8"		D					1 1/2-HOUR	* PROVIDED & INSTALLED BY ELEVATOR MANUFACTURER
15	RAMP	3'-0" x 7'-0"	3'-4" x 7'-2"	A	H.M.	4/A702	3/A702	SET 1	-	EXTERIOR DOOR, INSULATED U=-.10 MAX.
16	STAIRWELL	EXIST. TO REMAIN								
17	PROGRAM ROOM	3'-0" x 7'-0"		E	WD.	-	-	SET 4	-	
18	PROGRAM ROOM	3'-0" x 7'-0"		E	WD.	-	-	SET 4	-	
19	HOISTWAY*	3'-0" x 6'-8"		D					1 1/2-HOUR	* PROVIDED & INSTALLED BY ELEVATOR MANUFACTURER
20	HOISTWAY*	3'-0" x 6'-8"		D					1 1/2-HOUR	* PROVIDED & INSTALLED BY ELEVATOR MANUFACTURER
21	MACHINE ROOM	3'-0" x 7'-0"	3'-4" x 7'-2"	A	H.M.		2/A702	SET 6	1-HOUR	

DOOR HARDWARE

- SET 1**
- 1 1/2 PAIR BUTT HINGES (4 1/2"x4 1/2" NRP)
 - LEVER HANDLE WITH KEY OUTSIDE LOCKSET (ANSI #F84-CLASS ROOM LOCK) (SCHLAGE #D50BD, RHODES LEVER, #626 FINISH)
 - SECURITY: SCHLAGE B660 SINGLE CYLINDER DEADLOCK WITH ACCESSIBLE THUMBTURN ASSEMBLY 12-617 ON INTERIOR
 - HEAVY DUTY OVERHEAD CLOSER (LCN 1461)
 - "HOLD OPEN" DEVICE (HANGER 270C-S1)
 - WEATHERSTRIPING
 - THRESHOLD
- SET 2**
- 1 1/2 PAIR BUTT HINGES (4 1/2"x4 1/2" NRP)
 - LEVER HANDLE WITH KEY OUTSIDE LOCKSET (ANSI #F86-STORE ROOM LOCK) (SCHLAGE #D50BD, RHODES LEVER, #626 FINISH)
 - HEAVY DUTY OVERHEAD CLOSER (LCN 1461)
- SET 3**
- 1 1/2 PAIR BUTT HINGES (4 1/2"x4 1/2" NRP)
 - LEVER HANDLE LOCKSET (ANSI #F75-PASSAGE) (SCHLAGE #D50BD, RHODES LEVER, #626 FINISH)
 - HEAVY DUTY OVERHEAD CLOSER (LCN 1461)
- SET 4**
- BARN DOOR HARDWARE
 - PULL HANDLE BOTH SIDES
- SET 6**
- 1 1/2 PAIR BUTT HINGES (4 1/2"x4 1/2" NRP)
 - LEVER HANDLE WITH KEY OUTSIDE LOCKSET (ANSI #F86-STORE ROOM LOCK) (SCHLAGE #D50BD, RHODES LEVER, #626 FINISH) KNURLED HANDLE
 - HEAVY DUTY OVERHEAD CLOSER (LCN 1461)

NOTES

- ALL DOORS ARE 1 3/4" THICK - UNLESS NOTED OTHERWISE.
- ALL INTERIOR AND EXTERIOR HOLLOW METAL FRAMES ARE 16 GA, WELDED TYPE.
- ALL CLOSERS AND HARDWARE TO BE US26D - UNLESS NOTED OTHERWISE.
- ALL LOCKSETS TO BE KEYED SEPARATELY. ALL KEYWAYS TO BE STANDARD KEYWAYS.
- CONTRACTOR TO CONFIRM THAT ALL CYLINDERS WILL BE PROVIDED FROM ONE SOURCE.
- ALL CLOSERS AND LOCKSETS SHALL MEET ACCESSIBILITY REQUIREMENTS.
- ALL HINGES ON DOORS WITH CLOSERS TO BE OIL IMPREGNATED BEARING TYPE.
- ALL FRAMES TO RECEIVE STANDARD ANSI CURVED LIP STRIKE WITH ANSI WROUGHT STRIKE BOX WHERE REQUIRED.
- ALL CLOSERS TO BE SET FOR 110 DEGREE OPENING WHERE THE DOOR SWING WILL NOT BE IN CONFLICT WITH ADJACENT CONSTRUCTION.
- ALL MOUNTING SCREWS FOR CLOSERS, CLOSER ARMS, AND OPERATOR ARMS ON ALUMINUM DOORS SHALL BE SCREWED INTO "NUTSERTS". NUTSERTS TO BE STAINLESS STEEL TYPE. THE PRESCRIBED USE OF THE NUTSERTS PRODUCT IS SUBJECT TO NO EXCEPTION BEING TAKEN BY THE ALUMINUM DOOR MANUFACTURER / INSTALLER.
- EXTERIOR DOORS TO HAVE MAXIMUM 8.5 POUNDS PUSH/PULL OPENING FORCE.
- INTERIOR DOORS TO HAVE MAXIMUM 5 POUNDS PUSH/PULL OPENING FORCE.
- CONTRACTOR TO SUBMIT MANUFACTURER'S SPECIFICATIONS FOR DOOR HARDWARE.
- ALL DOOR HANDLES, PULLS, LATCHES, LOCKS, AND OTHER OPERATING DEVICES SHALL BE INSTALLED AT LEAST 34" BUT NOT MORE THAN 48" ABOVE FINISH FLOOR.
- THE OPERATING DEVICES SHALL BE CAPABLE OF OPERATION WITH ONE HAND AND SHALL NOT REQUIRE TIGHT GRASPING, TIGHT PINCHING, OR TWISTING OF WRIST TO OPERATE.
- EGRESS DOORS SHALL OPEN READILY FROM THE EGRESS SIDE WITHOUT THE USE OF A KEY OR SPECIAL KNOWLEDGE OR EFFORT.
- THE USE OF MACHINE SCREWS FOR CONTINUOUS HINGE ANCHORAGE IS REQUIRED. PROVIDE ADDITIONAL REINFORCING FOR THE HINGES IN THE FRAMES AND DOOR STILES.
- THE HARDWARE INSTALLER TO CONFIRM THAT ALL CLOSERS HAVE THE BACKCHECK VALVE SCREWED IN, FOR PARALLEL ARM INSTALLATIONS.
- CONTRACTOR TO REVIEW ALL DOOR ACTUATOR LOCATIONS WITH THE OWNER PRIOR TO INSTALLING BACK BOXES.
- ALL HARDWARE ON RATED DOORS TO BEAR U.L. LABEL.

ABBREVIATIONS: H.M.-HOLLOW METAL; S.C.-SOLID CORE; WD.-WOOD


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DEMOLITION LEGEND


(EX) ITEM IS EXISTING TO REMAIN
 (X) ITEM IS EXISTING TO BE REMOVED
 (XR) ITEM IS EXISTING TO BE RELOCATED

PLUMBING DRAWING KEYNOTES


① CAP UNDERGROUND SANITARY BELOW FLOOR GAS TIGHT. ABANDON PIPE IN PLACE PER STATE OF ILLINOIS CODE SECTION 940.1320 PARAGRAPH D). REMOVE ALL ABOVE GROUND PIPING, HANGERS, INSULATION ETC. REMOVE WATER PIPING BACK TO MAIN.

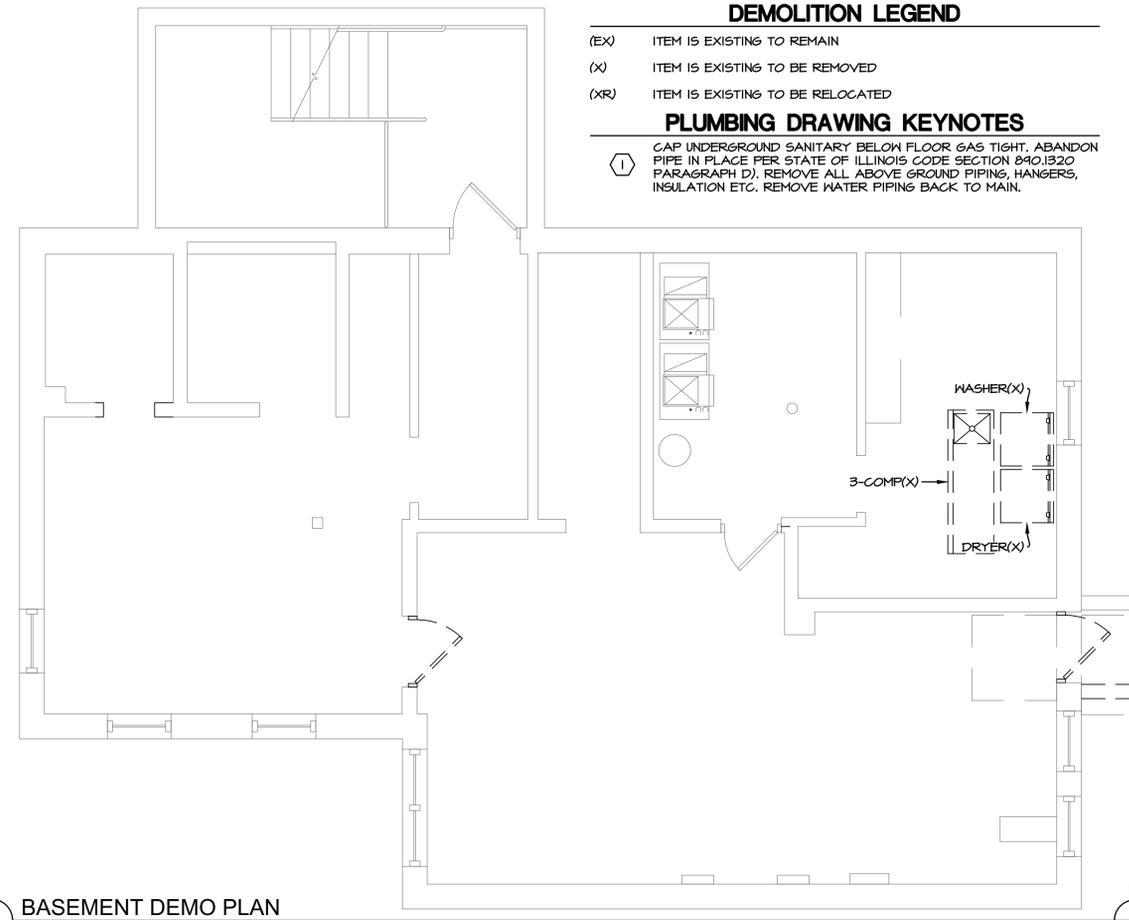


1 BASEMENT DEMO PLAN
 SCALE: 1" = 1/4"

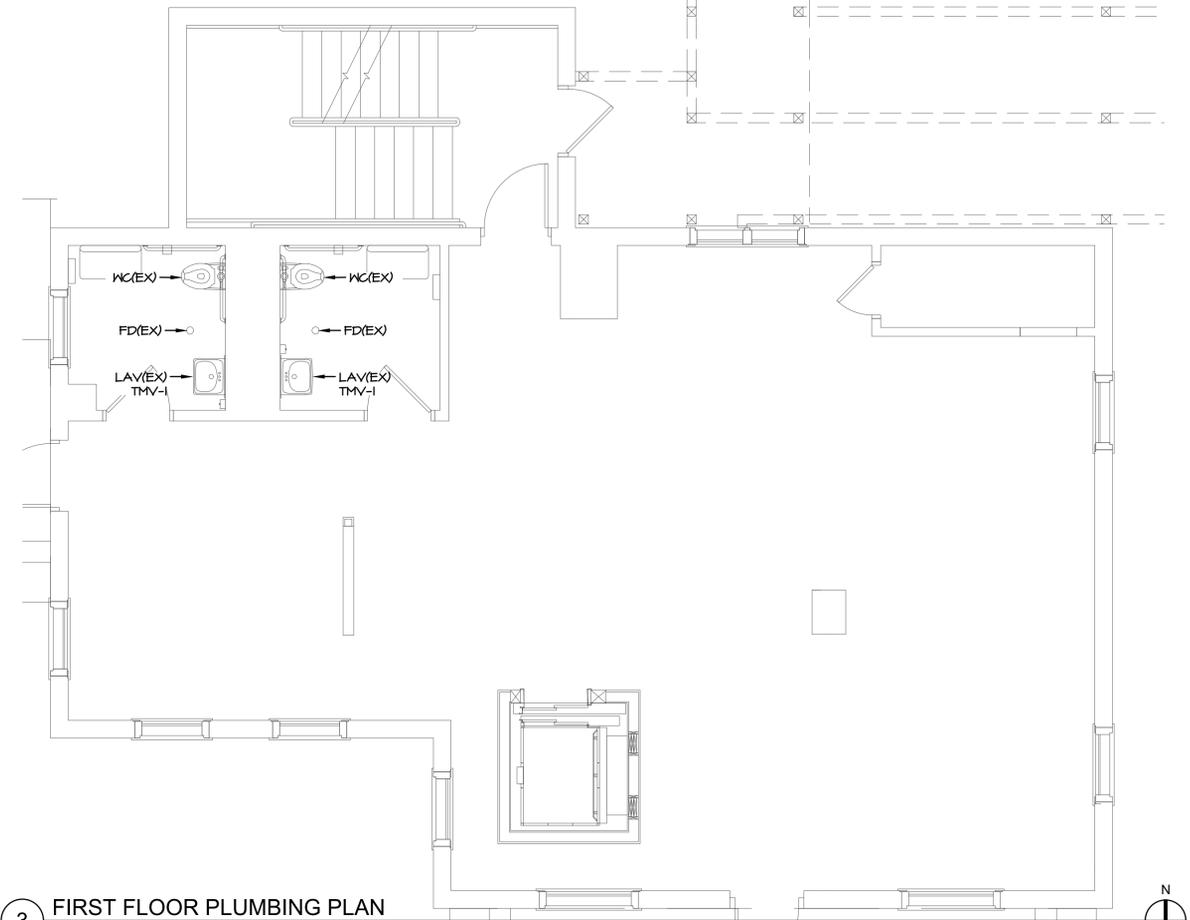

3 FIRST FLOOR PLUMBING PLAN
 SCALE: 2"

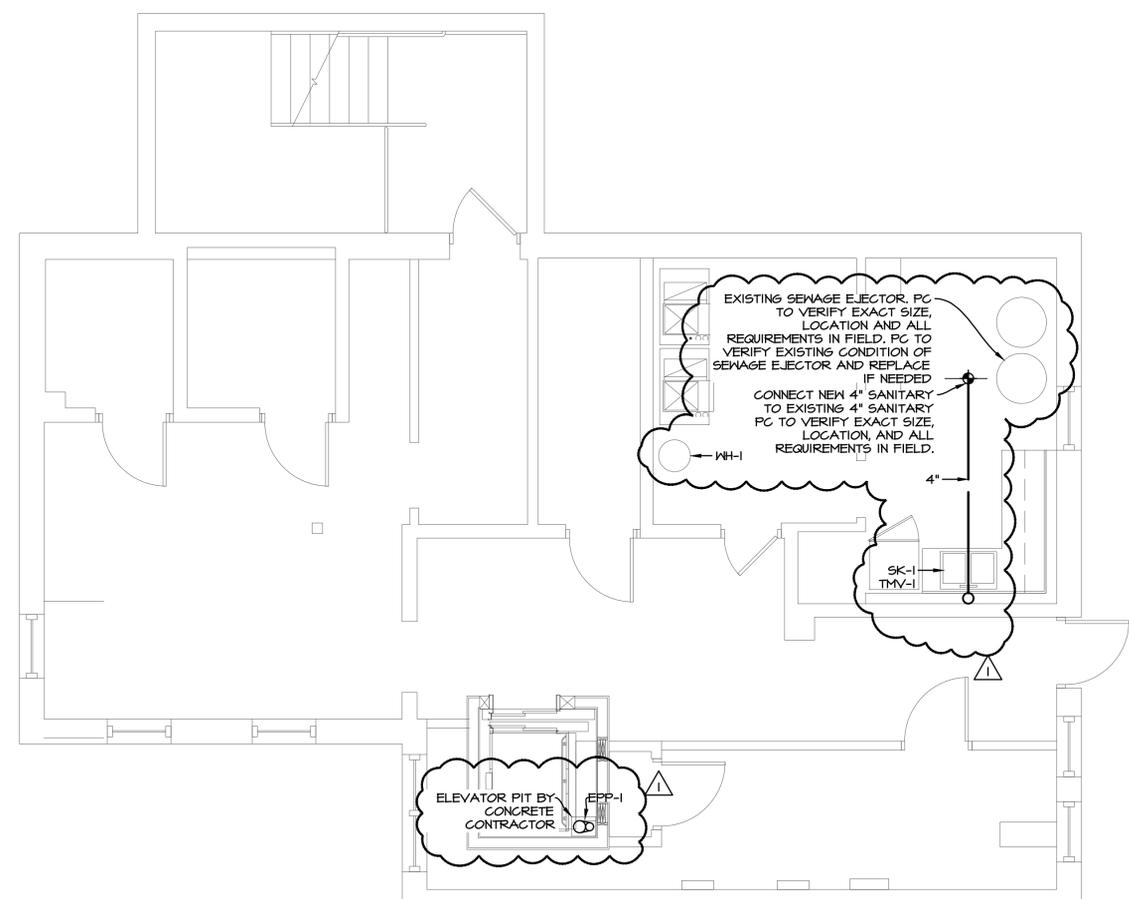


1 UNDERGROUND PLUMBING PLAN
 SCALE: 3"

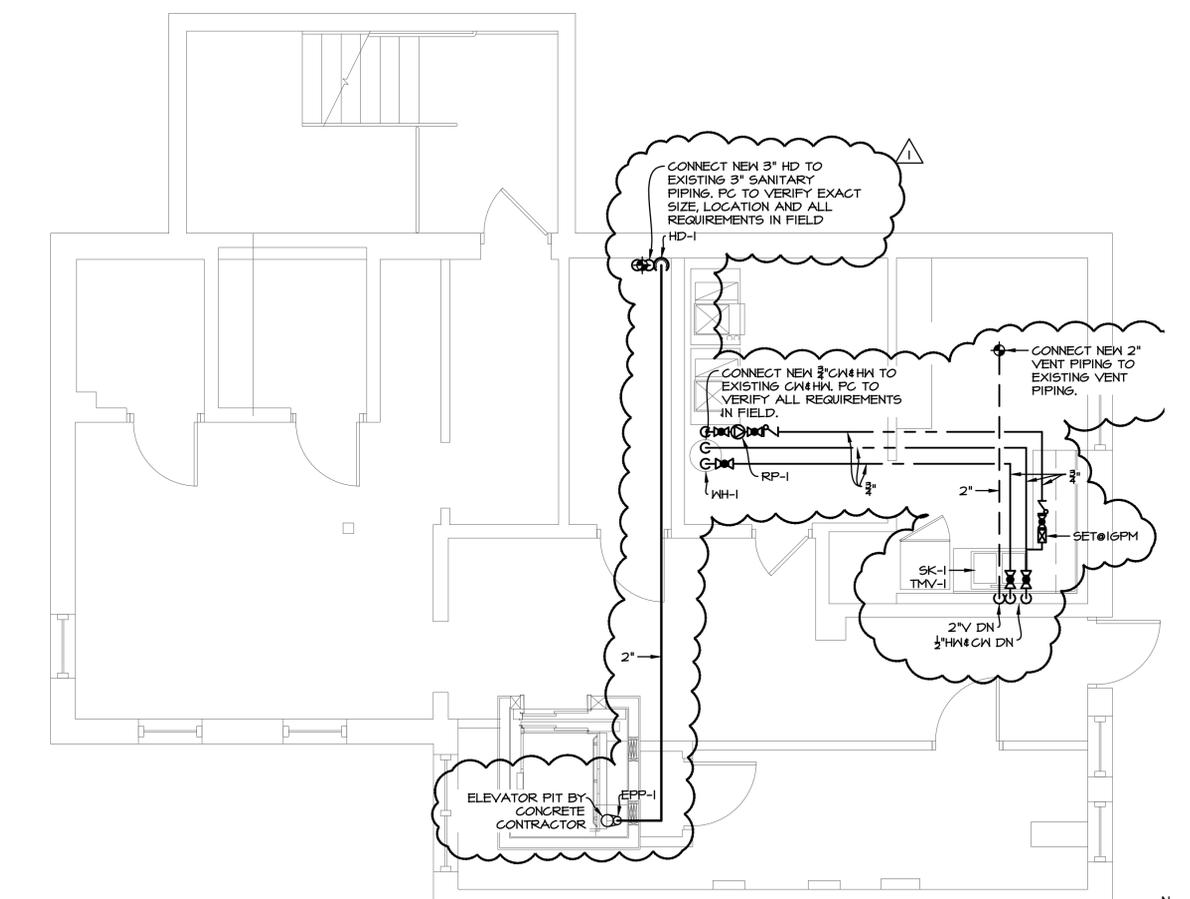

4 ABOVE GROUND PLUMBING PLAN
 SCALE: 1" = 1/4"

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HOFFMAN ESTATES PARK DISTRICT - VOGELI HOUSE REMODEL

HOFFMAN ESTATES PARK DISTRICT - VOGELI HOUSE REMODEL
 650 WEST HIGGINS ROAD
 HOFFMAN ESTATES, IL 60169
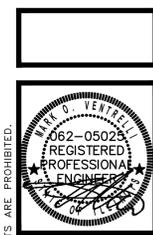
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P1.1

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PLUMBING SYMBOLS

NOT ALL SYMBOLS MAY APPLY

—	EXISTING COLD WATER PIPING
—	EXISTING HOT WATER PIPING
—	EXISTING UNDERGROUND SEWER
—	EXISTING SUSPENDED SEWER
- - -	EXISTING VENT PIPING
—	COLD WATER PIPING (INSULATED)
—	HOT WATER PIPING (INSULATED)
—	HOT WATER RETURN PIPING (INSULATED)
—	UNDERGROUND SEWER
—	SUSPENDED SEWER
- - -	VENT PIPING

⊠	FCO-1 FLOOR CO ("SMITH" #4040, MIFAB G1220-5-3) FF
⊙	FCO-2 FLOOR CO ("SMITH" #4020) FINISHED AREAS
⊠	GV GATE VALVE ("NIBCO" #5-134 OR T-134)
⊠	BV BALL VALVE ("NIBCO" #5-585-TO OR T-585-TO)
⊠	BV BALANCING VALVE ("NIBCO" #5-1110 OR T-1110)
◆	NEW CONNECTION BETWEEN NEW AND EXISTING
—	CW - COLD WATER
—	DN - DOWN
—	HW - HOT WATER
—	HW - HOT WATER RETURN
—	V - VENT
—	VIF - VERIFY IN FIELD

EQUIPMENT SCHEDULE

SE-1	"ZOELLER" MODEL #M264 SEWAGE PUMP, PUMP SHALL BE RATED FOR 60 GPM AT 10 FEET OF HEAD, 4/10 HP, WIRE WITH 115 VOLT POWER (1.4A). PROVIDE CHECK VALVE AND GATE VALVE ON 2" DISCHARGE. PROVIDE NEW GAS-TIGHT COVER, 18"x36" FIBERGLASS BASIN, 10-0126 WITH HIGH-WATER ALARM.
SK-1	"ELKAY" MODEL #LRAD3322 LUSTERTONE DOUBLE BOWL ADA COMPLIANT STAINLESS STEEL SINK, SINK IS SEAMLESSLY DRAWN OF #10 GAUGE, TYPE 304 STAINLESS STEEL. "SYMMONS" MODEL #S-23 SYMMETRIX SINGLE HANDLE KITCHEN FAUCET HAS 6" HANDLE AND A 8-3/4" SWING SPOUT PROVIDE CHROME-PLATED ANGLES STOPS, ESCUTCHEONS, RISER TUBES, TAILPIECES AND P-TRAPS.
TMV-1	"SYMMONS" MODEL #B210CK POINT-OF-USE THERMOSTATIC MIXING VALVE WITH INTEGRAL CHECKS. (SET TEMPERATURE SHALL NOT EXCEED 110 DEGREES F)
WH-1	"AO SMITH" MODEL #6PDT 50 GAS FIRED WATER HEATER. HEATER HAS A CAPACITY OF 50 GALLONS. HEATER HAS A 45,000 BTUH INPUT. HEATER SHALL RECOVER 50.3 GALLONS PER HOUR AT A 40 DEGREE TEMPERATURE RISE.
ET-1	"AMTROL" MODEL #ST-5 THERMAL EXPANSION TANK. EXPANSION TANK SHALL BE INSTALLED ON THE WATER HEATER SIDE OF THE SHUT-OFF VALVE TO THE WH.
RP-1	"TACO" MODEL #003-BC4-IFC CARTRIDGE CIRCULATOR, PUMP SHALL PROVIDE 3 FT OF HEAD AT 3.0 GPM. COORDINATE INSTALLATION WITH ELECTRICAL CONTRACTOR. PROVIDE HONEYWELL AQUA-STAT WITH CIRCULATION PUMP
EPP-1	"LITTLE GIANT" MODEL #SFS0, 1/2 HP, 50 GPM@20' HEAD, 1-1/2" DISCHARGE, 18"x18"x18" RECESSED CONCRETE SUMP BY CONCRETE CONTRACTOR. PLUMBER TO PROVIDE GRATE.

PLUMBING NOTES

- 1) SAW CUT EXISTING FLOOR AND WALL CONSTRUCTION AS REQUIRED IN ORDER TO ACCOMMODATE NEW WASTE, VENT AND WATER SUPPLY PIPING. PATCH ALL NEW WORK TO MATCH EXISTING CONSTRUCTION. DEMOLITION OF ALL PLUMBING WASTE LINES SHALL NOT RESULT IN DEAD ENDS GREATER THAN 10'-0" IN LENGTH AND ALL WATER SUPPLY PIPING DEAD ENDS SHALL NOT EXCEED 2'-0" IN LENGTH.
- 2) ALL CLEAN-OUTS SHALL BE INSTALLED WHERE READILY ACCESSIBLE. THE CONTRACTOR SHALL COORDINATE ALL CLEAN-OUT LOCATIONS, WITH EQUIPMENT CABINETS, ETC. PROVIDE FULL SIZED CLEANOUTS ON STRAIGHT RUN INTERVALS NOT TO EXCEED FIFTY (50') AS WELL AS AT EACH CHANGE OF DIRECTION GREATER THAN (60 DEGREES). FIXTURE TRAPS (I.E. FLOOR DRAINS) SHALL NOT CONSTITUTE CLEAN-OUT ACCESS POINTS IF A CABLE MUST MAKE TWO (2) OR MORE RIGHT ANGLE TURNS IN ORDER TO ENTER THE MAIN DRAIN OR STACK.
- 3) ALL PLUMBING FIXTURE VENTS SHALL TERMINATE A MINIMUM OF 12" FROM ANY VERTICAL SURFACE AND 12'-0" HORIZONTALLY FROM ANY OUTSIDE FRESH AIR INTAKE OR A MINIMUM OF 24" ABOVE FRESH AIR IN-TAKES IF THE 12'-0" HORIZONTAL SEPARATION IS NOT POSSIBLE.
- 4) INSTALL SHUT-OFF VALVES ON ALL HOT & COLD WATER LINES TO FIXTURE OR APPLIANCE.
- 5) PROVIDE 12" (MINIMUM) LONG AIR CHAMBERS ON ALL WATER SUPPLY LINES TO FIXTURES AND EQUIPMENT. PROVIDE WATER HAMMER ARRESTORS AT ALL FIXTURES WITH QUICK-CLOSING VALVES/FAUCETS.
- 6) PROVIDE DI-ELECTRIC UNIONS, COUPLINGS, ADAPTORS OR FLANGES AT ALL TRANSITIONS OF FERROUS PIPING TO NON-FERROUS PIPING.
- 7) PROVIDE NON-REMOVEABLE/INTEGRAL VACUUM BREAKER ON ALL NEW AND EXISTING MOP BASIN FAUCETS AND ALL OTHER NEW AND EXISTING THREADED HOSE OUTLETS, HOSE BIBS AND WALL HYDRANTS.
- 8) COORDINATE ROUTING OF ALL PIPING SYSTEMS TO AVOID DUCTWORK, ELECTRICAL CONDUIT, BEAMS AND OTHER STRUCTURAL MEMBERS.
- 9) PROVIDE VALVE STEM EXTENSIONS AS REQUIRED FOR ALL INSULATED WATER SUPPLY PIPING.
- 10) PROVIDE GROUTING/CAULKING WHERE FIXTURES MEET WALLS, FLOORS, COUNTERTOPS, ETC.
- 11) ROUTE CIRCULATING HOT WATER DISTRIBUTION MAINS WITHIN 25 FEET (MINIMUM) OF EACH FIXTURE. PROVIDE AUTOMATIC PRESSURE COMPENSATING FLOW CONTROL VALVES FOR BALANCING CONTROL IN ACCESSIBLE LOCATIONS (PROVIDE ACCESS PANEL AS REQUIRED). INSULATE ALL RE-CIRCULATION PIPING.
- 12) ALL EXPOSED WASTE PIPING LOCATED IN TOILET ROOMS SHALL BE CHROME PLATED BRASS WITH MATCHING STOPS AND ESCUTCHEONS. PROVIDE LOOSE KEY TYPE STOPS IN ALL PUBLIC AREAS OR WHERE VANDAL RESISTANT INSTALLATIONS ARE REQUIRED. ALL RISER TUBES SHALL BE RIGID AND CHROME PLATED.
- 13) PROVIDE PROTECTIVE INSULATED PIPE COVERS ON P-TRAPS, ANGLE STOPS, OFFSET TAILPIECES, RISER SUPPLY TUBES, ETC. FOR ALL ADA ACCESSIBLE FIXTURES.
- 14) PROVIDE A.S.S.E. 1070 APPROVED POINT-OF-USE THERMOSTATIC MIXING VALVE TO SUPPLY 110 DEGREES (MAXIMUM) HOT WATER TO ALL PUBLIC AND ADA ACCESSIBLE LAVATORIES. PROVIDE 115 DEGREE F (MAXIMUM) HOT WATER TO ALL SHOWERS. PROVIDE 140 F DEGREE HOT WATER TO ALL FIXTURES WHERE HOT WATER IS REQUIRED FOR SANITIZING OR CLEANING.
- 15) PROVIDE A VACUUM RELIEF VALVE ON ALL ELEVATED OR BOTTOM FED WATER HEATERS IN ADDITION TO A TEMPERATURE & PRESSURE RELIEF VALVE.
- 16) PROVIDE DRIP VALVE ON THE DISCHARGE SIDE OF THE DOMESTIC WATER METER.
- 17) OUTLET TEMPERATURE ON ALL WATER HEATERS SHALL BE SET AT 135 DEGREES F (MINIMUM) AND THERMOSTATICALLY MIXED DOWN AT POINTS INDICATED ON PLANS.
- 18) ALL BACK-FLOW PREVENTION DEVICES SHALL BE TESTED IN-LINE AND APPROVED BY A CROSS-CONNECTION CONTROL DEVICE INSPECTOR BEFORE BEING PLACED INTO SERVICE. BACK-FLOW PREVENTION DEVICES SHALL BE TESTED AND MAINTAINED AT LEAST ANNUALLY BY A CROSS-CONNECTION CONTROL DEVICE INSPECTOR AND RECORDS TO VERIFY TESTING AND MAINTENANCE SHALL BE AVAILABLE AT THE SITE OF THE INSTALLATION OF THE DEVICE. BACK-FLOW PREVENTION DEVICES SHALL NOT BE INSTALLED MORE THAN 5'-0" ABOVE THE FLOOR. PROVIDE A PROTECTIVE STRAINER UPSTREAM OF ALL BACK-FLOW PREVENTION DEVICES UNLESS THE DEVICE CONTAINS A BUILT-IN STRAINER.
- 19) ALL WATER SUPPLY DISTRIBUTION PIPING CONVEYING "NON-POTABLE" WATER SHALL BE PERMANENTLY IDENTIFIED BY A DISTINCTIVE YELLOW-COLORED PAINT.
- 20) PLUMBING CONTRACTOR TO COORDINATE EXACT SIZE AND LOCATION OF EACH FLUE/VENT FOR EACH GAS-FIRED WATER HEATER. COORDINATE WITH MECHANICAL CONTRACTOR AND VERIFY ADEQUATE CHASE/CHIMNEY SPACE WITH ARCHITECT PRIOR TO START OF CONSTRUCTION.
- 21) PLUMBING CONTRACTOR SHALL FURNISH AND INSTALL PVC INTAKE AND EXHAUST EACH GAS-FIRED WATER HEATER. INSTALL PER MANUFACTURER'S RECOMMENDATIONS.
- 22) FURNISH FIRE RATED PIPE SLEEVE OR FIRE CAULKING ON ALL PIPE PENETRATIONS THROUGH FIRE RATED WALLS/FLOORS.
- 23) PLUMBING CONTRACTOR TO VERIFY ALL EXISTING WASTE, VENT AND WATER SUPPLY PIPING WHERE NEW CONNECTIONS ARE TO BE MADE PRIOR TO BID. VERIFY EXACT SIZE, LOCATION, INVERT, CONDITION AND REQUIREMENTS IN FIELD. REPORT ANY MAJOR DISCREPANCIES TO ARCHITECT/ENGINEER IMMEDIATELY.

PLUMBING SPECIFICATIONS

THE GENERAL CONDITIONS AND SUPPLEMENTAL GENERAL CONDITIONS ISSUED BY THE ARCHITECT SHALL GOVERN WHERE APPLICABLE.

THIS CONTRACTOR SHALL THOROUGHLY FAMILIARIZE HIMSELF WITH THE PLANS AND SHALL VERIFY EXISTING SITE CONDITIONS AT THE JOB SITE BEFORE SUBMITTING BID. FAILURE TO RECOGNIZE WORK REQUIRED SHALL BE AT THE EXPENSE OF THIS CONTRACTOR. NO CONSIDERATION SHALL BE GIVEN FOR ADDITIONAL COMPENSATION AFTER THE LETTING OF BIDS.

ENTIRE INSTALLATION SHALL BE PERFORMED IN A FIRST-CLASS WORKMANLIKE MANNER. THE COMPLETED SYSTEMS SHALL BE FULLY OPERATIONAL; ACCEPTANCE BY THE OWNER SHALL BE A CONDITION OF THE CONTRACT. ALL WORK SHALL BE COORDINATED WITH OTHER TRADES IN ORDER TO AVOID INTERFERENCES, PRESERVE MAXIMUM HEADROOM, AND AVOID OMISSIONS.

CONTRACTOR TO MAKE ALL NECESSARY TAPS, AS CALLED FOR ON THE DRAWINGS.

THIS CONTRACTOR SHALL REMOVE ALL DEBRIS ON A REGULAR BASIS AND UPON COMPLETION OF THE JOB AND CLEAN ALL FIXTURES.

COVER ALL HOT, COLD AND HOT WATER RETURN LINES, ROOF DRAINS AND HORIZONTAL DOWNSPOUT PIPING. PIPE COVERING TO BE SHALL BE 3-1/2 LB. DENSITY FIBERGLASS WITH MOLDED FITTINGS AND BUTT JOINTS AND VAPOR BARRIER. WATER PIPING INSULATION SHALL BE INSTALLED PER 2015 IECC SEC. C404.5 & C404.6.

IT SHALL BE THE RESPONSIBILITY OF THIS CONTRACTOR TO START UP, ADJUST AND CHECK FOR PROPER OPERATION ALL EQUIPMENT INSTALLED UNDER HIS CONTRACT.

THIS CONTRACTOR SHALL ALLOW IN HIS INITIAL BID THE COST OF SERVICE ON ALL EQUIPMENT INSTALLED UNDER HIS CONTRACT FOR A PERIOD OF ONE (1) YEAR FROM DATE OF FINAL ACCEPTANCE OF THE WORK.

ALL WATER PIPING SHALL BE TESTED WITH WATER UNDER PRESSURE OF 100 PSI FOR 10 MINUTES, AND MADE TIGHT AT THIS PRESSURE.

ALL SOIL, WASTE AND VENT PIPING SHALL BE SUBJECTED TO A HYDROSTATIC TEST OF NOT LESS THAN 10 FEET OF WATER COLUMN FOR 15 MINUTES BEFORE INSPECTION STARTS AND PROVEN TIGHT.

BEFORE TURNING PLUMBING SYSTEM OVER TO THE OWNER, CHLORINATE ALL DOMESTIC WATER PIPING FOR A PERIOD OF 24 HOURS. AFTER CHLORINATION HAS BEEN COMPLETED, FLUSH ALL PIPING UNTIL WATER RUNS CLEAR AND IS RESIDUAL CHLORINE FREE.

ALL BELOW GROUND WASTE & VENT PIPING SHALL BE SERVICE WEIGHT CAST IRON SCHEDULE 40 PVC IS ACCEPTABLE IF PERMITTED BY LOCAL CODE. THE MINIMUM DIAMETER FOR ALL UNDERGROUND WASTE PIPING IS FOUR (4) INCHES. THE MINIMUM DIAMETER FOR ALL UNDERGROUND VENT PIPING IS TWO (2) INCHES. ALL BELOW GROUND WATER PIPING SHALL BE TYPE "K" COPPER. ALL ABOVE GROUND WATER PIPING SHALL BE TYPE "L" COPPER. ALL ABOVE GROUND WASTE AND VENT PIPING 2" AND SMALLER SHALL BE TYPE "M" COPPER. ALL ABOVE GROUND WASTE AND VENT PIPING 3" AND LARGER SHALL BE SERVICE WEIGHT CAST IRON SCHEDULE 40 PVC IS ACCEPTABLE FOR ABOVE GROUND D.V.V. SYSTEMS IN NON-PLENUM CEILING IF PERMITTED BY LOCAL CODE.

THE PLUMBING SYSTEM SHALL BE INSTALLED IN CONFORMANCE WITH THE STATE OF ILLINOIS PLUMBING CODE AND ALL LOCAL CODES, AMENDMENTS AND ORDINANCES.

SPRINKLER SPECIFICATIONS

THE GENERAL CONDITIONS AND SUPPLEMENTAL GENERAL CONDITIONS ISSUED BY THE ARCHITECT SHALL GOVERN WHERE APPLICABLE.

THIS CONTRACTOR SHALL VERIFY EXISTING SITE CONDITIONS AT THE JOB SITE BEFORE SUBMITTING BID. FAILURE TO RECOGNIZE WORK REQUIRED SHALL BE AT THE EXPENSE OF THIS CONTRACTOR. NO CONSIDERATION SHALL BE GIVEN FOR ADDITIONAL COMPENSATION AFTER THE LETTING OF BIDS.

ENTIRE INSTALLATION SHALL BE PERFORMED IN A FIRST-CLASS WORKMANLIKE MANNER. THE COMPLETED SYSTEMS SHALL BE FULLY OPERATIONAL; ACCEPTANCE BY THE OWNER SHALL BE A CONDITION WITH OTHER TRADES IN ORDER TO AVOID INTERFERENCES, PRESERVE MAXIMUM HEADROOM AND AVOID OMISSIONS.

CONTRACTOR TO MAKE ALL NECESSARY TAPS, AS CALLED FOR ON THE DRAWINGS.

THIS CONTRACTOR SHALL REMOVE ALL DEBRIS ON COMPLETION OF THE JOB AND CLEAN ALL FIXTURES.

IT SHALL BE THE RESPONSIBILITY OF THIS CONTRACTOR TO START-UP, ADJUST AND CHECK FOR PROPER OPERATION, ALL EQUIPMENT INSTALLED UNDER THIS CONTRACT.

THIS CONTRACTOR SHALL ALLOW IN HIS INITIAL BID THE COST OF SERVICE ON ALL EQUIPMENT INSTALLED UNDER HIS CONTRACT FOR A PERIOD OF ONE (1) YEAR FROM DATE OF FINAL INSPECTION OF THE WORK.

THIS CONTRACTOR SHALL SUBMIT TO THE ARCHITECT/ENGINEER, OWNER'S INSURANCE UNDERWRITER, AND LOCAL FIRE DEPARTMENT FOR APPROVAL COMPLETE INSTALLATION AND DESIGN DRAWINGS SHOWING THE SPRINKLER SYSTEM LAYOUTS. THE LAYOUT SHALL INDICATE ALL OF THE SPRINKLER PIPING, SPRINKLER HEAD LOCATIONS AND DETAILS OF ANCHORS AND SUPPORTS AS REQUIRED.

THE SPRINKLER SYSTEM SHALL BE LAID OUT TO ELIMINATE ALL CONFLICTS BETWEEN THE SPRINKLER SYSTEM AND THE STRUCTURE INCLUDING THE MECHANICAL AND ELECTRICAL SYSTEMS AS THEY ARE SHOWN ON THE CONTRACT DRAWINGS.

THE LAYOUT SHALL INDICATE COORDINATION BETWEEN SUCH ITEMS AS DUCTWORK, LIGHTS, STRUCTURAL MEMBERS, ETC. PIPE FOR ABOVE GRADE SHALL BE NEW SCHEDULE 40 FOR BRANCHES AND SCHEDULE 10 FOR MAINS, STANDARD WEIGHT STEEL DESIGNED FOR 175 LB. WORKING PRESSURE, CONFORMING TO A.S.A. B36.10 MANUFACTURED IN THE U.S.

FITTINGS SHALL BE NEW 125 LB. CAST IRON SCREENED OR FLANGED CONFORMING TO A.S.A. B16.4, MANUFACTURED IN THE U.S. AND APPROVED FOR FIRE PROTECTION SPRINKLER SYSTEMS.


THE SPRINKLER RISERS, MAINS AND BRANCH PIPING SHALL BE SUPPORTED FROM THE BUILDING STRUCTURE, USING APPROVED TYPE STEEL HANGERS, BRACKETS, ANCHORS AND STUDS, OF SIZE AND NUMBER IN ACCORDANCE WITH N.F.P.A. #13.

THE SPRINKLER SYSTEM SHALL BE INSTALLED IN CONFORMANCE WITH PAMPHLET 13 OF THE NATIONAL FIRE PROTECTION ASSOCIATION AND ALL REQUIREMENTS OF THE LOCAL FIRE DEPARTMENT AND OWNER'S INSURANCE UNDERWRITER.

ALL PIPING ABOVE GRADE SHALL BE HYDROSTATICALLY TESTED AT 200 PSIG FOR A TWO-HOUR PERIOD IN ACCORDANCE WITH N.F.P.A. #24.


CONTRACTOR IS RESPONSIBLE FOR SPACING, PIPE SIZE, OFFSETS, CLEARANCES, VALVES, ELBOWS, HANGERS, ALL ACCESSORIES AND QUANTITIES FOR ALL.

THIS CONTRACTOR SHALL DESIGN AND INSTALL A COMPLETE SPRINKLER SYSTEM PER NFPA AND LOCAL CODES.

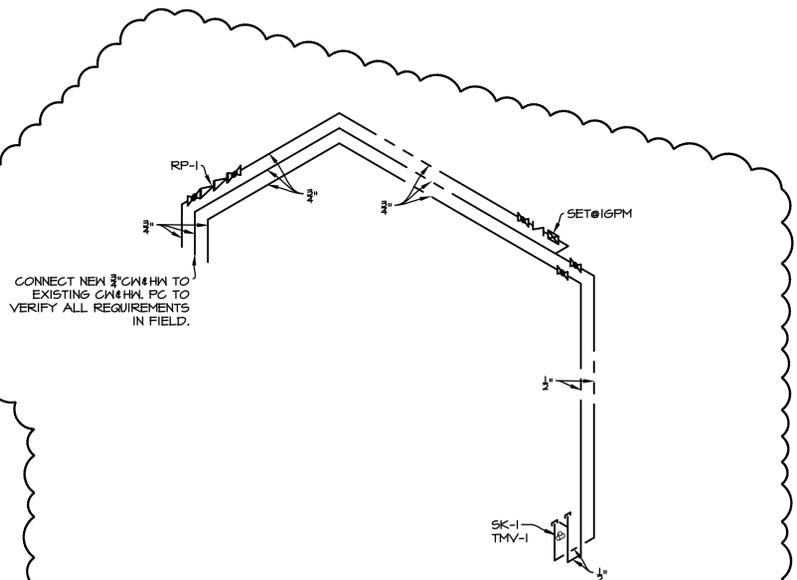

WATER DIAGRAMS

SCALE: NONE

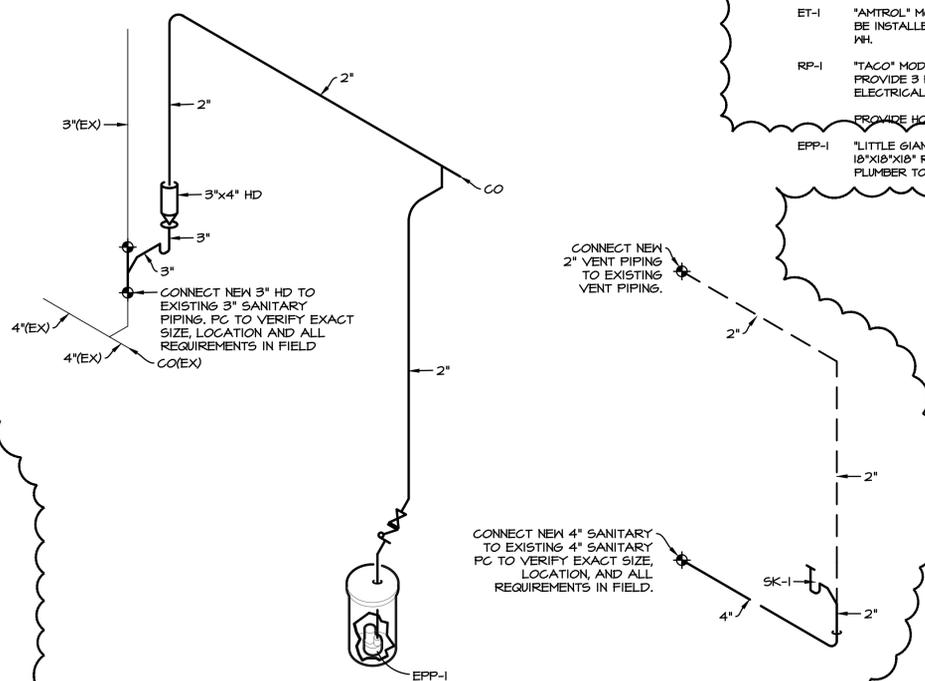

WASTE & VENT DIAGRAMS

SCALE: NONE

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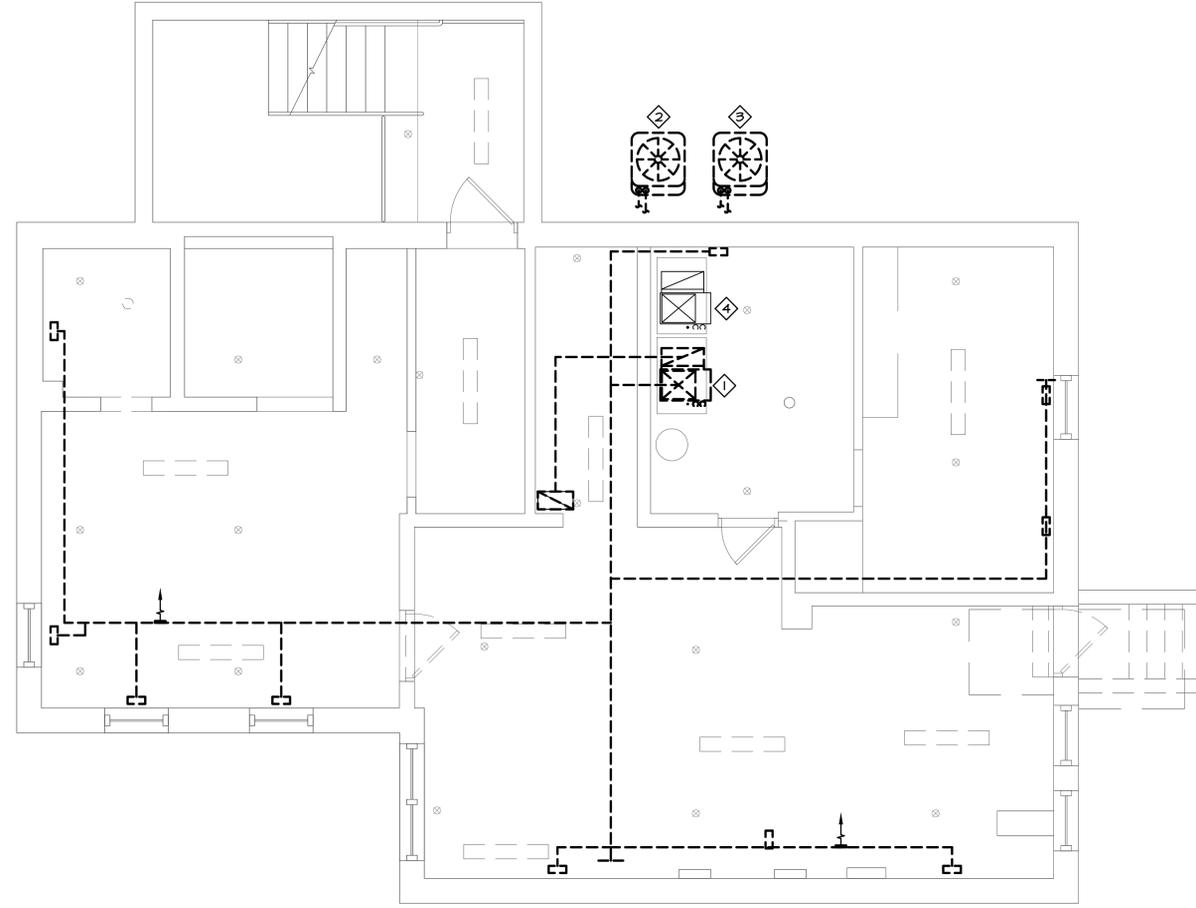
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PLUMBING NOTES, SYMBOLS, SPECIFICATIONS, AND DIAGRAMS

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P2.1

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MECHANICAL BASEMENT DEMOLITION PLAN
SCALE: 1/4" = 1'-0"



- MECHANICAL KEY NOTES**
1. REMOVE FURNACE AND ALL ASSOCIATED DUCTWORK AND AIR DEVICES. CAP GAS PIPING FOR REUSE.
 2. REMOVE CONDENSING UNIT FOR RELOCATION. SEE NEW WORK FOR NEW LOCATION.
 3. REMOVE CONDENSING UNIT AND ALL ASSOCIATED PIPING.
 4. EXISTING FURNACE TO REMAIN.



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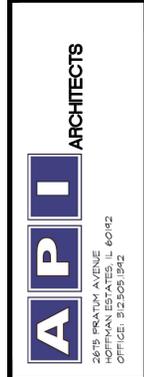


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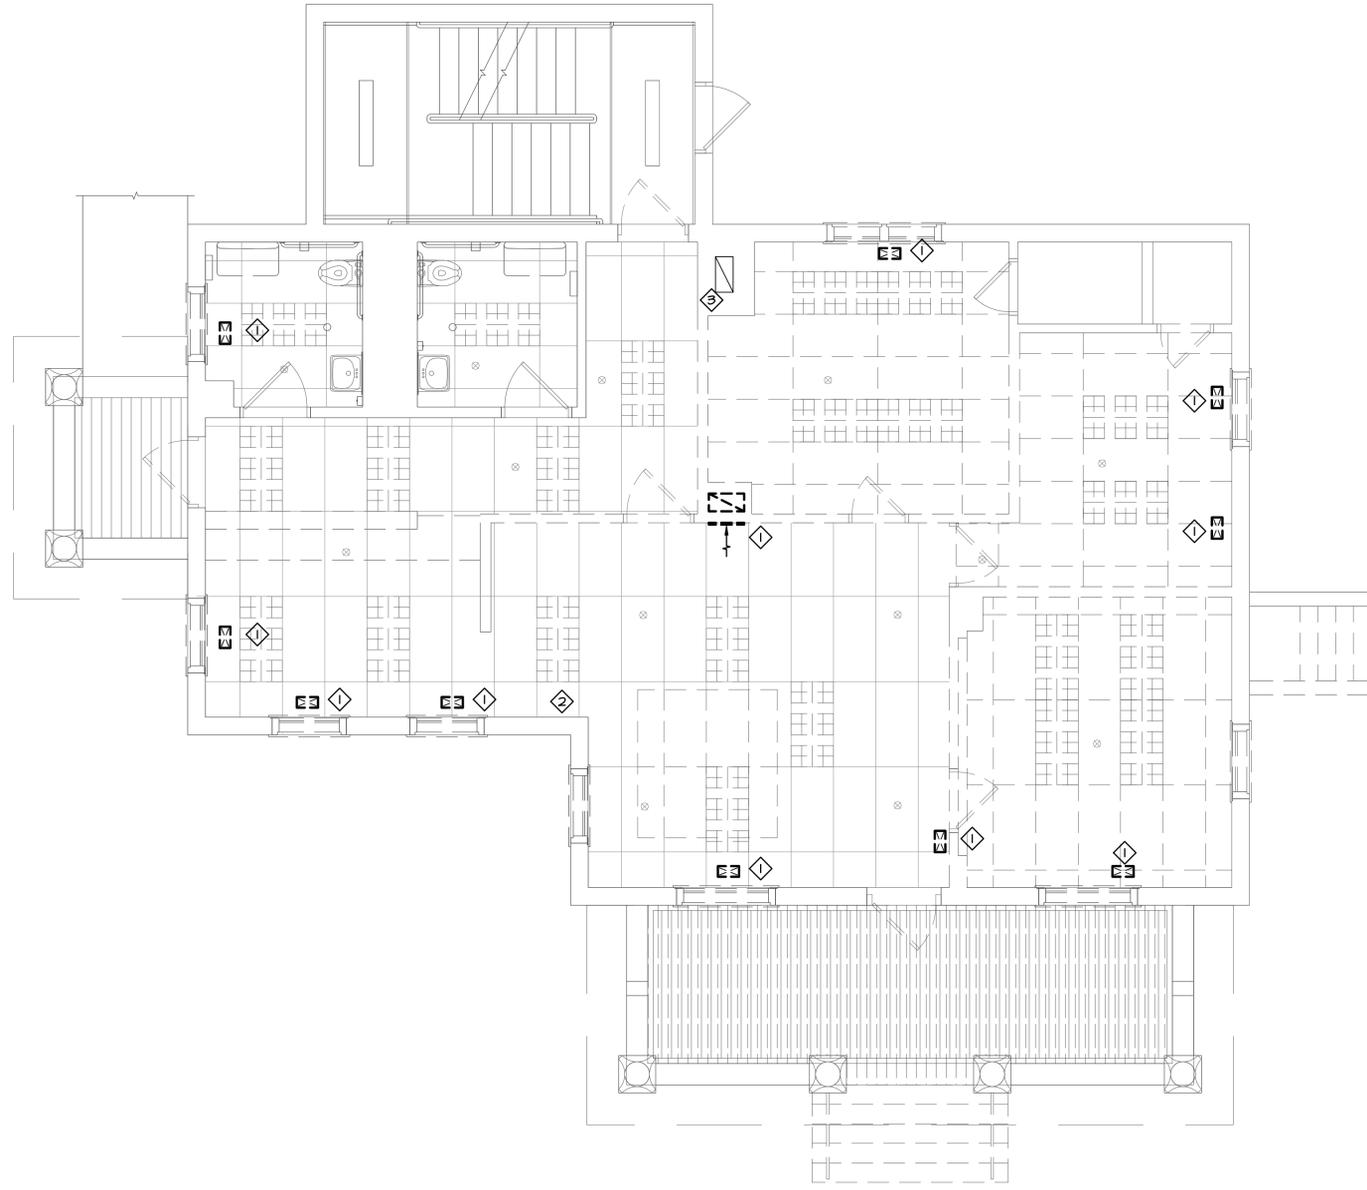
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**MECH. DEMO PLAN
 BASEMENT**

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- MECHANICAL KEY NOTES**
1. REMOVE AIR DEVICE AND ASSOCIATED DUCTWORK.
 2. REMOVE THERMOSTAT, HUMIDITY SENSOR, AND ALL ASSOCIATED WIRING.
 3. RETURN DUCTWORK TO SECOND FLOOR TO REMAIN.

MECHANICAL FIRST FLOOR DEMOLITION PLAN
 SCALE: 1/4" = 1'-0"

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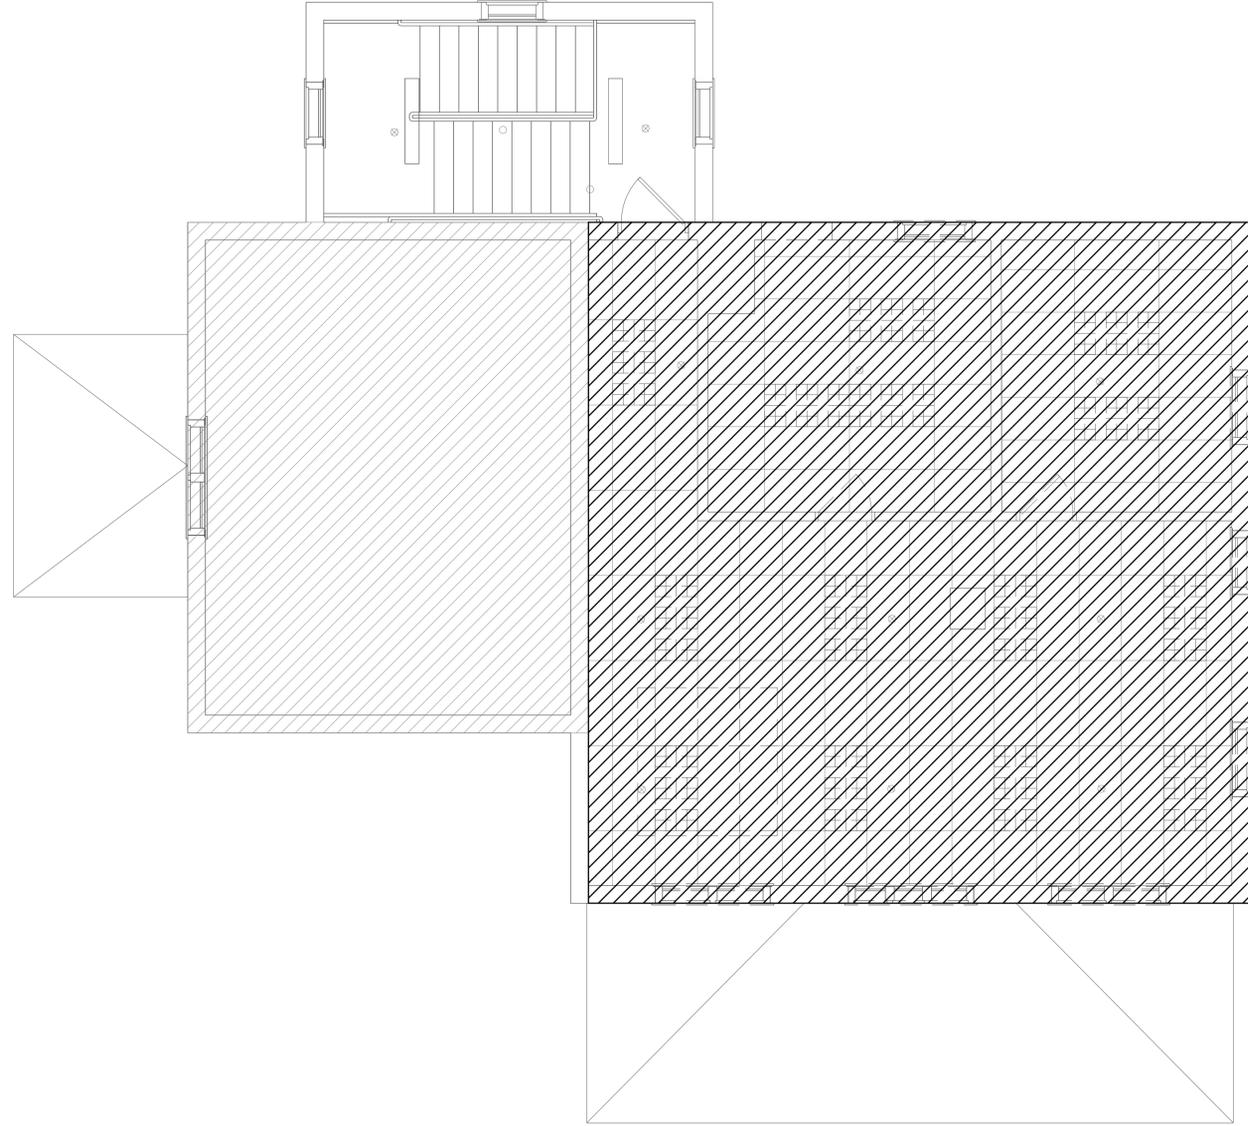
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MECH. DEMO PLAN
FIRST FLOOR
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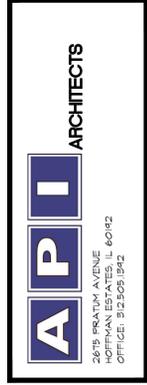
ALL AIR DEVICES
AND DUCTWORK TO
REMAIN. REMOVE
THERMOSTAT/HUMIDITY
CONTROLS AND
ALL ASSOCIATED
WIRING

MECHANICAL SECOND FLOOR DEMOLITION PLAN

SCALE: 1/4" = 1'-0"



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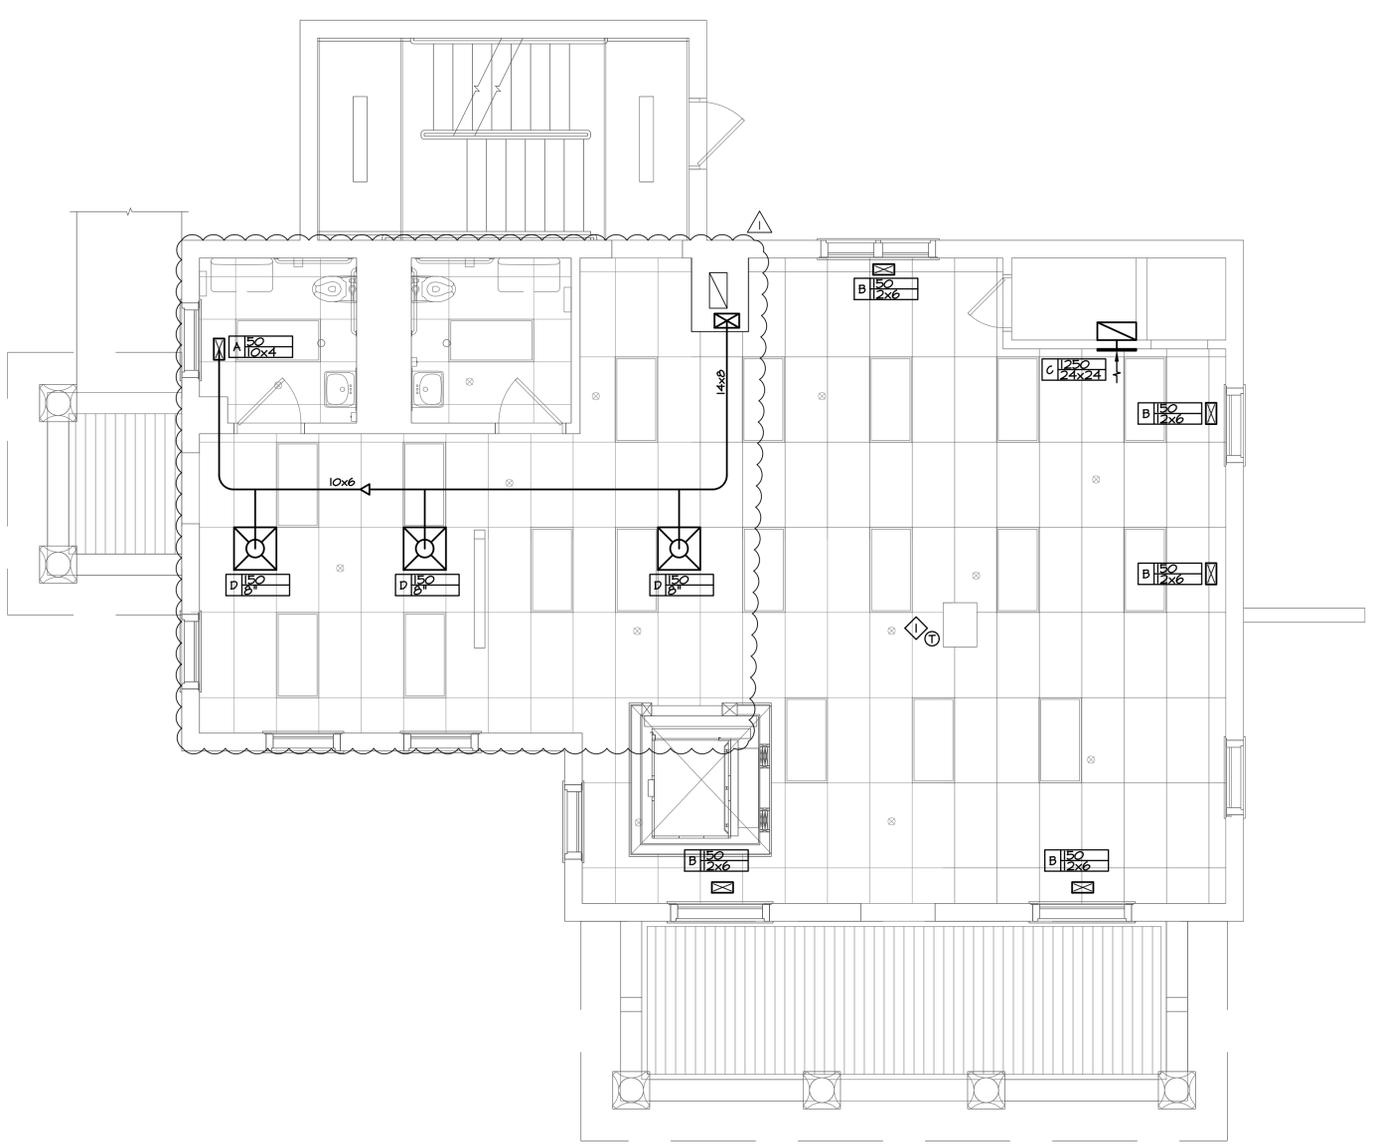
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**MECH. DEMO PLAN
SECOND FLOOR**

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MECHANICAL KEY NOTES

1. LOCATION OF THERMOSTAT AND HUMIDITY CONTROLS.
2. 14x8 DUCT ROUTED UP FROM BASEMENT. ROUTE DUCTWORK ABOVE CEILING.

MECHANICAL FIRST FLOOR NEW WORK PLAN
 SCALE: 1/4" = 1'-0"




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 FIRST FLOOR**
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PROVIDE NEW THERMOSTAT AND HUMIDITY CONTROLS.

MECHANICAL SECOND FLOOR NEW WORK PLAN

SCALE: 1/4" = 1'-0"

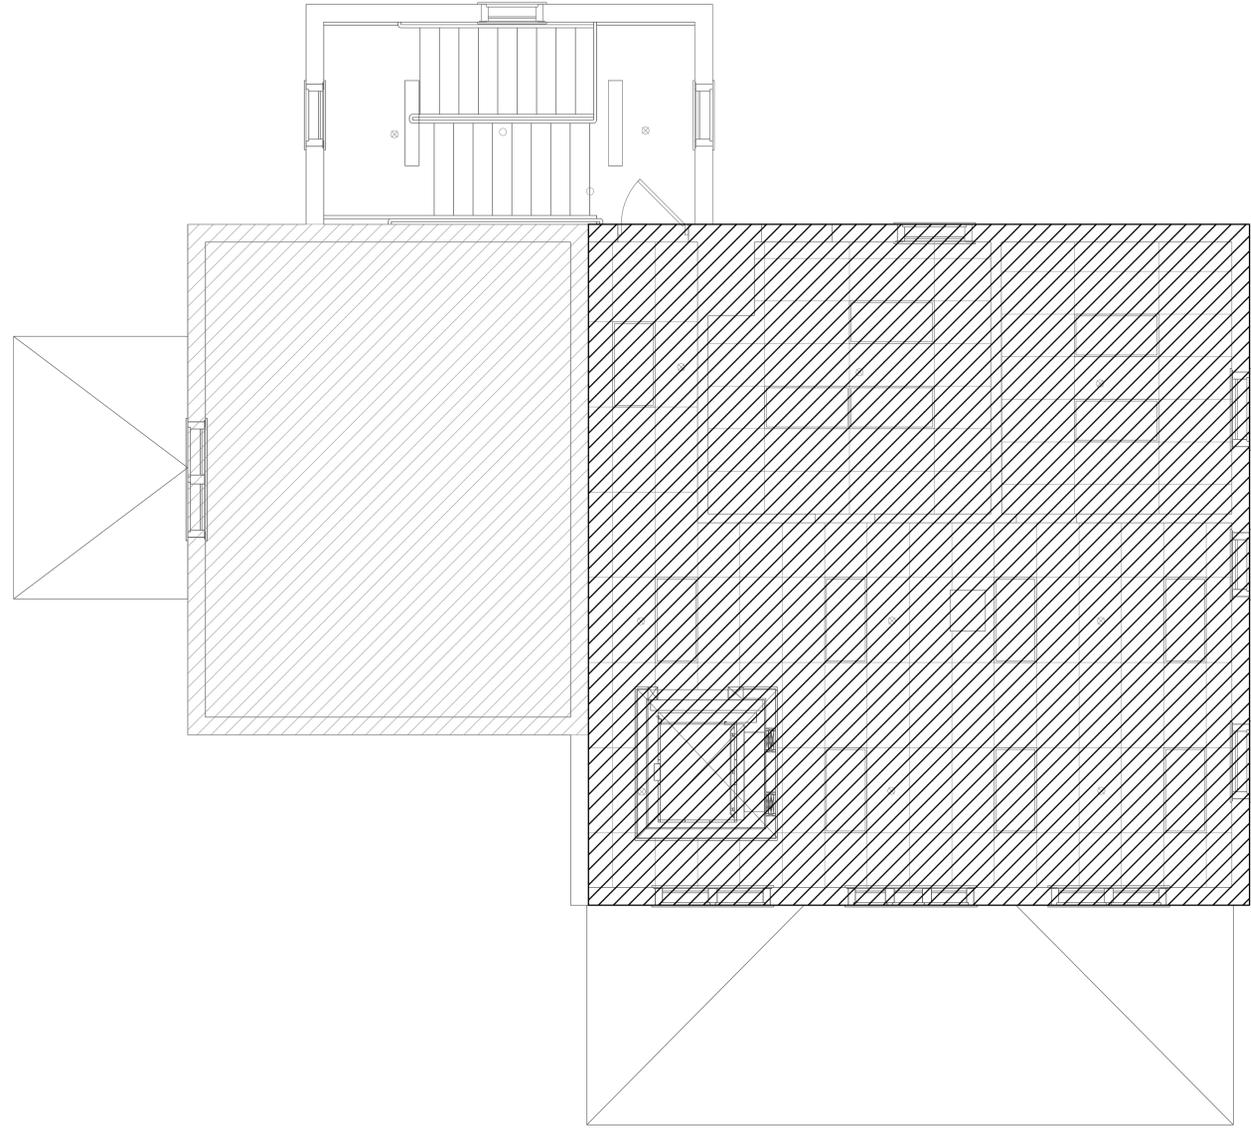

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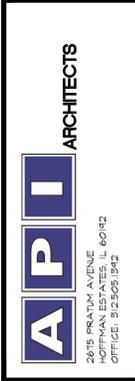
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SECOND FLOOR**

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GAS FIRED FURNACE SCHEDULE

ITEM TAG	MANUFACTURER AND MODEL NUMBER	CFM	ESP	INPUT (BTUH)	OUTPUT (BTUH)	ELECTRICAL DATA				AREA SERVING	VENT SIZES	UNIT WEIGHT (LBS)	REMARKS
						VOLT-PH-HZ	HP	MCA	MOCP				
F-1	CARRIER 50TP6080VIT-16	1700	0.5	52000 80000	50000 78000	120-1-60	3/4	13.4	15	SEE PLAN	2 1/2" V 2 1/2" CA	147	I-7

REMARKS:
 1. PROVIDE 3/4" GAS PIPE CONNECTION WITH REGULATOR, UNION, 6" MIN. DIRT LEG, AND SHUT-OFF VALVE.
 2. ELECTRICAL CONTRACTOR SHALL FURNISH AND INSTALL DISCONNECT SWITCH.
 3. PROVIDE FLEXIBLE CANVAS CONNECTION AT INLET AND DISCHARGE DUCT CONNECTIONS TO UNIT.
 4. PROVIDE PVC VENT PIPING AND CONCENTRIC TERMINATION KIT INSTALLED PER MANUFACTURER'S RECOMMENDATIONS.
 5. PROVIDE 1" THROW AWAY FILTER AND SIDE RACK.
 6. PROVIDE CARRIER 7-DAY PROGRAMMABLE WALL MOUNTED THERMOSTAT WITH HUMIDITY CONTROL.
 7. PROVIDE CARRIER ELECTRIC HUMIDIFIER.

OUTDOOR CONDENSING UNIT SCHEDULE

ITEM TAG	MANUFACTURER AND MODEL NUMBER	SEER	NOMINAL TONS	REFRIG.	REFRIG. CHARGE (LBS)	COOLING CAPACITY (BTUH)	UNIT SERVING	ELECTRICAL DATA				UNIT WEIGHT (LBS)	REMARKS	
								VOLT-PH-HZ	COMP. RLA	COND. FLA	MCA			MOCP
CJ-1	CARRIER 24ACB348-30	13.0	4.0	R-410A	8.00	48000	F-2	208-1-60	11.1	1.20	26.2	40	236	ALL

REMARKS:
 1. VERIFY ELECTRICAL REQUIREMENT WITH ELECTRICAL CONTRACTOR PRIOR TO ORDERING.
 2. PROVIDE TIMED LOCK-OUT, SERVICE VALVES, AND DRYER.
 3. PROVIDE UNIT WITH CASED N-COIL TYPE EVAPORATOR COIL WITH REFRIGERANT SPECIFIC TXV.
 4. MOUNT UNIT LEVEL ON ROOF ON C-PORT AIR-PORT UTILITY PADS.
 5. ELECTRICAL CONTRACTOR SHALL PROVIDE WEATHER PROOF DISCONNECT SWITCH.
 6. PROVIDE DX LIQUID AND SUCTION REFRIGERANT PIPING SIZED FOR ACTUAL FIELD CONDITIONS AND MANUFACTURER'S RECOMMENDATIONS.
 7. PROVIDE REFRIGERANT SAFETY RELIEF VALVE IN ACCORDANCE WITH LOCAL CODES.


GRILLE REGISTER DIFFUSER SCHEDULE

ITEM TAG	MANUFACTURER AND MODEL NUMBER	PURPOSE	DESCRIPTION	REMARKS
A	"HART & COOLEY" #303	SUPPLY	STEEL 3-WAY SIDEWALL/CEILING SUPPLY AIR GRILLE	I
B	"HART & COOLEY" #421	SUPPLY	STEEL 2-WAY FLOOR REGISTER	I
C	"HART & COOLEY" #650	RETURN/EXHAUST	STEEL CEILING RETURN AIR GRILLE	I
D	TITUS OMNI	SUPPLY	SQUARE ADJUSTABLE PLAQUE FACE CEILING DIFFUSER, OPPOSED BLADE DAMPER, BORDER TYPE I, INSULATED BLANKET	I

REMARKS:
 1. COORDINATE COLOR AND FINISH WITH ARCHITECTURAL PLANS.

MECHANICAL GENERAL NOTES

- ALL EQUIPMENT AND COMPONENTS FOR HEATING, VENTILATING, AND AIR CONDITIONING SYSTEMS SHALL COMPLY AND BE INSTALLED FOR THE EFFICIENT UTILIZATION OF ENERGY IN ACCORDANCE WITH LOCAL CODES.
- ALL MECHANICAL EQUIPMENT SHALL BEAR THE LABEL OF AN APPROVED AGENCY, AND SHALL BE INSTALLED IN ACCORDANCE WITH THE INFORMATION ON THE LABEL AND PER THE MANUFACTURER'S RECOMMENDATIONS. THE MECHANICAL CONTRACTOR SHALL MAINTAIN THE MANUFACTURER'S INSTALLATION INSTRUCTIONS FOR ALL MECHANICAL EQUIPMENT AT THE JOB SITE. THE MECHANICAL EQUIPMENT SPECIFIED SHALL MEET ALL APPLICABLE STANDARDS INCLUDING THE INTERNATIONAL MECHANICAL CODE, SMACNA, ASHRAE, AND THE INTERNATIONAL FUEL GAS CODE.
 BOILERS - ANSI Z21.13 OR UL 145
 CLOTHES DRYERS - ANSI Z21.51 OR ANSI Z21.52
 DUCT FURNACES - ANSI Z83.4 OR UL 145
 DIRECT FIRED MAKE-UP AIR HEATERS - ANSI Z83.4
 FORGED WARM AIR FURNACES - ANSI Z21.47 OR UL 145
 INFRARED RADIANT HEATERS - ANSI Z83.6
 UNIT HEATERS - Z83.8
 WATER HEATERS - ANSI Z21.10.1 AND ANSI Z21.10.3
- THE CONSTRUCTION OF ALL DUCTWORK MUST BE IN ACCORDANCE WITH THE LATEST SMACNA DUCT CONSTRUCTION STANDARDS - METAL AND FLEXIBLE. COVERINGS AND LININGS, INCLUDING ADHESIVES, SHALL HAVE A FLAME-SPREAD INDEX NO MORE THAN 25 AND A SMOKE-DEVELOPED INDEX NOT MORE THAN 50, WHEN TESTED IN ACCORDANCE WITH ASTM E 84. DUCT COVERINGS AND LININGS SHALL NOT FLAME, GLOW, SMOLDER OR SMOKE WHEN TESTED IN ACCORDANCE WITH ASTM C 411 AT THE TEMPERATURE TO WHICH THEY ARE EXPOSED IN SERVICE. THE TEST TEMPERATURE SHALL NOT FALL BELOW 250 DEG. F. FLEXIBLE DUCTS AND CONNECTORS SHALL BE TESTED IN ACCORDANCE WITH UL 181 AND BE LABELED. FLEXIBLE CONNECTORS SHALL BE LIMITED TO A MAXIMUM LENGTH OF 10 FEET. DUCTS MUST BE SEALED IN ACCORDANCE WITH THE INTERNATIONAL ENERGY CONSERVATION CODE. RIGID DUCTS MUST BE SUPPORTED AT INTERVALS NOT EXCEEDING 10 FEET. ALL AIR FILTERS SHALL BE LISTED AND LABELED.
- AIR SYSTEMS WITH A DESIGN CAPACITY GREATER THAN 2000 CFM SHALL BE PROVIDED WITH RETURN DUCT MOUNTED SMOKE DETECTOR. ALL RETURN DUCT MOUNTED SMOKE DETECTORS SHALL BE INSTALLED UPSTREAM OF ANY FILTERS, EXHAUST AIR CONNECTIONS AND OUTDOOR AIR CONNECTIONS. SMOKE DETECTORS SHALL BE LABELED FOR INSTALLATION IN AIR DISTRIBUTION SYSTEMS AND INSTALLED IN ACCORDANCE WITH NFPA 72. UPON ACTIVATION, THE SMOKE DETECTOR MUST SHUT DOWN THE AIR DISTRIBUTION SYSTEM.
- MECHANICAL CONTRACTOR SHALL FURNISH AND INSTALL FIRE DAMPERS IN DUCTWORK AND FIRESTOP ALL PIPE PENETRATIONS THRU RATED FLOORS, CEILINGS AND WALLS. VERIFY LOCATIONS OF ALL RATED ASSEMBLIES WITH ARCHITECTURAL PLANS. FIRE DAMPERS SHALL BE IN ACCORDANCE WITH UL 555.
- ALL DIRECT VENT APPLIANCES SHOWN SHALL BE INSTALLED IN ACCORDANCE WITH THEIR LISTING AND PER THE MANUFACTURER'S INSTALLATION INSTRUCTIONS. ALL TERMINATIONS MUST BE IN ACCORDANCE WITH SECTION 503.8 OF THE INTERNATIONAL FUEL GAS CODE.
- GAS PIPING SHALL BE SCHEDULE 40 BLACK IRON PIPE WITH THREADED MALLEABLE IRON FITTINGS. ALL GAS PIPING, VALVES, HANGERS, JOINTS AND CONNECTIONS SHALL BE IN ACCORDANCE WITH THE STANDARDS AND SPECIFICATIONS REFERENCED IN THE CURRENT INTERNATIONAL FUEL GAS CODE. ALL GAS VALVES SHALL BE TESTED AND LABELED IN ACCORDANCE WITH ASME B16.33 OR ANSI Z21.15. PIPING SHALL BE SUPPORTED WITH PIPE HOOKS, METAL PIPE STRAPS, BANDS, BRACKETS, OR HANGERS SUITABLE FOR THE SIZE OF PIPING, OF ADEQUATE STRENGTHS AND QUALITY, AND LOCATED AT INTERVALS SO AS TO PREVENT OR DAMP OUT EXCESSIVE VIBRATION. PIPING SHALL BE ANCHORED TO PREVENT UNDUE STRAINS ON CONNECTED EQUIPMENT AND SHALL NOT BE SUPPORTED BY OTHER PIPING, PIPE HANGERS AND SUPPORTS SHALL CONFORM TO THE REQUIREMENTS OF MSS SP-58 AND SHALL BE SPACED IN ACCORDANCE WITH SECTION 415 OF THE INTERNATIONAL FUEL GAS CODE. SUPPORTS, HANGERS, AND ANCHORS SHALL BE INSTALLED SO AS NOT TO INTERFERE WITH THE FREE EXPANSION AND CONTRACTION OF THE PIPING BETWEEN ANCHORS. ALL PARTS OF THE SUPPORTING EQUIPMENT SHALL BE DESIGNED AND INSTALLED SO MOVEMENT OF THE SUPPORTED PIPING WILL NOT DISENGAGE THEM. GAS PIPING FOR OTHER THAN DRY GAS CONDITIONS SHALL BE SLOPED NOT LESS THAN 1/4 INCH IN 15 FEET. PROVIDE A DRIP LEG AT EACH APPLIANCE CONNECTION. APPLIANCE CONNECTORS TO FOOD SERVICE EQUIPMENT SHALL BY LISTED AND LABELED COMPLYING WITH ANSI Z21.64 AND LISTED FOR USE WITH FOOD SERVICE EQUIPMENT HAVING CASTERS, OR THAT IS OTHERWISE SUBJECT TO MOVEMENT FOR CLEANING, AND OTHER LARGE MOVEABLE EQUIPMENT. ALL GAS PIPING SHALL BE IDENTIFIED AT 5 FOOT INTERVALS. GAS PIPING INSTALLED IN CONCEALED SPACES SHALL NOT HAVE UNIONS, TUBING FITTINGS OR RUNNING THREADS. ALL SHUT-OFF VALVES SHALL BE LOCATED AT THE METER AND AT THE EXTERIOR OF THE BUILDING. ALL FLOW CONTROL VALVES SHALL BE IN ACCORDANCE WITH THE STANDARDS AND SPECIFICATIONS REFERENCED IN THE INTERNATIONAL FUEL GAS CODE SECTION 410.
- THE MECHANICAL CONTRACTOR SHALL HIRE AN INDEPENDENT AND CERTIFIED TEST AND BALANCE CONTRACTOR, AND SHALL PROVIDE A TEST AND BALANCE REPORT TO BE SENT TO THE BUILDING DEPARTMENT NO LESS THAN THREE DAYS PRIOR TO FINAL INSPECTION.

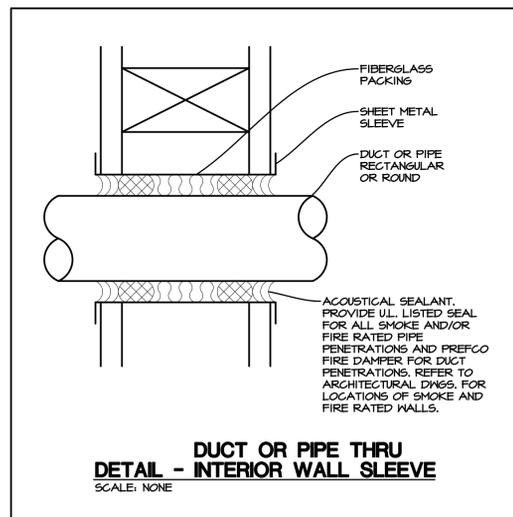

MECHANICAL SPECIFICATIONS

- THE MECHANICAL CONTRACTOR SHALL VISIT THE JOB SITE AND VERIFY ALL EXISTING CONDITIONS IN FIELD AND INCLUDE IN THEIR BID ALL REQUIRED CHANGES TO PROVIDE A COMPLETE OPERATING SYSTEM.
- THIS CONTRACTOR SHALL FURNISH AND INSTALL MATERIAL INDICATED ON DRAWINGS AND AS REQUIRED TO PROVIDE A COMPLETE AND SATISFACTORY OPERATING INSTALLATION.
- ALL MATERIALS SHALL BE NEW AND OF STANDARD QUALITY UNLESS OTHERWISE NOTED; NO REWORKS. ALL MATERIALS FOR WHICH AN UNDERWRITER'S LABORATORY STANDARD EXISTS SHALL BEAR A U.L. LABEL. PROTECT ALL EQUIPMENT AND WORK FROM DAMAGE DUE TO ANY CAUSE.
- ALL WORK SHALL BE EXECUTED IN ACCORDANCE WITH THE NATIONAL, STATE AND LOCAL CODES AND REGULATIONS GOVERNING THE INSTALLATION OF THE WORK INVOLVED. ALL PERMITS FOR THE INSTALLATION OF THE WORK AND ALL INSPECTIONS OF SAME SHALL BE ARRANGED FOR BY THIS CONTRACTOR. ALL FEES AND ASSESSMENTS IN CONNECTION THEREWITH SHALL BE PAID BY THIS CONTRACTOR, THE COST OF WHICH SHALL BE INCLUDED IN THEIR BID.
- THE GENERAL CONDITIONS AND SPECIAL CONDITIONS ISSUED BY THE OWNER AND/OR ARCHITECT SHALL GOVERN WHERE APPLICABLE. GENERAL CONDITIONS AND SPECIAL CONDITION REQUIREMENTS RELATED BUT NOT LIMITED TO THE FOLLOWING SHALL APPLY:
 - RUBBISH REMOVAL.
 - COMPLIANCE WITH THE OWNER'S REQUIREMENTS.
 - OBTAINING AND PAYING FOR REQUIRED LICENSES AND PERMITS.
 - REPLACEMENT OF DAMAGED SYSTEM EQUIPMENT, AND/OR BUILDING DUE TO NEW INSTALLATIONS.
 - COMPLIANCE WITH ALL STATE AND LOCAL CODES AND ORDINANCES.
 - WORKMAN'S COMPENSATION INSURANCE, PUBLIC LIABILITY INSURANCE.
- THE ENTIRE INSTALLATION SHALL BE PERFORMED IN A FIRST-CLASS WORKMANLIKE MANNER. THE COMPLETE SYSTEM SHALL BE FULLY OPERATIONAL AND ACCEPTANCE BY THE OWNER SHALL BE A CONDITION OF THE CONTRACT.
- NEW DUCTWORK AND PIPING SHALL RUN IN STRAIGHT LINES PARALLEL AND/OR PERPENDICULAR TO THE BUILDING CONSTRUCTION, AS HIGH AS POSSIBLE.
- THIS CONTRACTOR SHALL INCLUDE ALL MISCELLANEOUS ITEMS REQUIRED TO COMPLETE THE WORK INCLUDING MOVING AND RIGGING OF MATERIAL AND EQUIPMENT, HANGERS, SUPPORTS, STRUCTURAL FRAMING CHANGES, FITTINGS AND SLEEVES.
- ALL MATERIAL, WORKMANSHIP AND EQUIPMENT SHALL BE GUARANTEED FOR ONE YEAR AFTER SYSTEM ACCEPTANCE. PROVIDE TYPEWRITTEN OPERATING INSTRUCTIONS, AND EQUIPMENT WARRANTIES.
- ALL SHEET METAL DUCTS SHALL BE ERECTED IN FIRST CLASS AND WORKMANLIKE MANNER TRUE TO THE DIMENSIONS INDICATED ON THE DRAWINGS, UNLESS OTHERWISE APPROVED. STRAIGHT AND SMOOTH ON THE INSIDE WITH NEATLY FINISHED AIRTIGHT JOINTS. ALL SLOP JOINTS SHALL BE MADE IN THE DIRECTION OF FLOW, AND UNLESS OTHERWISE INDICATED ON THE DRAWINGS, ALL ELBOWS SHALL HAVE A CENTERLINE RADIUS EQUAL TO 1.5 TIMES THE WIDTH OF THE DUCT. THE SHEET METAL USED SHALL BE GALVANIZED IRON, EXCEPT AS HEREINAFTER SPECIFIED. THE THICKNESS OF THE SHEET METAL AND SIZE AND SPACING OF THE STIFFENERS USED SHALL BE IN ACCORDANCE WITH THE REQUIREMENTS OF THE LATEST EDITION OF THE SMACNA HVAC DUCT CONSTRUCTION STANDARDS - METAL AND FLEXIBLE BOOK. CONSTRUCT DUCTWORK IN ACCORDANCE WITH THE REQUIREMENTS OF SMACNA AND CURRENT LOCAL CODES. ASHRAE GUIDE AND DATA BOOK "SCHEDULE OF RECOMMENDED CONSTRUCTION FOR LOW PRESSURE RECTANGULAR SHEET METAL DUCTS." ALL DUCTWORK SHALL COMPLY WITH ASHRAE AND SMACNA STANDARDS.
- ALL DUCTWORK TO BE SUPPORTED FROM BUILDING CONSTRUCTION WITH ROD HANGERS AND PROPERLY SIZED ANGLE IRON BOTTOM SUPPORTS. THE DUCTS SHALL BE SECURELY ANCHORED TO THE BUILDING IN AN APPROVED MANNER AND SHALL BE SO INSTALLED AS TO BE COMPLETELY FREE FROM VIBRATION UNDER ALL CONDITIONS OF OPERATION. THE DUCTS SHALL BE PROPERLY BRACED AND REINFORCED WITH STEEL ANGLES OR OTHER STRUCTURAL MEMBERS SPACED NOT MORE THAN 60" ON CENTERS. ALL SAGGING DUCTWORK WILL BE REMOVED AND REHING AS DIRECTED BY ENGINEER.
- FLEXIBLE DUCTS AND CONNECTORS SHALL BE TESTED IN ACCORDANCE WITH UL 181 AND BE LABELED. FLEXIBLE DUCTS AND CONNECTORS SHALL BE LIMITED TO A MAXIMUM LENGTH OF 5'-0".
- ALL DUCTWORK SHALL BE INSULATED AS FOLLOWS UNLESS OTHERWISE SPECIFIED ON THE DRAWINGS. COVERINGS AND LININGS, INCLUDING ADHESIVES, SHALL HAVE A FLAME-SPREAD INDEX NO MORE THAN 25 AND A SMOKE-DEVELOPED INDEX NOT MORE THAN 50, WHEN TESTED IN ACCORDANCE WITH ASTM E 84. ALL DUCTWORK LOCATED WITHIN A SPACE THAT DOES NOT DIRECTLY COMMUNICATE WITH THE OUTDOORS, AND IS WITHIN THE BUILDING ENVELOPE SHALL BE CONSIDERED TO BE WITHIN A CONDITIONED SPACE.
 - CONDITIONED SPACES (INCLUDING DUCT IN PLENUM RETURN CEILING)
 - RECTANGULAR: GLASS FIBER LINING WITH R-4 INSTALLED VALUE
 - ROUND: FOIL FACED DUCT WRAP WITH R-4 INSTALLED VALUE
 - *OUTSIDE AIR INTAKE DUCTWORK IN CONDITIONED SPACES SHALL BE WRAPPED WITH R-5 FOIL FACED DUCT WRAP.
 - *EXPOSED SPIRAL DUCTWORK IN CONDITIONED SPACES NOT INSULATED UNLESS COMMUNICATING WITH THE OUTSIDE. IF SO, PROVIDE GLASS FIBER LINING WITH R-4 INSTALLED VALUE
 - UNCONDITIONED SPACE (INCLUDING DUCT IN NON-PLENUM RETURN CEILING)
 - RECTANGULAR: GLASS FIBER LINING WITH R-6 INSTALLED VALUE OR FOIL FACED DUCT WRAP WITH R-6 INSTALLED VALUE
 - ROUND: FOIL FACED DUCT WRAP WITH R-6 INSTALLED VALUE
 - EXTERIOR DUCTWORK
 - RIGID BOARD EXTERIOR INSULATION WITH R-12 INSTALLED VALUE SIMILAR TO "CERTAINTED" COMMERCIAL BOARD WITH WEATHER PROOF ALUMINUM JACKET WRAP SIMILAR TO "VENTURE GLAD" #157CG
- ALL DUCTWORK DIMENSIONS SHOWN ARE CLEAR INSIDE DIMENSIONS.
- THE MECHANICAL CONTRACTOR SHALL SUBMIT (4) FOUR PRODUCT SHOP DRAWINGS FOR ALL NEW EQUIPMENT AND DUCT LAYOUT TO BE FURNISHED FOR ARCHITECT, OWNER, AND ENGINEER'S APPROVAL. CATALOG CUT SHEETS FOR ALL EQUIPMENT AND MATERIAL SHALL BE MADE AVAILABLE ON SITE. ALL EQUIPMENT AND APPLIANCES MUST BEAR LABEL INDICATING SUITABLE FOR USE. THE MECHANICAL CONTRACTOR SHALL SUBMIT THE MANUFACTURER'S INSTALLATION INSTRUCTIONS TO THE BUILDING OWNER, INCLUDING INSTALLATION FOR OUTSIDE INSTALLATION WHEN APPLICABLE.
- THE EQUIPMENT SPECIFIED TO SET STANDARDS, INTENTION IS "OR EQUAL" IF APPROVED PRIOR TO BID DUE DATE.
- THE MECHANICAL CONTRACTOR SHALL HIRE AN INDEPENDENT AND CERTIFIED TEST AND BALANCE CONTRACTOR TO BALANCE SYSTEM TO AIR QUANTITIES AS INDICATED ON PLANS, AND SHALL PROVIDE A TEST AND BALANCE REPORT TO BE SENT TO THE BUILDING DEPARTMENT NO LESS THAN THREE DAYS PRIOR TO FINAL INSPECTION. CONTRACTOR SHALL ALSO PROVIDE COPIES OF THE BALANCE REPORT TO THE OWNER, ARCHITECT, AND ENGINEER. REPORT SHALL ALSO INCLUDE FAN RPM AND PRESSURE INFORMATION.
- PROVIDE 7-DAY PROGRAMMABLE ELECTRONIC THERMOSTAT WITH 2 HOUR OVERRIDE, 10 HOUR BATTERY BACKUP, AUTOCHANGEOVER BETWEEN HEATING AND COOLING MODES, 5 DEGREE DEADBAND, DIGITAL READOUT, AND FAN AUTO/ON CONTROLS. THERMOSTAT SHALL BE MANUFACTURED BY HONEYWELL, WHITE-ROGERS OR APPROVED EQUAL. PROVIDE CLEAR PLASTIC LOCKING COVER WITH KEYS.
- MECHANICAL CONTRACTOR SHALL FURNISH AND INSTALL FIRE DAMPERS IN DUCTWORK AND FIRESTOP ALL PIPE PENETRATIONS THRU RATED FLOORS, CEILINGS AND WALLS. VERIFY LOCATIONS OF ALL RATED ASSEMBLIES WITH ARCHITECTURAL PLANS. FIRE DAMPERS SHALL BE IN ACCORDANCE WITH UL 555. ALL FIRE DAMPERS SHALL BE "TYPE B" OR "TYPE C" DAMPERS WITH STORED DAMPER OUT OF AIRSTREAM UNLESS OTHERWISE NOTED.
- ALL DUCT LAYOUTS, PIPING LAYOUTS, WIRING LAYOUTS, ETC. ARE SCHEMATIC. EXACT LOCATIONS SHALL BE DETERMINED BY THE CONSTRUCTION AND STRUCTURE OF THE BUILDING AND SHALL BE VERIFIED AND COORDINATED IN THE FIELD. EACH TRADE CONTRACTOR SHALL CERTIFY IN WRITING TO THE OWNER AND ARCHITECT THAT HE HAS THOROUGHLY REVIEWED AND COORDINATED ALL LOCATIONS AND ROUTINGS WITH ALL OTHER TRADES PRIOR TO FABRICATION OF DUCTS, PIPING, CONDUITS, ETC. AND START OF INSTALLATION OF SAME. ANY INSTALLATION OF CONSTRUCTION CONFLICTS WHICH OCCUR IN THE FIELD SHALL BE RESOLVED BY THE TRADE CONTRACTOR TO THE SATISFACTION OF THE OWNER AND ARCHITECT AND AT NO EXPENSE TO THE OWNER OR ARCHITECT.

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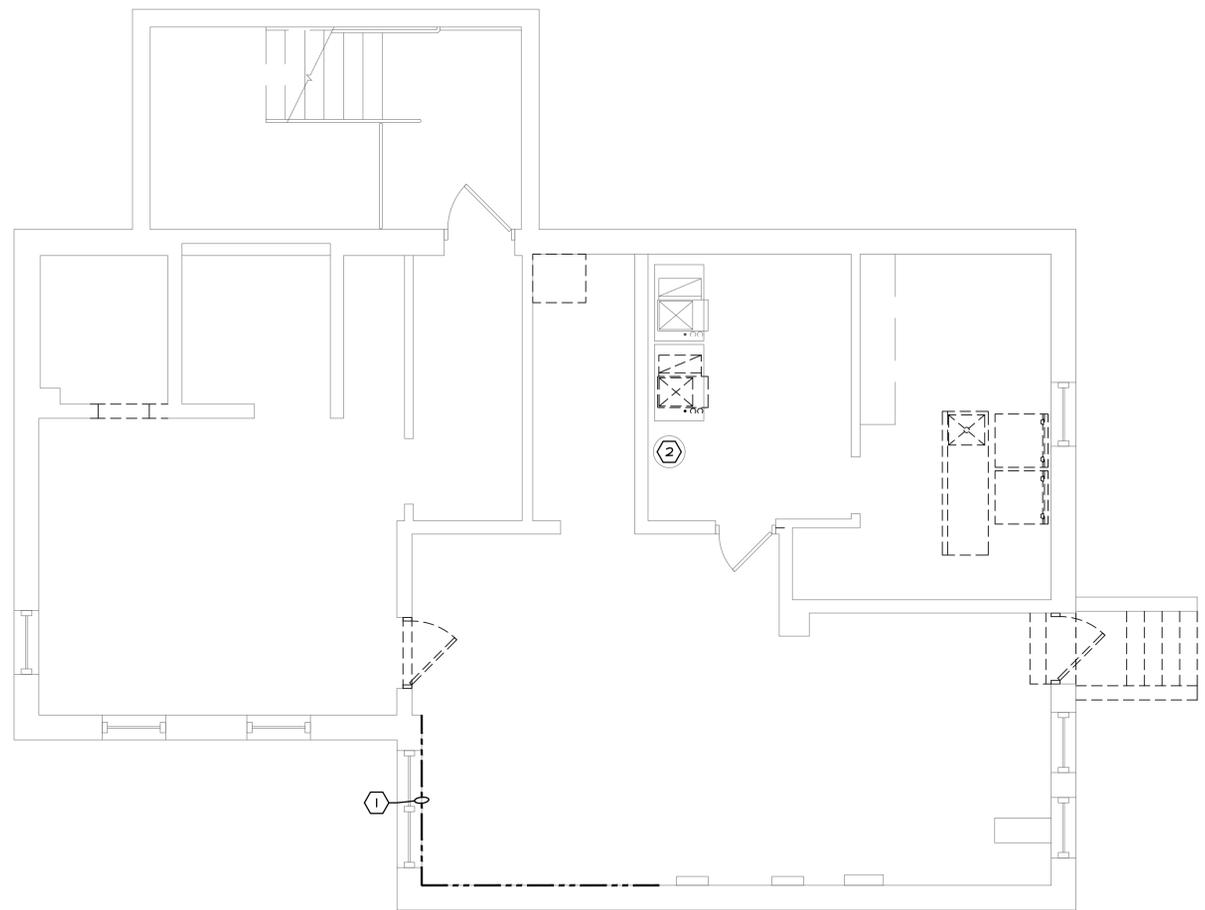
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 State of Illinois

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HOFFMAN ESTATES PARK DISTRICT - VOGELI HOUSE REMODEL
 650 WEST HIGGINS ROAD
 HOFFMAN ESTATES, IL 60169

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MECH. SCHEDULES, DETAILS, AND NOTES
 sheet number:
M2.1



DEMOLITION LEGEND

- E - EXISTING TO REMAIN
- X - EXISTING TO BE REMOVED
- XR - EXISTING TO BE RELOCATED
- XRN - EXISTING, RELOCATED TO NEW LOCATION
- XN - EXISTING DEVICE REPLACED WITH NEW
- XA - EXISTING DEVICE REWIRED WITH NEW CIRCUIT
- XNA - EXISTING DEVICE REPLACED WITH NEW, REWIRED TO NEW CIRCUIT


GENERAL NOTES

1. ALL EXISTING UNUSED CONDUITS SHALL BE COMPLETELY REMOVED BACK TO SOURCE.
2. ALL EXISTING ELECTRICAL INCLUDING BUT NOT LIMITED TO RECEPTACLES, DATA, FIRE ALARM, HVAC, PUMPS, WATER HEATERS ETC. ARE EXISTING TO REMAIN UNLESS NOTED OTHERWISE.

KEYED NOTES

1. ALL EXISTING ELECTRICAL INCLUDING BUT NOT LIMITED TO POWER, DATA, FIRE ALARM, ETC. ALONG NOTED WALL SHALL BE COMPLETELY REMOVED BACK TO SOURCE.
2. POWER FOR EXISTING WATER HEATER SHALL BE COMPLETELY REMOVED BACK TO SOURCE.

ELECTRICAL DEMOLITION PLAN - BASMENT
 SCALE: 1/4" = 1'-0"

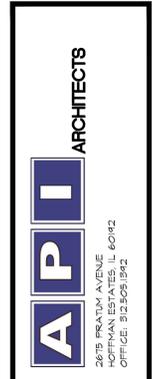

HOFFMAN ESTATES PARK DISTRICT - VOGELI HOUSE REMODEL
 650 WEST HIGGINS ROAD
 HOFFMAN ESTATES, IL 60169
 PROJECT NO. D2100051
 DATE: 07.21.2021
 REVISION 1: 08.27.2021
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 REVISION 3:
 REVISION 4:
 CHECKED: MV
 DRAWN: KC, CS, WT
 SHEET TITLE: ELEC. DEMO PLAN BASEMENT
 SHEET NUMBER: ED.1
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DEMOLITION LEGEND


- E - EXISTING TO REMAIN
- X - EXISTING TO BE REMOVED
- XR - EXISTING TO BE RELOCATED
- XRN - EXISTING, RELOCATED TO NEW LOCATION
- XN - EXISTING DEVICE REPLACED WITH NEW
- XA - EXISTING DEVICE REWIRED WITH NEW CIRCUIT
- XNA - EXISTING DEVICE REPLACED WITH NEW, REWIRED TO NEW CIRCUIT

GENERAL NOTES

1. ALL EXISTING UNUSED CONDUITS SHALL BE COMPLETELY REMOVED BACK TO SOURCE.
2. ALL EXISTING ELECTRICAL INCLUDING BUT NOT LIMITED TO RECEPTACLES, DATA, FIRE ALARM, HVAC, PUMPS, WATER HEATERS ETC. ARE EXISTING TO REMAIN UNLESS NOTED OTHERWISE.

KEYED NOTES


1. ALL EXISTING ELECTRICAL INCLUDING BUT NOT LIMITED TO POWER, DATA, FIRE ALARM, ETC. WITHIN NOTED AREA ON WALL(S) TO BE DEMOLISHED SHALL BE COMPLETELY REMOVED BACK TO SOURCE.
2. POWER FOR EXISTING FURNACE AND CONDENSING UNIT TO BE COMPLETELY REMOVED. COORDINATE WITH MECHANICAL PRIOR TO START OF WORK.

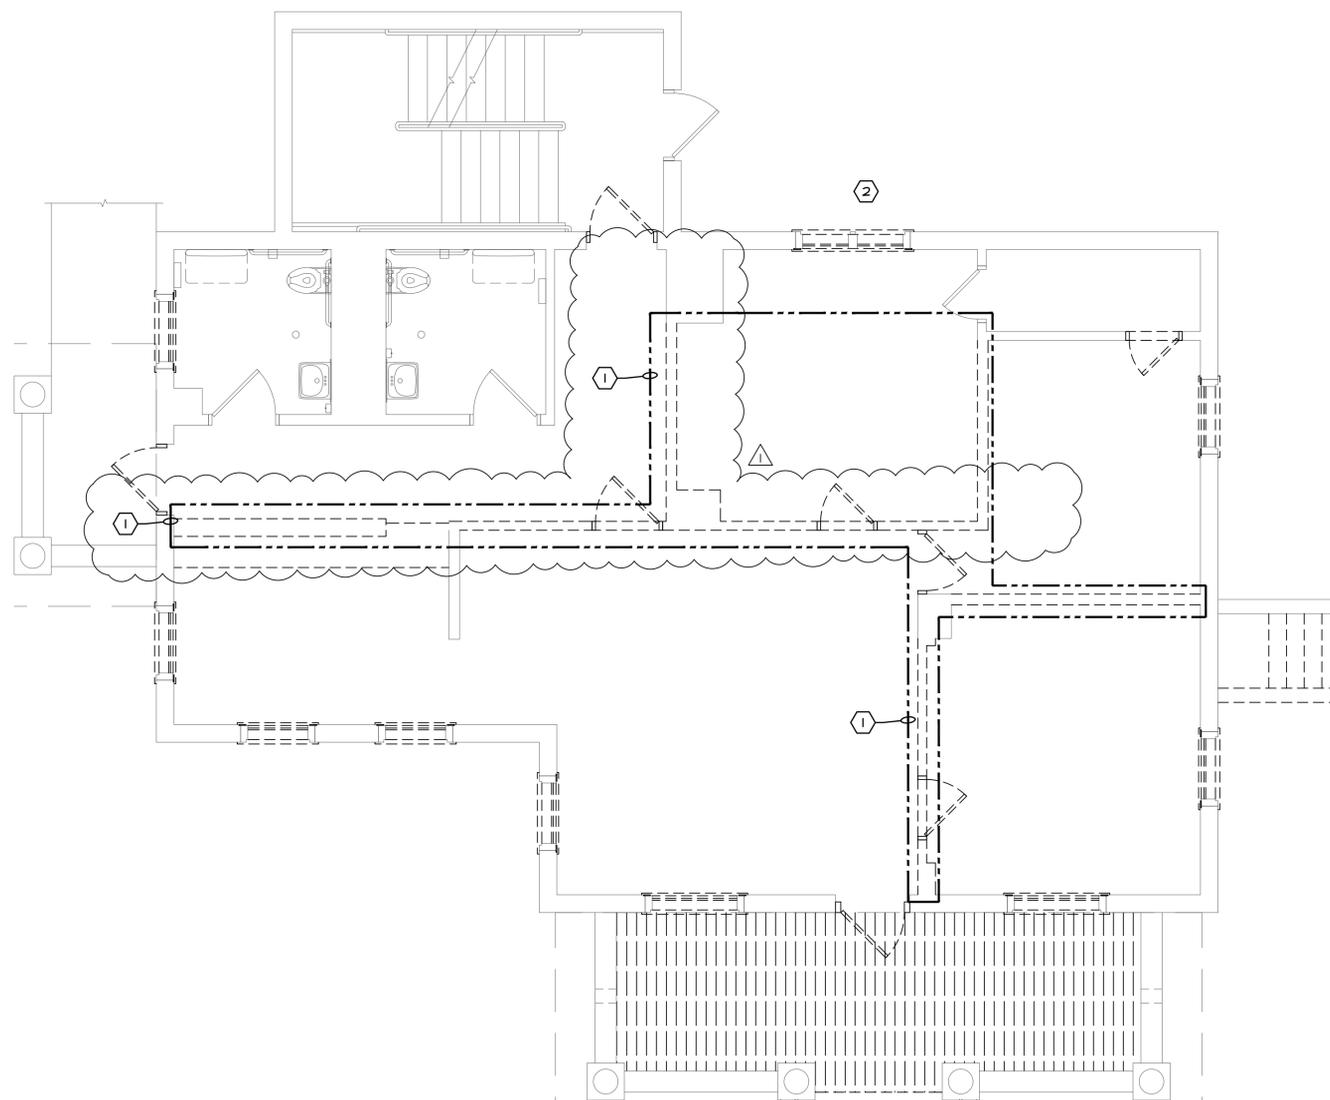

ELECTRICAL DEMOLITION PLAN - 1ST LEVEL

SCALE: 1/4" = 1'-0"

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HOFFMAN ESTATES PARK DISTRICT - VOGELI HOUSE REMODEL
650 WEST HIGGINS ROAD
HOFFMAN ESTATES, IL 60169
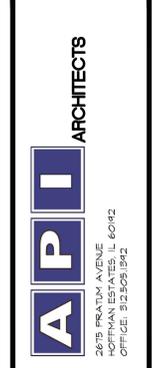
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1ST LEVEL


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DEMOLITION LEGEND

- E - EXISTING TO REMAIN
- X - EXISTING TO BE REMOVED
- XR - EXISTING TO BE RELOCATED
- XRN - EXISTING, RELOCATED TO NEW LOCATION
- XN - EXISTING DEVICE REPLACED WITH NEW
- XX - EXISTING DEVICE REWIRED WITH NEW CIRCUIT
- XXN - EXISTING DEVICE REPLACED WITH NEW, REWIRED TO NEW CIRCUIT


GENERAL NOTES

1. ALL EXISTING UNUSED CONDUITS SHALL BE COMPLETELY REMOVED BACK TO SOURCE.
2. ALL EXISTING ELECTRICAL INCLUDING BUT NOT LIMITED TO RECEPTACLES, DATA, FIRE ALARM, HVAC, PUMPS, WATER HEATERS ETC. ARE EXISTING TO REMAIN UNLESS NOTED OTHERWISE.

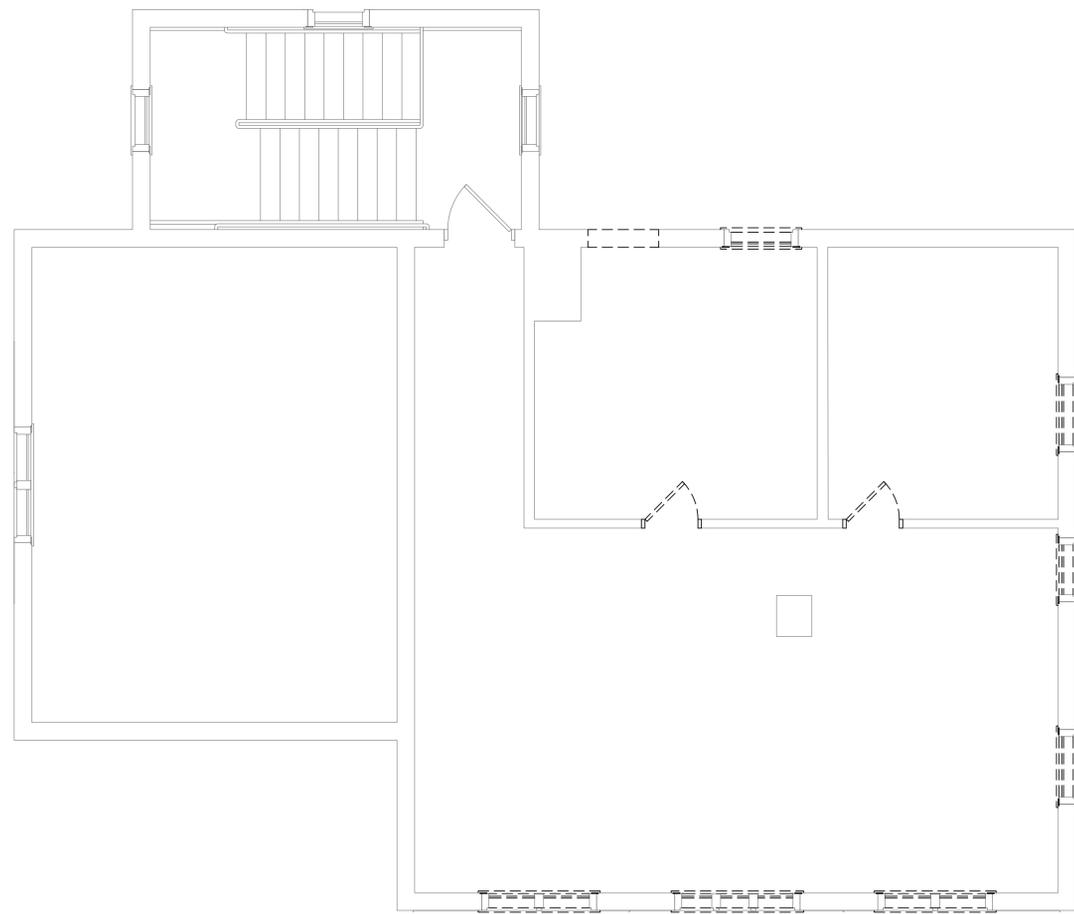

ELECTRICAL DEMOLITION PLAN - 2ND LEVEL

SCALE: 1/4" = 1'-0"

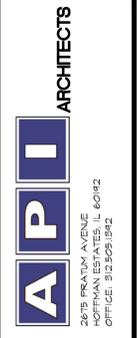

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HOFFMAN ESTATES PARK DISTRICT - VOGELI HOUSE REMODEL
650 WEST HIGGINS ROAD
HOFFMAN ESTATES, IL 60169

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DEMOLITION LEGEND


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GENERAL NOTES


1. ALL EXISTING UNUSED CONDUITS AND CONDUCTORS SHALL BE COMPLETELY REMOVED BACK TO SOURCE.
2. ALL EXISTING EMERGENCY LIGHTING AND EXIT SIGNAGE ARE EXISTING TO BE REMOVED/ EXISTING TO BE REPLACED WITH NEW.
3. ALL EXISTING EXTERIOR LIGHTING AND EMERGENCY LIGHTING ARE TO REMAIN.
4. ALL EXISTING LIGHTING FIXTURES AND CONTROLS ARE TO REMAIN UNLESS NOTED OTHERWISE.

KEYED NOTES

1. WITHIN NOTED AREA, EXISTING LOCAL LIGHTING CIRCUIT SHALL BE DISCONNECTED FROM EXISTING LIGHTING FIXTURES/ CONTROLS AND BE RECONNECTED TO NEW LIGHTING FIXTURES AND CONTROLS.

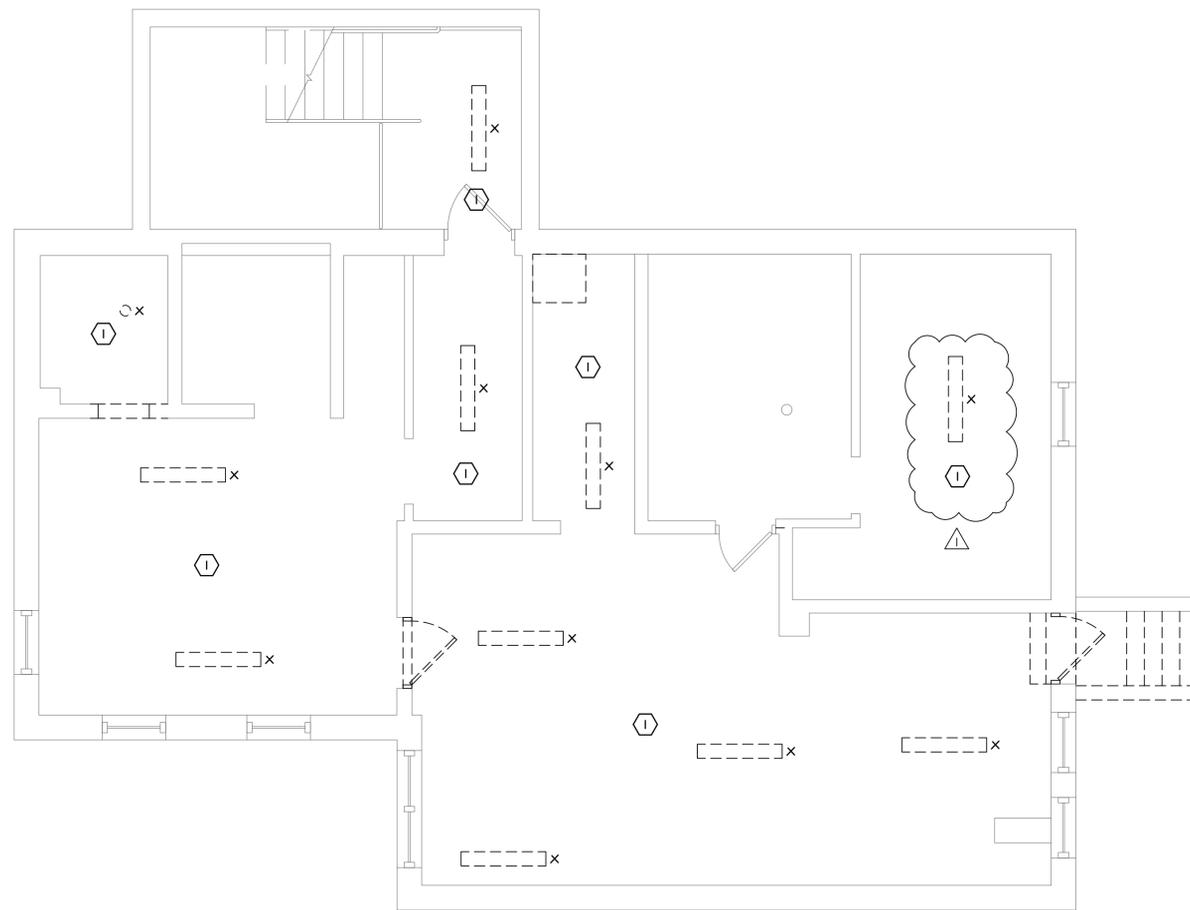

ELECTRICAL DEMOLITION PLAN - BASMENT
SCALE: 1/4" = 1'-0"

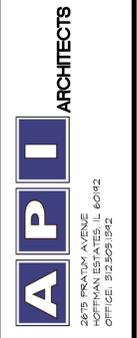

HOFFMAN ESTATES PARK DISTRICT - VOGELI HOUSE REMODEL
 650 WEST HIGGINS ROAD
 HOFFMAN ESTATES, IL 60169

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DEMOLITION LEGEND


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GENERAL NOTES

1. ALL EXISTING UNUSED CONDUITS AND CONDUCTORS SHALL BE COMPLETELY REMOVED BACK TO SOURCE.
2. ALL EXISTING EMERGENCY LIGHTING AND EXIT SIGNAGE ARE EXISTING TO BE REMOVED/ EXISTING TO BE REPLACED WITH NEW.
3. ALL EXISTING EXTERIOR LIGHTING AND EMERGENCY LIGHTING ARE TO REMAIN.
4. ALL EXISTING LIGHTING FIXTURES AND CONTROLS ARE TO REMAIN UNLESS NOTED OTHERWISE.

KEYED NOTES

1. WITHIN NOTED AREA, EXISTING LOCAL LIGHTING CIRCUIT SHALL BE DISCONNECTED FROM EXISTING LIGHTING FIXTURES/ CONTROLS AND BE RECONNECTED TO NEW LIGHTING FIXTURES AND CONTROLS.

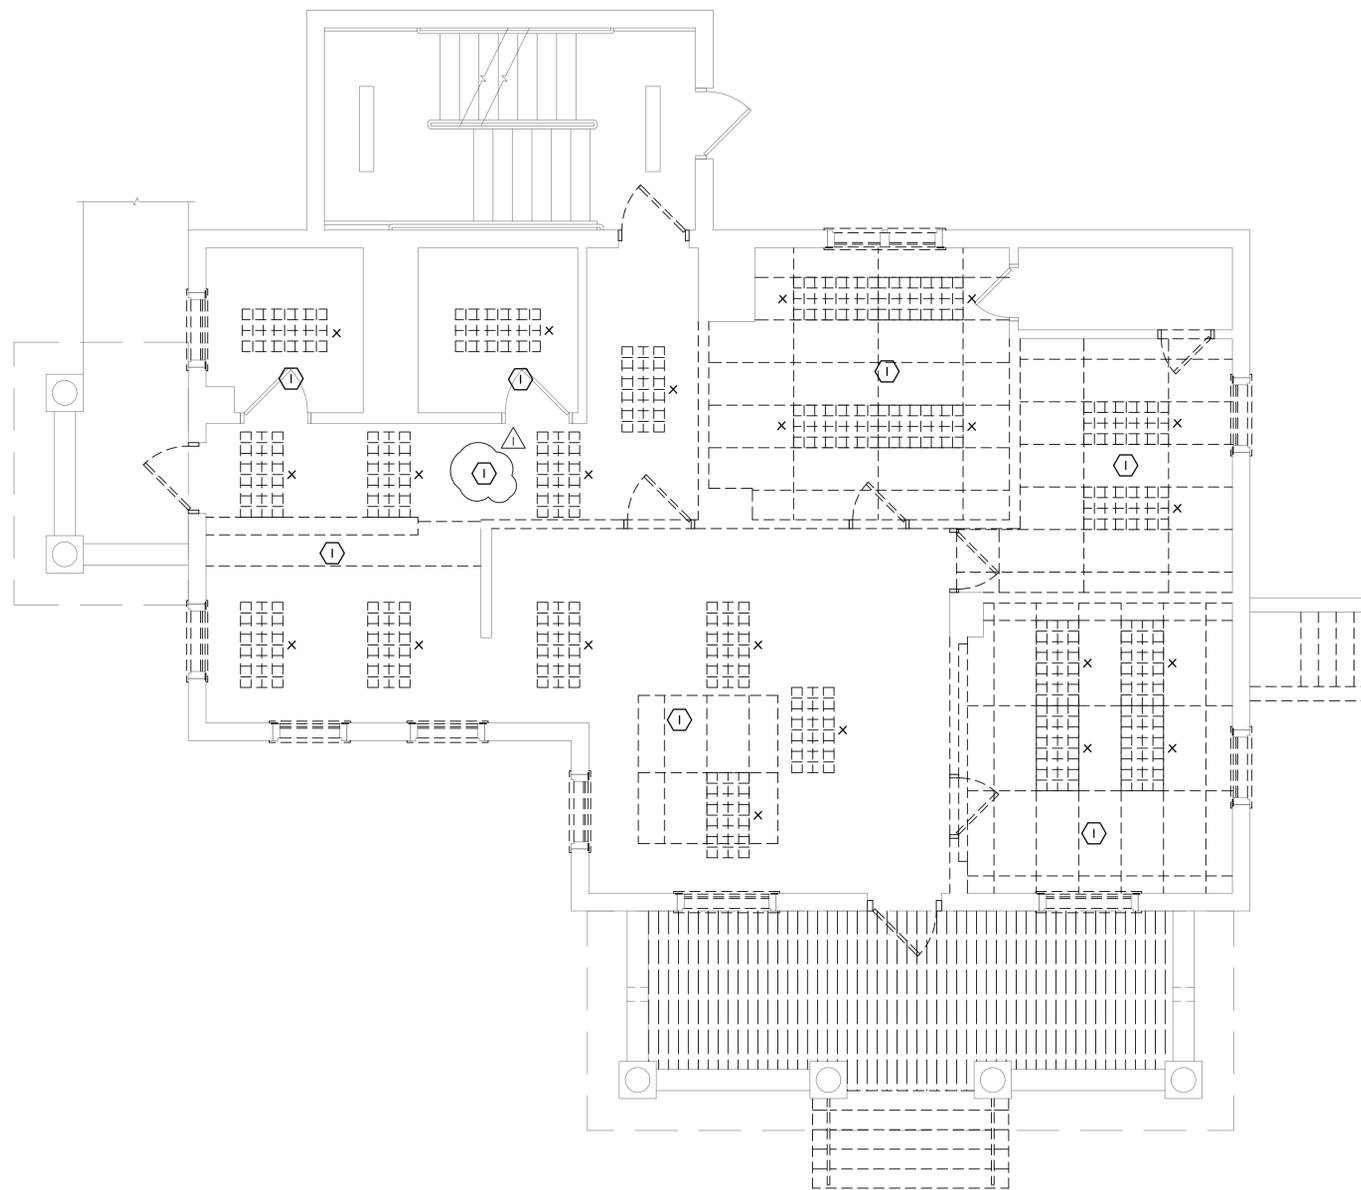

ELECTRICAL DEMOLITION PLAN - 1ST LEVEL

SCALE: 1/4" = 1'-0"

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DEMOLITION LEGEND


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- XX - EXISTING DEVICE REWIRED WITH NEW CIRCUIT
- XXN - EXISTING DEVICE REPLACED WITH NEW, REWIRED TO NEW CIRCUIT

GENERAL NOTES

1. ALL EXISTING UNUSED CONDUITS AND CONDUCTORS SHALL BE COMPLETELY REMOVED BACK TO SOURCE.
2. ALL EXISTING EMERGENCY LIGHTING AND EXIT SIGNAGE ARE EXISTING TO BE REMOVED/ EXISTING TO BE REPLACED WITH NEW.
3. ALL EXISTING EXTERIOR LIGHTING AND EMERGENCY LIGHTING ARE TO REMAIN.
4. ALL EXISTING LIGHTING FIXTURES AND CONTROLS ARE TO REMAIN UNLESS NOTED OTHERWISE.


KEYED NOTES

1. WITHIN NOTED AREA, EXISTING LOCAL LIGHTING CIRCUIT SHALL BE DISCONNECTED FROM EXISTING LIGHTING FIXTURES/ CONTROLS AND BE RECONNECTED TO NEW LIGHTING FIXTURES AND CONTROLS.

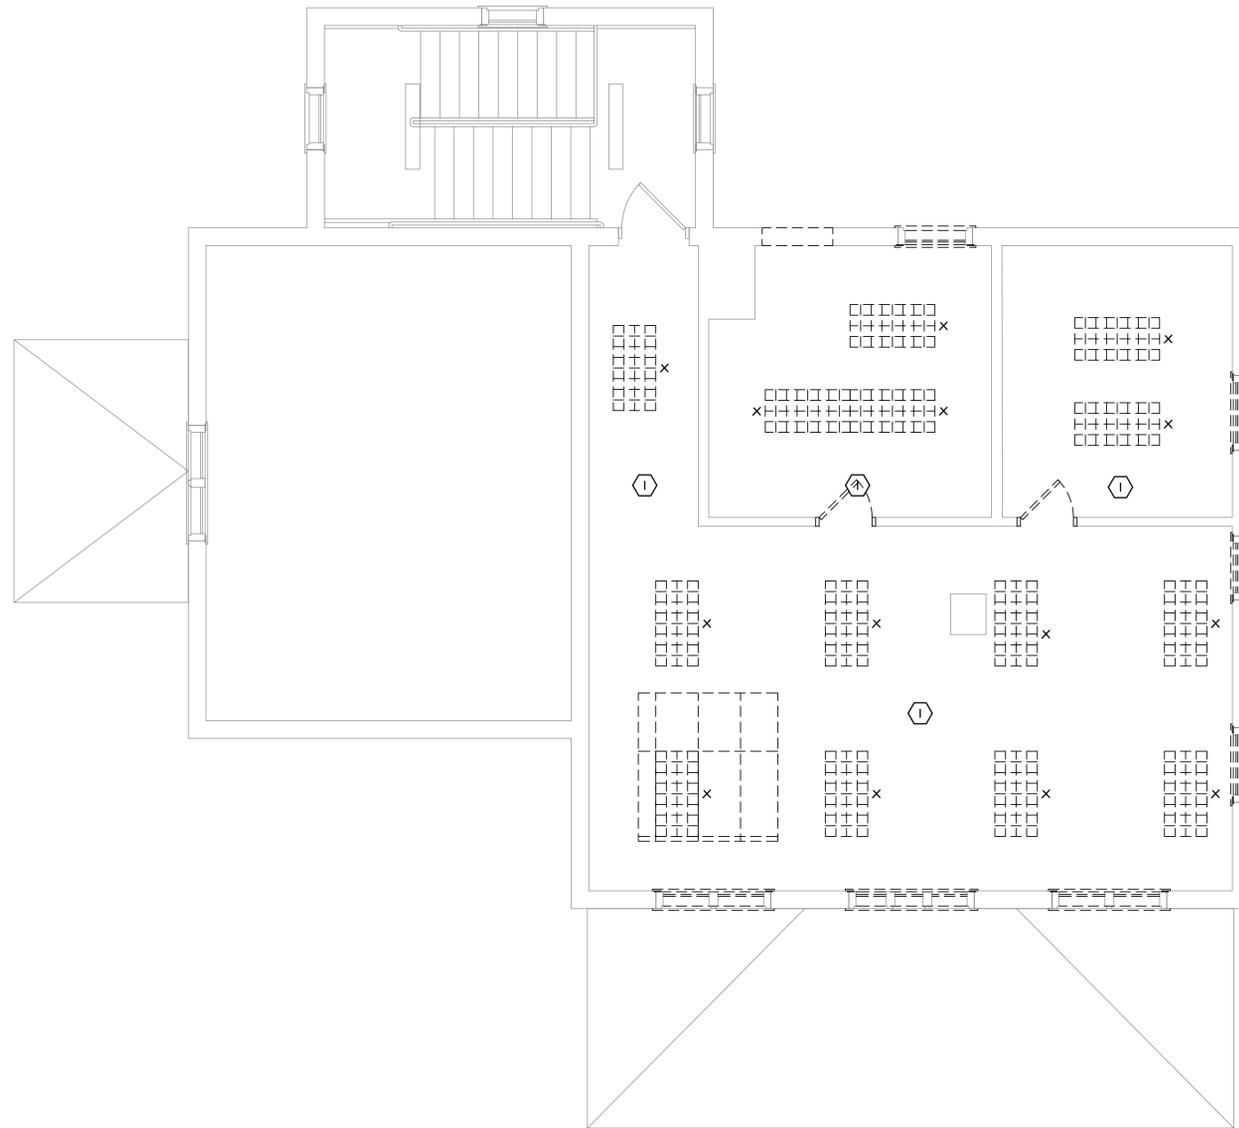

ELECTRICAL DEMOLITION PLAN - 2ND LEVEL

SCALE: 1/4" = 1'-0"

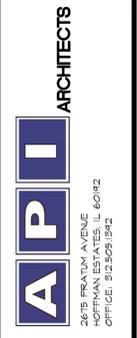

HOFFMAN ESTATES PARK DISTRICT - VOGELI HOUSE REMODEL
650 WEST HIGGINS ROAD
HOFFMAN ESTATES, IL 60169

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FIRE ALARM NOTES


1. PROVIDE ALL ALARM DEVICES, NOTIFICATION DEVICES, PANELS, ETC. REQUIRED BY LOCAL CODES. PROVIDE NETWORK/TERMINATION PANELS AS REQUIRED.
2. PROVIDE COMPLETE FIRE ALARM PERMIT AND CONSTRUCTION DOCUMENTS. SUBMIT DOCUMENTS TO PERMITTING AUTHORITY AND RE-SUBMIT BASED ON COMMENTS. OBTAIN AGENCY APPROVAL PRIOR TO INSTALLATION.
3. PROVIDE HORN/STROBE DEVICES AS REQUIRED BY LOCAL FIRE OFFICIALS AND WIRE TO FIRE ALARM CONTROL PANEL. DEVICE LAYOUT IS REPRESENTATIVE ONLY. PROVIDE ACTUAL QUANTITY OF DEVICES PER IFC AND PER LOCAL AUTHORITY HAVING JURISDICTION REQUIREMENTS.
4. PROVIDE BATTERY AND VOLTAGE DROP CALCULATIONS.
5. CONTRACTOR SHALL REUSE/RELOCATE EXISTING FIRE ALARM DEVICES AND PROVIDE NEW WHERE REQUIRED.

DEMOLITION LEGEND

- E - EXISTING TO REMAIN
- X - EXISTING TO BE REMOVED
- XR - EXISTING TO BE RELOCATED
- XRN - EXISTING, RELOCATED TO NEW LOCATION
- XN - EXISTING DEVICE REPLACED WITH NEW
- XA - EXISTING DEVICE REQUIRED WITH NEW CIRCUIT
- XNA - EXISTING DEVICE REPLACED WITH NEW, REQUIRED TO NEW CIRCUIT

KEYED NOTES

1. NEW 2 CHANNEL POWER POLE FOR OFFICE POWER/ DATA. COORDINATE EXACT LOCATION AND REQUIREMENTS WITH OWNER PRIOR TO INSTALLATION.
2. ELEVATOR CAR LIGHTING DISCONNECT SWITCH; 30A/240V/2P, NEMA-1 FDS @ 15A WITH SHUNT TRIP AND AUXILIARY CONTACT CAPABILITIES. COORDINATE EXACT LOCATION AND REQUIREMENTS WITH ELEVATOR SUPPLIER PRIOR TO START OF WORK. PROVIDE NEW 15A/1P C/B WITHIN ADJACENT ELECTRICAL PANEL.
3. ELEVATOR POWER DISCONNECT SWITCH; 30A/240V/3P, NEMA-1 FDS @ 20A WITH SHUNT TRIP AND AUXILIARY CONTACT CAPABILITIES. COORDINATE EXACT LOCATION AND REQUIREMENTS WITH ELEVATOR SUPPLIER PRIOR TO START OF WORK. PROVIDE NEW 20A/3P C/B WITHIN ADJACENT ELECTRICAL PANEL. ELECTRICAL CONTRACTOR SHALL VERIFY LOAD ON EXISTING ADJACENT PANELS PRIOR TO INSTALLATION OF ELEVATOR CIRCUIT BREAKER. 4#10, #1006, 3/4"C.
4. TELEPHONE CONNECTION FOR ELEVATOR; COORDINATE EXACT LOCATION AND REQUIREMENTS WITH ELEVATOR SUPPLIER PRIOR TO START OF WORK.

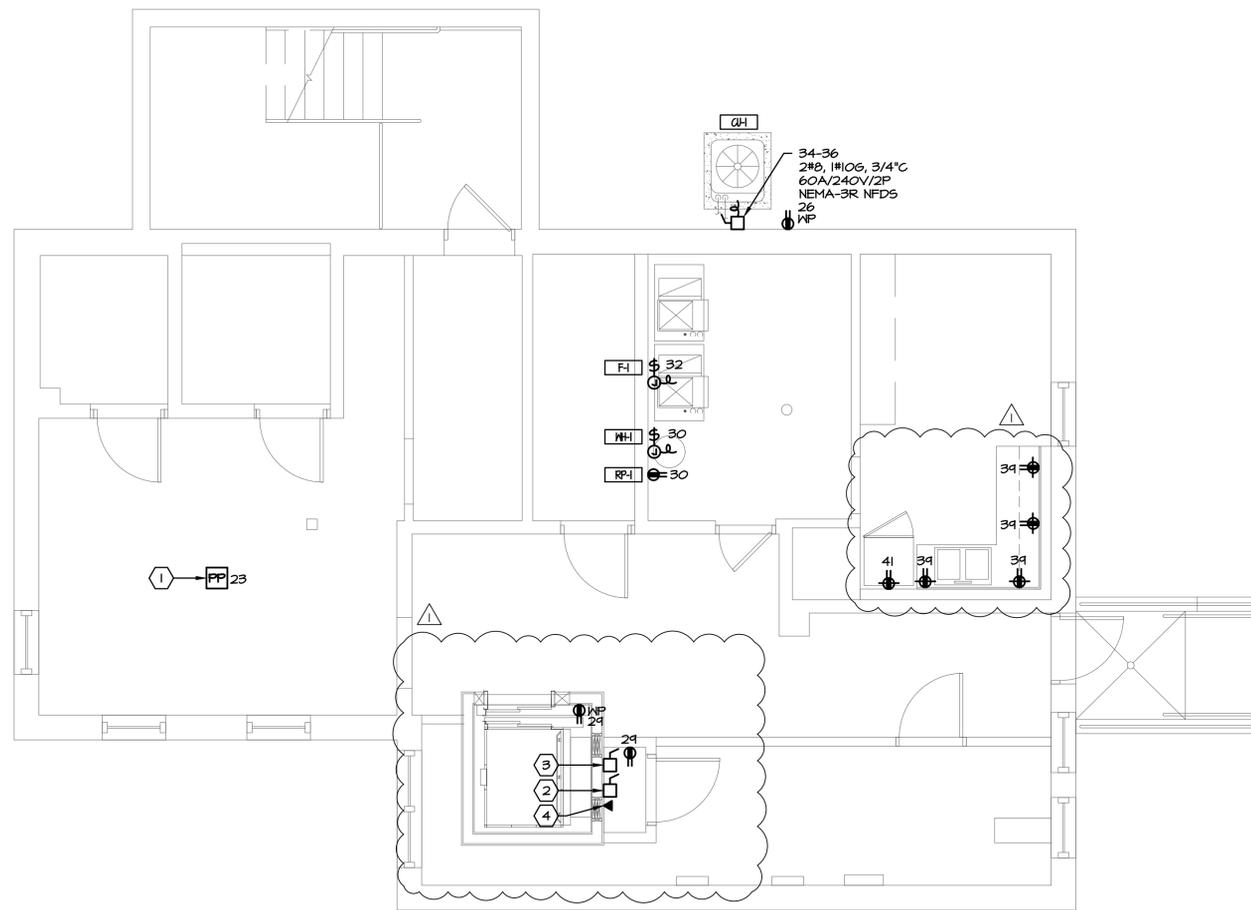

34-36
2#6, #1006, 3/4"C
60A/240V/2P
NEMA-3R NFDS
26
MP

FI 32
MH 30
RP1 30


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ELECTRICAL POWER PLAN - BASMENT

SCALE: 1/4" = 1'-0"



HOFFMAN ESTATES PARK DISTRICT - VOGELI HOUSE REMODEL
650 WEST HIGGINS ROAD
HOFFMAN ESTATES, IL 60169

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BASEMENT
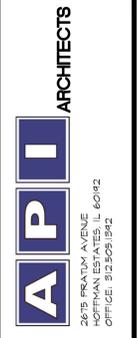
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FIRE ALARM NOTES


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2. PROVIDE COMPLETE FIRE ALARM PERMIT AND CONSTRUCTION DOCUMENTS. SUBMIT DOCUMENTS TO PERMITTING AUTHORITY AND RE-SUBMIT BASED ON COMMENTS. OBTAIN AGENCY APPROVAL PRIOR TO INSTALLATION.
3. PROVIDE HORN/STROBE DEVICES AS REQUIRED BY LOCAL FIRE OFFICIALS AND WIRE TO FIRE ALARM CONTROL PANEL. DEVICE LAYOUT IS REPRESENTATIVE ONLY. PROVIDE ACTUAL QUANTITY OF DEVICES PER IFC AND PER LOCAL AUTHORITY HAVING JURISDICTION REQUIREMENTS.
4. PROVIDE BATTERY AND VOLTAGE DROP CALCULATIONS.
5. CONTRACTOR SHALL REUSE/RELOCATE EXISTING FIRE ALARM DEVICES AND PROVIDE NEW WHERE REQUIRED.

DEMOLITION LEGEND

- E - EXISTING TO REMAIN
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- XX - EXISTING DEVICE REWIRED WITH NEW CIRCUIT
- XXN - EXISTING DEVICE REPLACED WITH NEW, REWIRED TO NEW CIRCUIT


KEYED NOTES

1. NEW LIFT; COORDINATE EXACT LOCATION AND REQUIREMENTS WITH OWNER/ MANUFACTURER PRIOR TO INSTALLATION.

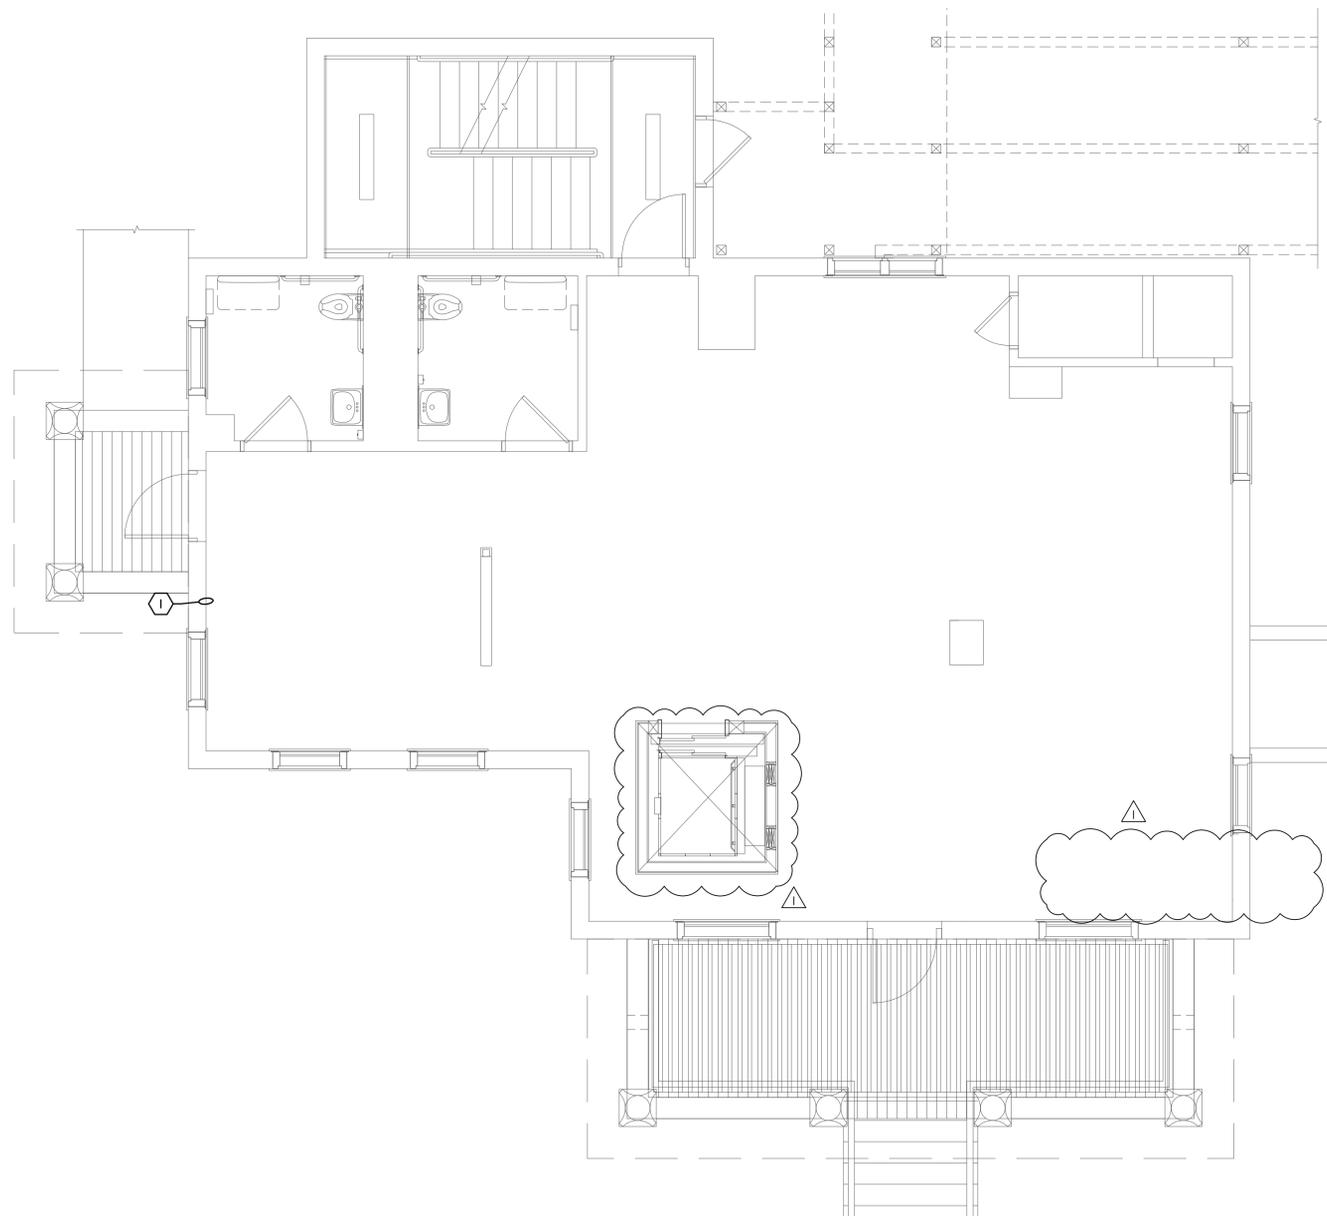

ELECTRICAL POWER PLAN - 1ST LEVEL

SCALE: 1/4" = 1'-0"

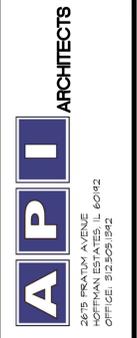

HOFFMAN ESTATES PARK DISTRICT - VOGELI HOUSE REMODEL
 650 WEST HIGGINS ROAD
 HOFFMAN ESTATES, IL 60169

project no.	D2100051
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**ELEC. POWER PLAN
1ST LEVEL**

sheet number:
E1.2


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FIRE ALARM NOTES

1. PROVIDE ALL ALARM DEVICES, NOTIFICATION DEVICES, PANELS, ETC. REQUIRED BY LOCAL CODES. PROVIDE NETWORK/TERMINATION PANELS AS REQUIRED.
2. PROVIDE COMPLETE FIRE ALARM PERMIT AND CONSTRUCTION DOCUMENTS. SUBMIT DOCUMENTS TO PERMITTING AUTHORITY AND RE-SUBMIT BASED ON COMMENTS. OBTAIN AGENCY APPROVAL PRIOR TO INSTALLATION.
3. PROVIDE HORN/STROBE DEVICES AS REQUIRED BY LOCAL FIRE OFFICIALS AND WIRE TO FIRE ALARM CONTROL PANEL. DEVICE LAYOUT IS REPRESENTATIVE ONLY. PROVIDE ACTUAL QUANTITY OF DEVICES PER IFC AND PER LOCAL AUTHORITY HAVING JURISDICTION REQUIREMENTS.
4. PROVIDE BATTERY AND VOLTAGE DROP CALCULATIONS.
5. CONTRACTOR SHALL REUSE/RELOCATE EXISTING FIRE ALARM DEVICES AND PROVIDE NEW WHERE REQUIRED.

DEMOLITION LEGEND

- E - EXISTING TO REMAIN
- X - EXISTING TO BE REMOVED
- XR - EXISTING TO BE RELOCATED
- XRN - EXISTING, RELOCATED TO NEW LOCATION
- XN - EXISTING DEVICE REPLACED WITH NEW
- XNA - EXISTING DEVICE REWIRED WITH NEW CIRCUIT
- XN/A - EXISTING DEVICE REPLACED WITH NEW, REWIRED TO NEW CIRCUIT

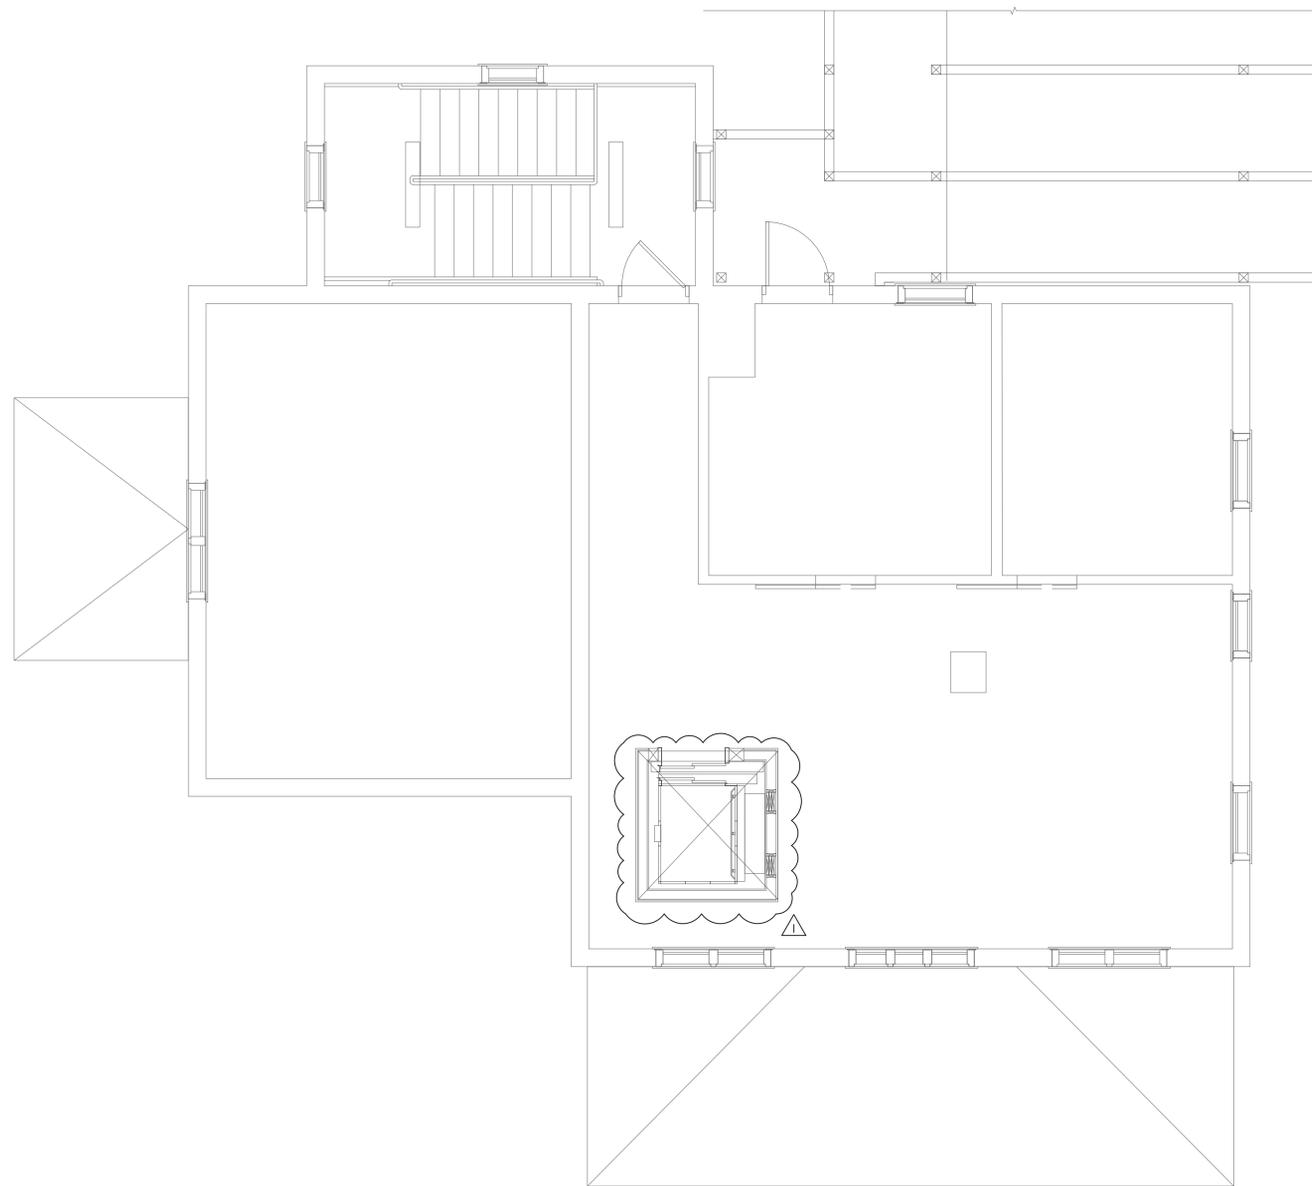

ELECTRICAL POWER PLAN - 2ND LEVEL

SCALE: 1/4" = 1'-0"



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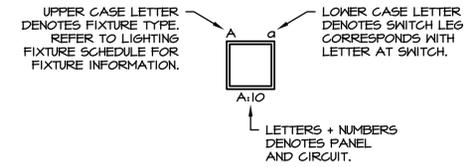
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ELEC. POWER PLAN
2ND LEVEL

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E13

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LIGHTING LEGEND



DEMOLITION LEGEND

- E - EXISTING TO REMAIN
- X - EXISTING TO BE REMOVED
- XR - EXISTING TO BE RELOCATED
- XRN - EXISTING, RELOCATED TO NEW LOCATION
- XN - EXISTING DEVICE REPLACED WITH NEW
- XX - EXISTING DEVICE REWIRED WITH NEW CIRCUIT
- XXN - EXISTING DEVICE REPLACED WITH NEW, REWIRED TO NEW CIRCUIT


GENERAL NOTES

1. EXISTING LOCAL LIGHTING CIRCUITS TO REMAIN SHALL BE RECONNECTED TO NEW LIGHTING FIXTURES AND CONTROLS.
2. NEW EMERGENCY LIGHTS AND EXIT SIGNS SHALL BE CONNECTED TO LOCAL LIGHTING CIRCUIT AHEAD OF ANY SWITCHING.
3. LIGHTING CONTROLS SHALL BE DUAL TECHNOLOGY TYPE.



KEYED NOTES

1. ELEVATOR SHAFT LIGHT; PROVIDE TWO (2) LEVITON #000-09850-LED FIXTURES, ONE (1) AT BOTTOM OF SHAFT AND ONE (1) AT TOP OF SHAFT.
2. PROVIDE ONE (1) NEW LEVITON #000-09850-LED LIGHTING FIXTURE WITHIN ELEVATOR MACHINE ROOM.
3. NEW LIGHTING FIXTURE SHALL BE CONNECTED TO EXISTING LOCAL LIGHTING CIRCUIT AND CONTROLS.

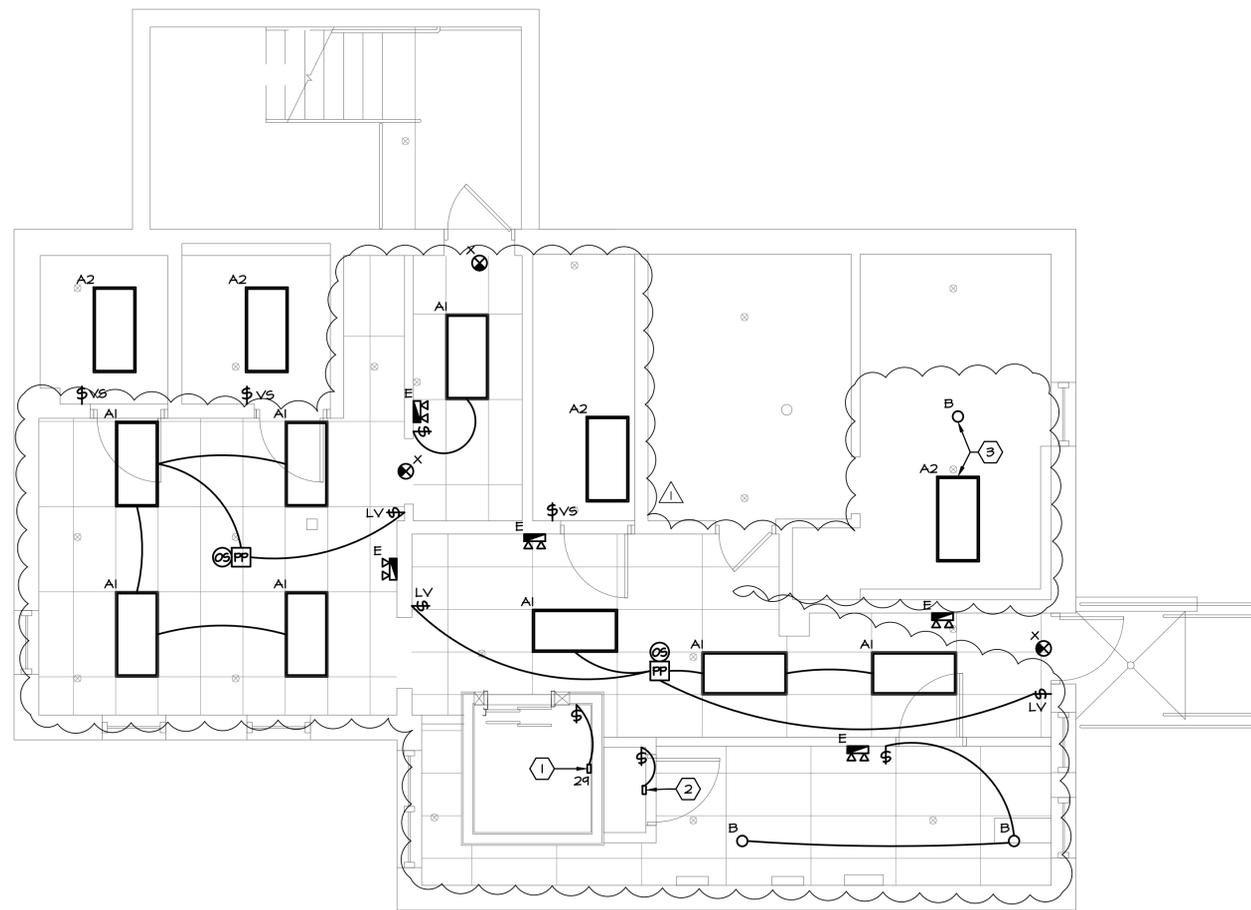

ELECTRICAL LIGHTING PLAN - BASMENT


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LIGHTING LEGEND




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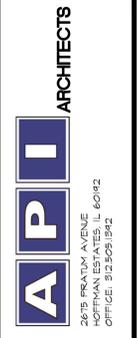
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- XN - EXISTING DEVICE REPLACED WITH NEW
- XX - EXISTING DEVICE REWIRED WITH NEW CIRCUIT
- XXN - EXISTING DEVICE REPLACED WITH NEW, REWIRED TO NEW CIRCUIT

GENERAL NOTES

1. EXISTING LOCAL LIGHTING CIRCUITS TO REMAIN SHALL BE RECONNECTED TO NEW LIGHTING FIXTURES AND CONTROLS.
2. NEW EMERGENCY LIGHTS AND EXIT SIGNS SHALL BE CONNECTED TO LOCAL LIGHTING CIRCUIT AHEAD OF ANY SWITCHING.
3. LIGHTING CONTROLS SHALL BE DUAL TECHNOLOGY TYPE.

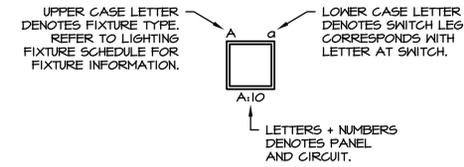

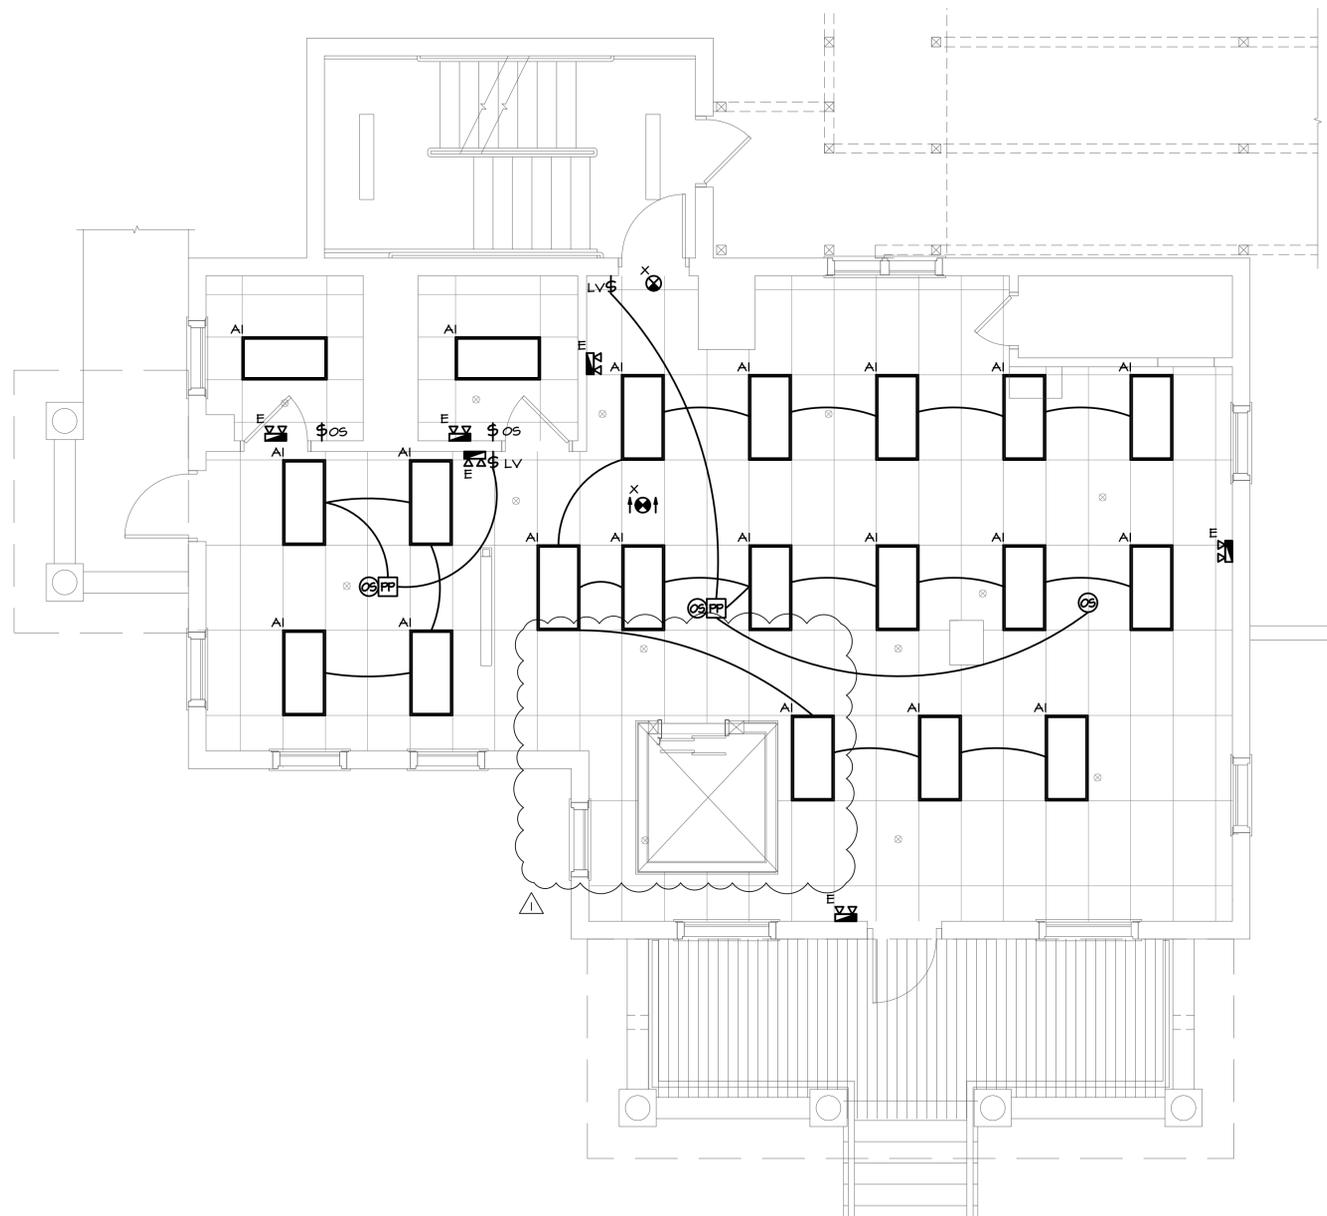ELECTRICAL LIGHTING PLAN - 1ST LEVEL
SCALE: 1/4" = 1'-0"




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ELEC. LTG. PLAN
1ST LEVEL
sheet number:
E2.2

LIGHTING LEGEND



DEMOLITION LEGEND


- E - EXISTING TO REMAIN
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- XR - EXISTING TO BE RELOCATED
- XRN - EXISTING, RELOCATED TO NEW LOCATION
- XN - EXISTING DEVICE REPLACED WITH NEW
- XX - EXISTING DEVICE REWIRED WITH NEW CIRCUIT
- XXN - EXISTING DEVICE REPLACED WITH NEW, REWIRED TO NEW CIRCUIT

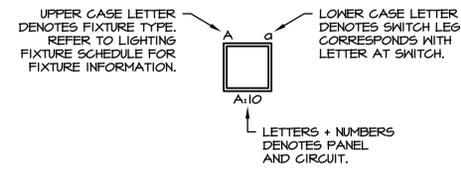GENERAL NOTES

1. EXISTING LOCAL LIGHTING CIRCUITS TO REMAIN SHALL BE RECONNECTED TO NEW LIGHTING FIXTURES AND CONTROLS.
2. NEW EMERGENCY LIGHTS AND EXIT SIGNS SHALL BE CONNECTED TO LOCAL LIGHTING CIRCUIT AHEAD OF ANY SWITCHING.
3. LIGHTING CONTROLS SHALL BE DUAL TECHNOLOGY TYPE.


KEYED NOTES

1. EXTERIOR LIGHTING FIXTURE SHALL BE CONNECTED TO EXISTING ADJACENT LOCAL LIGHTING CIRCUIT AHEAD OF ANY SWITCHING.

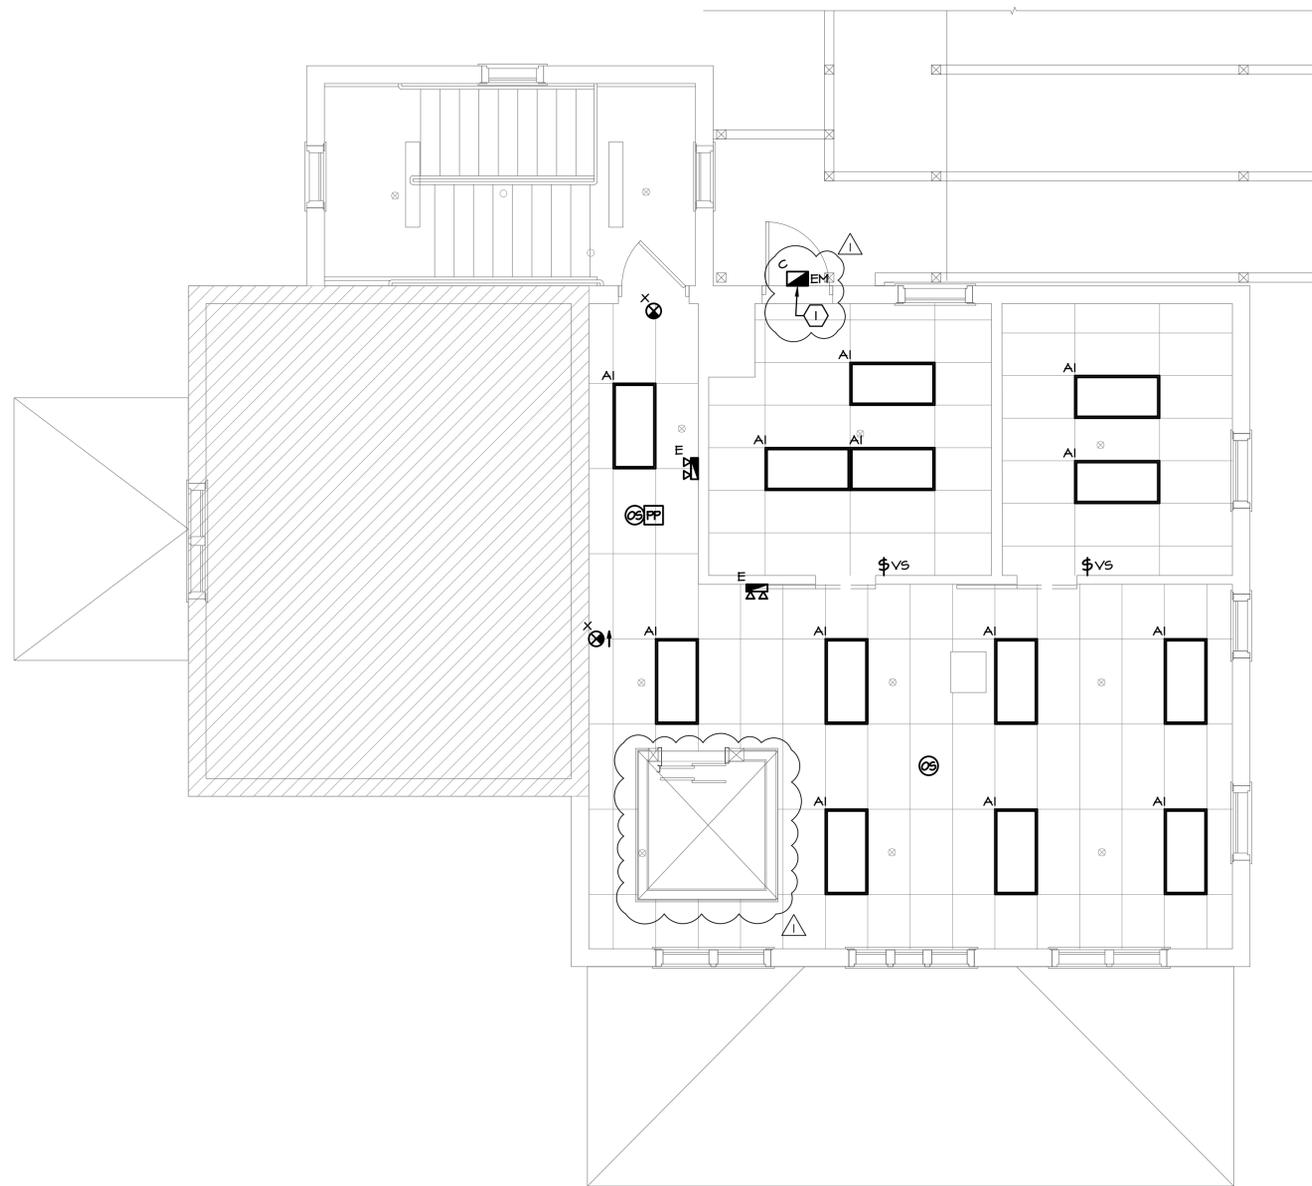

ELECTRICAL LIGHTING PLAN - 2ND LEVEL

SCALE: 1/4" = 1'-0"

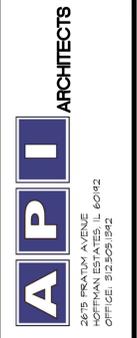

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 650 WEST HIGGINS ROAD
 HOFFMAN ESTATES, IL 60169

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**ELEC. LTG. PLAN
2ND LEVEL**

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LIGHTING FIXTURE SCHEDULE					
TYPE	DESCRIPTION & FEATURES	LAMPS	MOUNTING	VOLT	SPECIFIED MANUFACTURER AND CATALOG NUMBER
		QUANTITY/TYPE	CLG./POLE-TYPE		
A1	2X4 TROFFER	32W LED	RECESSED/CEILING	120	LITHONIA #2BLT4 40L ADP EZI LP835
A2	2X4 TROFFER W/ DRYWALL GRID ADAPTER	32W LED	RECESSED/CEILING	120	LITHONIA #2BLT4 40L ADP EZI LP835 W #D6A24
B	6" DOWNLIGHT	30W LED	RECESSED/CEILING	120	GOTHAM #EVO6 35/30 AR MD L55 MVOLT
C	EXTERIOR WALL SCONCE W/ INTEGRAL PHOTOCELL AND EM BATTERY BACK-UP	30W LED	SURFACE/WALL	120	LITHONIA #ARC2 LED P4 40K MVOLT E82HC PE DDBXD
E	EMERGENCY LIGHT WITH BATTERY BACK-UP	LED	HIGH WALL	120	LITHONIA #ELM2L
X	EMERGENCY EXIT SIGN WITH BATTERY BACK-UP	LED	HIGH WALL	120	LITHONIA #LQM 5 W 3 R MVOLT EL N


NOTES:

- VERIFY TYPE OF CEILING OR WALL FOR ALL RECESSED LIGHTING FIXTURES PRIOR TO ORDERING.
- ALL BALLAST(S), INCLUDING BALLASTS FOR PL LAMPS, SHALL BE OF THE ELECTRONIC TYPE. UL APPROVED WITH MAXIMUM 10% THD AND CLASS "P" THERMAL PROTECTION AND CLASS "A" SOUND RATING.
- PROVIDE ALL ADDITIONAL HARDWARE FOR FIXTURE MOUNTING AS REQUIRED AT NO EXTRA COST.
- ALL WIRE WITHIN (3) THREE INCHES OF BALLASTS SHALL BE RATED A MINIMUM OF 90°C.
- MINIMUM LENS THICKNESS TO BE .125 INCHES, WHERE LENSES ARE USED.
- THE FIXTURE SCHEDULE DOES NOT NECESSARILY LIST ALL ACCESSORIES AND HARDWARE NECESSARY FOR THE COMPLETION OF INSTALLATION, NOR DOES IT DETAIL THE CEILING CONSTRUCTION TO BE ENCOUNTERED. IT IS THE CONTRACTOR'S RESPONSIBILITY TO PROPERLY DETERMINE AND PROVIDE CORRECT COMPONENTS, ACCESSORIES, AND HARDWARE AS REQUIRED FOR THE INSTALLATION.
- CONTRACTOR SHALL COORDINATE WITH ARCHITECTURAL DRAWINGS AND CEILING CONTRACTOR FOR EXACT LIGHTING FIXTURE LOCATION.
- ALL LAMPS SHALL BE 3500K, UNLESS OTHERWISE INDICATED.
- ALL BATTERY BACK-UP EMERGENCY LIGHT AND EXIT SIGN LIGHTING FIXTURES INDICATED SHALL HAVE BATTERY BACK-UP RATED FOR 1-1/2 HOURS MINIMUM AND AS APPROVED BY LOCAL FIRE PREVENTION BUREAU.
- ALL INDOOR LUMINAIRES OTHER THAN DWELLINGS WITH DOUBLE-ENDED LAMPS AND CONTAIN BALLAST(S) THAT ARE SUPPLIED FROM MULTI-WIRE BRANCH CIRCUITS SHALL HAVE A DISCONNECTING MEANS EITHER INTERNAL OR EXTERNAL TO EACH LUMINAIRE, NEC. 410.73 (6)
- EMERGENCY LIGHTING TO BE CONNECTED TO LOCAL LIGHTING CIRCUIT AHEAD OF ANY SWITCHING.


PANEL		EXISTING PANEL 'I-LP-I'		VOLTS		120/208V		PHASE		3PH/4W	
AMPS		100A		MAIN		100A/3P MCB		A.I.C.		10,000	
LOCATION		BASEMENT ELECTRICAL ROOM				MOUNTING		SURFACE			
CIRCUIT	POLE	TRIP	DESCRIPTION	KVA	DESCRIPTION	TRIP	POLE	CIRCUIT			
1	1	20	SUMP PUMP		BASEMENT LIGHTING	20	1	2			
3	1	20	SEWAGE EJECTOR		BASEMENT LIGHTING	20	1	4			
5	1	20	DRY-PUMP COMPRESSOR		STAIRWELL LIGHTING	20	1	6			
7	2	60	AC UNIT		1ST FLOOR LIGHTING	20	1	8			
9					1ST FLOOR LIGHTING	20	1	10			
11	1	20	FRONT SIGNAL TIMER		1ST FLOOR BATH LIGHTING	20	1	12			
13	1	20	2ND FLOOR LIGHTING		1ST FLOOR RECEPT.	20	1	14			
15	1	20	2ND FLOOR LIGHTING		1ST FLOOR RECEPT.	20	1	16			
17	1	20	SPARE		1ST FLOOR RECEPT.	20	1	18			
19	1	20	2ND FLOOR RECEPT.		BATHROOM RECEPT.	20	1	20			
21	1	20	2ND FLOOR RECEPT.		1ST FLOOR OFFICE RECEPT.	20	1	22			
23	1	20	BASEMENT OFFICE	0.36	LAUNDRY RECEPT.	20	1	24			
25	1	20	2ND FLOOR RECEPT.		EXTERIOR RECEPTACLE	20	1	26			
27	1	20	2ND FLOOR RECEPT.		FIRE ALARM CONTROL PANEL	20	1	28			
29	1	20	ELEVATOR LIGHTS / RECEPTACLE	0.20	WATER HEATER/ RECIRC PUMP	20	1	30			
31	1	20	HEATER 1ST FLOOR	0.50	FURNACE F-I*	20	1	32*			
33	1	20	HEATER 2ND FLOOR	5.45	CONDENSING UNIT 'CU-I'	40	2	34*			
35								36			
37	2	30	DRYER		SECURITY	20	1	38			
39	1	20	BASEMENT KITCHEN RECEPTACLES	1.50	BATTERY PACKS	20	1	40			
41	1	20	BASEMENT KITCHEN REFRIGERATOR	1.00	BACK BASEMENT LIGHTING	20	1	42			

NOTES:

- ALL C/B'S SERVING HVAC EQUIPMENT SHALL BE HACR RATED.
 - ALL C/B'S SERVING EMAL LIGHTING SHALL HAVE LOCK-ON DEVICE.
 - ALL C/B'S USED FOR SWITCHING OF LIGHTS SHALL BE SWITCH DUTY RATED.
 - PER NEC 210.4 (B) MULTI-WIRE CIRCUITS (NETWORKS) SHARING THE SAME NEUTRAL SHALL SIMULTANEOUSLY DISCONNECT ALL UNGROUNDED CONDUCTORS AT THE POINT WHERE THE BRANCH CIRCUIT ORIGINATES, FOR SINGLE PHASE INSTALLATION, THE SIMULTANEOUS DISCONNECTION CAN BE ACHIEVED BY TWO SINGLE-POLE CIRCUIT BREAKERS WITH AN IDENTIFIED HANDLE TIE OR BY A 2-POLE CIRCUIT BREAKER. FOR A 3-PHASE INSTALLATION, A 3-POLE CIRCUIT BREAKER OR THREE SINGLE-POLE CIRCUIT BREAKERS WITH AN IDENTIFIED HANDLE TIE PROVIDES THE REQUIRED SIMULTANEOUS DISCONNECTION OF THE UNGROUNDED CONDUCTORS.
 - TAMPER RESISTANT RECEPTACLES SHALL BE PROVIDED PER NEC 406.12
- * DENOTES NEW CIRCUIT BREAKER.

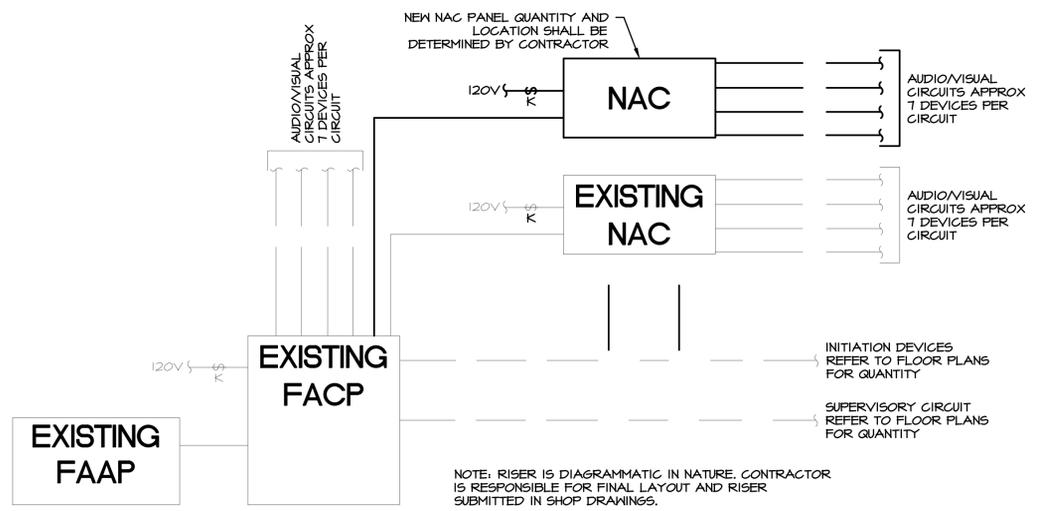

FIRE ALARM RISER DIAGRAM
SCALE: NONE

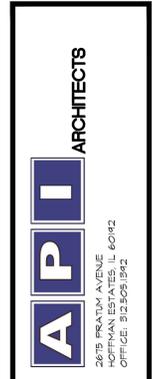

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sheet title: ELEC. SCHEDULES AND DETAILS

sheet number: E3.1

FIRE ALARM SYMBOLS

	ADDRESSABLE FIRE ALARM CONTROL PANEL WITH REMOTE 24 HOUR TELEPHONE MONITORING
	FIRE ALARM ANNUNCIATOR PANEL
	FIRE ALARM SYSTEM DUAL ACTION PULL STATION (48" AFF, MOUNT WITHIN 5 FT. OF DOOR)
	FIRE ALARM SYSTEM HORN & STROBE LIGHT (AUDIO-VISUAL ALARM, 48" AFF, CANDELA RATING BY OTHERS)
	VISUAL STROBE LIGHT (48" AFF, CANDELA RATING BY OTHERS)
	FIRE ALARM SYSTEM HORN & STROBE LIGHT (AUDIO-VISUAL ALARM, CEILING, CANDELA RATING BY OTHERS)
	VISUAL STROBE LIGHT (CEILING, CANDELA RATING BY OTHERS)
	SMOKE DETECTOR, MINIMUM 9FT. FROM SUPPLY VENT
	HEAT DETECTOR, 135° DEGREE FIXED TEMP/RATE OF RISE
	HVAC DUCT TYPE SMOKE DETECTOR
	REMOTE INDICATING LIGHT WITH KEY-OPERATED TEST SWITCH, VERIFY LOCATION OF LIGHT AND KEY SWITCH WITH INSPECTOR.
	FAN SHUT DOWN RELAY
	KNOX BOX (WEATHER PROOF)
	NOTIFICATION APPLIANCE CIRCUIT EXPANSION PANEL

NOTE: MINIMUM WIRE TWO CONDUCTOR INSULATED #14 AWG, TWISTED PAIR, PROVIDE BACKBOXES WITH MINIMUM 1/2" CONDUIT STUBBED INTO ACCESSIBLE CEILING SPACE FOR EACH DEVICE. PROVIDE CONDUIT IN NON-ACCESSIBLE CEILING SPACES. FIRE ALARM CABLE SHALL BE ROUTED FREE-AIR UNLESS A FULL CONDUIT SYSTEM IS REQUIRED BY THE LOCAL AUTHORITY HAVING JURISDICTION.

DEVICE LAYOUT IS REPRESENTATIVE ONLY. PROVIDE ACTUAL QUANTITY OF DEVICES PER NFPA 72, NFPA 101, IBC, NEC, IFC, AND PER LOCAL AUTHORITY HAVING JURISDICTION REQUIREMENTS. ELECTRICAL CONTRACTOR SHALL VERIFY EXACT QUANTITY OF FIRE ALARM DEVICES PRIOR TO BIDDING.

ELECTRICAL CONTRACTOR IS RESPONSIBLE FOR THE FIRE ALARM PERMIT AND CONSTRUCTION DOCUMENTS. SUBMIT SHOP DRAWINGS TO ENGINEER AND PERMITTING AUTHORITY FOR REVIEW PRIOR TO INSTALLATION AND RESUBMIT BASED ON COMMENTS, AS REQUIRED. PROVIDE BATTERY AND VOLTAGE DROP CALCULATIONS.

NEW FIRE ALARM DEVICES WIRED TO EXISTING FAFCP SHALL BE CONVENTIONAL (DUCT SMOKE DETECTORS, PULL STATIONS, HORNS, VISUALS, FLOW SWITCHES, TAMPER SWITCHES, AND BELLS). VERIFY AND COORDINATE IN FIELD.

ELECTRICAL SYMBOLS

	LIGHT FIXTURE. CAPITAL LETTER DENOTES FIXTURE TYPE, NUMERAL INDICATES CIRCUIT ASSIGNMENT, AND SUBSCRIPT LETTER DENOTES SWITCH LEG. SHADING OF ANY FIXTURE, AS SHOWN, INDICATES FIXTURE SHALL BE CIRCUITED TO EMERGENCY / UNSWITCHED NIGHT LIGHT CIRCUIT. SEE "LIGHTING FIXTURE SCHEDULE" FOR ADDITIONAL INFORMATION.
	EXIT SIGN UNIVERSAL MOUNT SHADED AREA INDICATES FACE, ARROWS AS REQUIRED. SEE "LIGHTING FIXTURE SCHEDULE."
	SELF-CONTAINED EMERGENCY LIGHTING FIXTURE, WITH BATTERY BACK-UP AND SOLID STATE CHARGER
	SINGLE POLE TOGGLE SWITCH, 48" AFF, SUBSCRIPT LETTER DENOTES SWITCH LEG, 20 AMP, 120 VOLT
	THREE WAY TOGGLE SWITCH, 48" AFF, 20AMP, 120 VOLT
	FOUR WAY TOGGLE SWITCH, 48" AFF, 20AMP, 120 VOLT
	MANUAL SINGLE PHASE MOTOR STARTER WITH THERMAL OVERLOAD PROTECTION. 48" AFF UNLESS INDICATED OTHERWISE
	DIMMER SWITCH, 48" AFF
	FAN SPEED SWITCH, 48" AFF
	HALL MOUNTED VACANCY SENSOR SWITCH "MANUAL ON / AUTO OFF" 48" AFF
	HALL MOUNTED OCCUPANCY SENSOR SWITCH "AUTO ON / AUTO OFF" 48" AFF
	LOW VOLTAGE MOMENTARY CONTACT SWITCH, 48" AFF
	LOW VOLTAGE MOMENTARY CONTACT DIMMER SWITCH, 48" AFF
	SWITCH FURNISHED WITH PILOT LIGHT.
	KEY LOCK SWITCH, 48" AFF
	NON-FUSED DISCONNECT SWITCH (NFDS) RATED AS INDICATED
	FUSED DISCONNECT SWITCH (FDS) WITH SWITCH AND FUSE RATED AS INDICATED.
	3-PHASE COMBINATION MAGNETIC STARTER WITH NEMA SIZE INDICATED BY E.C.
	DUPLEX RECEPTACLE, NEMA 5-20R, 15'A.F.F.
	ISOLATED GROUND RECEPTACLE, NEMA 5-20R, 15'A.F.F.
	RECEPTACLE CROSS LINE DENOTES 6" ABOVE COUNTER OR BACKSPASH
	RECEPTACLE SHADING DENOTES GROUND FAULT CIRCUIT INTERRUPTER "GFCI", NEMA 5-20R
	DOUBLE DUPLEX (QUAD) RECEPTACLE
	RECEPTACLE SHADING DENOTES SWITCHED OUTLET
	DUPLEX RECEPTACLE WITH TWO (2) USB PORTS
	CEILING-MOUNTED RECEPTACLE
	SPECIAL PURPOSE RECEPTACLE NEMA CONFIGURATION AS REQUIRED BY MANUFACTURERS EQUIPMENT. VERIFY CONDUIT, CONDUCTOR AND DISCONNECT/CIRCUIT BREAKER REQUIREMENTS PRIOR TO ROUGH-IN
	LIGHTING AND/OR POWER PANEL
	DISTRIBUTION PANEL
	MOTOR
	PHOTO ELECTRIC CONTROL, ROOF MOUNTED, 120V OPERATION, 20A RATED
	CONDUIT ROUTED CONCEALED IN CEILING OR WALL CONSTRUCTION. (CROSS LINES DENOTE NUMBER OF WIRES.)
	CONDUIT ROUTED EXPOSED, PARALLEL OR PERPENDICULAR TO WALLS.
	CONDUIT ROUTED CONCEALED IN CONCRETE FLOOR SLAB OR UNDERGROUND.
	AUXILIARY JUNCTION BOX
	FLEXIBLE CONDUIT CONNECTION
	HOME RUN TO PANELBOARD
	CONDUIT
	PHASE CONDUCTORS
	NEUTRAL CONDUCTOR
	EQUIPMENT GROUND
	ISOLATED GROUND
	TELEPHONE OUTLET, WITH 3/4" CONDUIT STUB ABOVE ACCESSIBLE CEILING.
	DATA SYSTEM OUTLET WITH 3/4" CONDUIT STUB ABOVE ACCESSIBLE CEILING.
	DATA AND TELEPHONE OUTLET, WITH 3/4" CONDUIT STUB ABOVE ACCESSIBLE CEILING.
	TV OUTLET, WITH 3/4" CONDUIT STUB ABOVE ACCESSIBLE CEILING.
	CEILING MOUNTED OCCUPANCY SENSOR "AUTO ON / AUTO OFF"
	CEILING MOUNTED VACANCY SENSOR "MANUAL ON / AUTO OFF"
	CEILING MOUNTED DAYLIGHT SENSOR
	LIGHTING POWER PACK
	POWER POLE
	FLOOR BOX OR POKE-THRU DEVICE

ELECTRICAL SPECIFICATIONS

THE GENERAL CONDITIONS AND SUPPLEMENTAL GENERAL CONDITIONS BY THE ARCHITECT SHALL GOVERN WHERE APPLICABLE.

THIS CONTRACTOR SHALL THOROUGHLY FAMILIARIZE HIMSELF WITH THE PLANS AND SHALL VERIFY EXISTING SITE CONDITIONS AT THE JOB SITE BEFORE SUBMITTING BID. FAILURE TO RECOGNIZE WORK REQUIRED SHALL BE AT THE EXPENSE OF THIS CONTRACTOR. NO CONSIDERATION SHALL BE GIVEN FOR ADDITIONAL COMPENSATION AFTER THE LETTING OF BIDS.

ENTIRE INSTALLATION SHALL BE PERFORMED IN A FIRST-CLASS WORKMANLIKE MANNER AND SHALL CONFORM TO ALL APPLICABLE CODES AND ORDINANCES. THE COMPLETED SYSTEMS SHALL BE FULLY OPERATIONAL; ACCEPTANCE BY THE OWNER SHALL BE A CONDITION OF THE CONTRACT. ALL WORK SHALL BE COORDINATED WITH OTHER TRADES IN ORDER TO AVOID INTERFERENCES, PRESERVE MAXIMUM HEADROOM, AND AVOID OMISSIONS. ALL MATERIALS, WORKMANSHIP AND EQUIPMENT SHALL BE GUARANTEED FOR ONE (1) YEAR AFTER SYSTEM ACCEPTANCE.

RECEPTACLES AND SWITCHES SHALL BE THE TYPE AS SHOWN ON THE DRAWINGS AND SHALL BE SPECIFICATION GRADE.

MINIMUM BRANCH WIRE SIZE SHALL BE #12 AWG COPPER EXCEPT FOR CONTROL AND SIGNAL CIRCUITS. INSULATION (INTERIOR) SHALL BE SOLID TYPE THIN OR THIN SIZES #10, SIZES #8 THROUGH #10 THROUGH 150 KCMIL SHALL BE STRANDED TYPE THIN OR THIN AT THE CONTRACTOR'S OPTION.

MINIMUM OUTLET BOXES SHALL BE 4" SQUARE, UNLESS OTHERWISE SPECIFIED.

CONTRACTOR SHALL NOT SCALE DRAWINGS FOR DIMENSIONS BUT SHALL CONTACT THE PROJECT ARCHITECT FOR ALL DIMENSIONAL DATA AND SHALL VERIFY EXACT LOCATION AND MOUNTING HEIGHTS OF ALL OUTLETS WITH ARCHITECT AND/OR OWNER PRIOR TO INSTALLATION.

GROUNDING AND BONDING SHALL COMPLY WITH REQUIREMENTS OF ALL APPLICABLE CODES.

ALL MATERIALS USED SHALL BE NEW AND BEAR THE UL LABEL AND BE OF THE APPROPRIATE NEMA STANDARD.

THIS CONTRACTOR SHALL ALLOW IN HIS INITIAL BID THE COST OF SERVICES ON ALL EQUIPMENT INSTALLED UNDER HIS CONTRACT FOR A PERIOD OF ONE (1) YEAR FROM DATE OF FINAL ACCEPTANCE OF THE WORK.

LAYOUT IS DIAGRAMMATIC AND WORK SHALL BE INSTALLED TO MEET FIELD CONDITIONS AND EQUIPMENT SELECTED. PROVIDE SHOP DRAWINGS AS REQUIRED AND VERIFY ALL EQUIPMENT.

PANELBOARDS SHALL BE DEAD FRONT WITH BOLT-ON TYPE CIRCUIT BREAKERS AND COPPER BUS. PROVIDE A TYPED LEGEND, UNDER A CLEAR FLEXIGLASS COVER FOR CIRCUIT IDENTIFICATION.

CONTRACTOR SHALL INCLUDE ALL MISCELLANEOUS ITEMS REQUIRED TO COMPLETE THE WORK.

CONTRACTOR SHALL OBTAIN AND PAY FOR ALL PERMITS AND REQUIRED INSPECTION FEES.

IT SHALL BE THE RESPONSIBILITY OF THIS CONTRACTOR TO COORDINATE AND REVIEW THE ELECTRICAL CHARACTERISTICS, AMPACITY AND OTHER REQUIREMENTS OF ALL EQUIPMENT PRIOR TO INSTALLATION.

IT SHALL BE THE RESPONSIBILITY OF THIS CONTRACTOR TO COORDINATE THE LOCATIONS OF CONDUIT ROUTING, EQUIPMENT, LIGHTING, ETC. WITH ALL OTHER TRADES IN THE FIELD PRIOR TO INSTALLATION.

THE ENTIRE INSTALLATION OF ALL COMPONENTS OF THIS PROJECT SHALL COMPLY WITH ALL FEDERAL ADA REQUIREMENTS. VERIFY EXACT LOCATIONS AND HEIGHTS OF ALL FIXTURES AND OUTLETS BEFORE INSTALLATION TO INSURE COMPLIANCE WITH FEDERAL REGULATIONS.

FOR CLARITY OF ALL PLANS, SOME CONDUIT AND WIRE HAS NOT BEEN SHOWN. IT IS THE RESPONSIBILITY OF THIS CONTRACTOR TO FURNISH AND INSTALL COMPLETE AND OPERATING SYSTEMS INCLUDING ALL CONDUIT AND WIRING.

THIS CONTRACTOR SHALL MAINTAIN THE FIRE RATED INTEGRITY OF ALL FLOORS, CEILINGS AND WALLS. ALL PENETRATIONS THROUGH FIRE RATED BUILDING ELEMENTS SHALL BE EFFECTIVELY SEALED USING APPROVED MATERIALS AND METHODS. ALL LIGHTING FIXTURES MOUNTED IN FIRE RATED CEILINGS SHALL MAINTAIN THE INTEGRITY OF THE FIRE RATED CEILINGS USING APPROVED MATERIALS AND METHODS. REFER TO ARCHITECTURAL DRAWINGS FOR FIRE RATINGS.

THIS CONTRACTOR SHALL INSPECT THE COMPLETE SET OF DRAWINGS AND SPECIFICATIONS TO DETERMINE HIS ENTIRE SCOPE OF WORK. THIS CONTRACTOR SHALL VISIT THE SITE AND BECOME FAMILIAR WITH THE EXISTING CONDITIONS AND EXTENT OF DEMOLITION AND NEW WORK FOR THIS PROJECT PRIOR TO SUBMITTING HIS BID.

THE ELECTRICAL INSTALLATION IS TO BE IN STRICT ACCORDANCE WITH THE APPLICABLE RULES AND REGULATIONS OF ALL LOCAL, STATE AND FEDERAL ELECTRICAL CODES AND THE LOCAL UTILITY COMPANY REQUIREMENTS OR ANY OTHER AUTHORITIES HAVING LAWFUL JURISDICTION.

ALL SITE UNDERGROUND BRANCH CIRCUIT WIRING IN CONDUIT SHALL BE TYPE THIN OR THIN.

ALL UNDERFLOOR OR EXPOSED TO THE WEATHER CONDUIT SHALL BE HEAVY-WALL, GALVANIZED RIGID STEEL "R6S", INTERMEDIATE METAL CONDUIT "IMC", OR RIGID PVC SCHEDULE #40 CONDUIT, WHERE ALLOWED, MINIMUM SIZE 3/4".

PROVIDE BARRIERS TO SEPARATE DIFFERENT PHASES IN 277VOLT GANGED SWITCH BOXES.

ALL WIRE SHALL BE INSTALLED IN THINWALL, ELECTRICAL METALLIC TUBING (EMT) CONDUIT UNLESS OTHERWISE NOTED. MINIMUM SIZE SHALL BE 3/4" FOR BRANCH CIRCUIT WIRING, DROPS TO SWITCHES AND BRANCH DEVICES MAY BE 1/2" UNLESS OTHERWISE NOTED ON DRAWINGS. ALL THINWALL FITTINGS SHALL BE OF THE STEEL COMPRESSION GLAND TYPE PER ALL APPLICABLE CODE REQUIREMENTS. ALL CONDUITS SHALL BE CONCEALED WHERE POSSIBLE. WHERE EXPOSED, THIS CONTRACTOR SHALL RUN CONDUITS IN STRAIGHT LINES PARALLEL AND/OR PERPENDICULAR TO THE BUILDING CONSTRUCTION. CONDUITS INSTALLED IN AREAS SUBJECT TO MECHANICAL DAMAGE SHALL BE RIGID GALVANIZED, OR INTERMEDIATE METAL TYPE.

THIS CONTRACTOR SHALL PROVIDE ALL TEMPORARY WIRING FOR ALL TRADES FOR CONSTRUCTION EQUIPMENT (IE: HAND TOOLS, WELDERS, PIPE BENDERS, ETC.) AND CONSTRUCTION LIGHTING PER THE LATEST OSHA STANDARDS. INCLUDE ALL COSTS IN THE BASE BID. THIS CONTRACTOR SHALL ESTABLISH SAFE WORKING PROCEDURES FOR THE PROTECTION OF THE WORKMEN IN ALL PHASES OF WORK, COMPLYING WITH THE APPLICABLE PROVISIONS OF ALL CITY, STATE AND FEDERAL SAFETY LAWS (OSHA).

ABBREVIATIONS

A, AMP - AMPERES	WH - ELECTRIC WATER HEATER	N/A - NOT APPLICABLE
AFF - ABOVE FINISHED FLOOR	FDS - FUSED DISCONNECT SWITCH	NEC - NATIONAL ELECTRICAL CODE
AF6 - ABOVE FINISHED GRADE	FLA - FULL LOAD AMPS	NFDS - NON-FUSED DISCONNECT SWITCH
AL - ALUMINUM	FLEX - FLEXIBLE	NIC - NOT IN CONTRACT
ATS - AUTOMATIC TRANSFER SWITCH	GFCI - GROUND FAULT CIRCUIT INTERRUPTING	NO - NORMALLY OPEN
AWG - AMERICAN WIRE GAUGE	GRD, GND - GROUND	NTS - NOT TO SCALE
C - CONDUIT	HID - HIGH DENSITY DISCHARGE	OH - OVERHEAD
C/B - CIRCUIT BREAKER	HP - HORSE POWER	PNL - PANEL
CCTV - CLOSED CIRCUIT TELEVISION	IG - ISOLATED GROUND	QTY - QUANTITY
CKT - CIRCUIT	INC - INCANDESCENT	REF - REFERENCE, REFER
COND - CONDUCTOR	J-BOX, JB - JUNCTION BOX	R6S - RIGID GALVANIZED STEEL
CONN - CONNECTION	KCMIL - 1000 CIRCULAR MILS	SQ FT - SQUARE FOOT
CU - COPPER	KVA - KILOVOLT AMPS	SW - SWITCH
DISC - DISCONNECT	KW - KILOWATTS	TTB - TELEPHONE TERMINATION BOARD
DN - DOWN	LED - LIGHT EMITTING DIODE	TVSS - TRANSIENT VOLTAGE SURGE SUPPRESSION
DP - DISTRIBUTION PANEL	LTG - LIGHTING	TYP - TYPICAL
EA - EACH	LV - LOW VOLTAGE	UG - UNDERGROUND
ELEC - ELECTRICAL	MAX - MAXIMUM	UH - UNIT HEATER
ELEV - ELEVATOR	MCB - MAIN CIRCUIT BREAKER	V - VOLTAGE, VOLTS
EM, EMERG - EMERGENCY	MDP - MAIN DISTRIBUTION PANEL	VFD - VARIABLE FREQUENCY DRIVE
EMT - ELECTRICAL METALLIC TUBING	MFR - MANUFACTURER	WP - WEATHER PROOF
EOL - END OF LINE	MH - MOUNTING HEIGHT	WT - WEIGHT
EUH - ELECTRIC UNIT HEATER	MIN - MINIMUM	XFMR - TRANSFORMER
EWG - ELECTRIC WATER COOLER	MLO - MAIN LUGS ONLY	
EXH - ELECTRIC WALL HEATER	MTD - MOUNTED	



HOFFMAN ESTATES PARK DISTRICT - VOGELI HOUSE REMODEL
 650 WEST HIGGINS ROAD
 HOFFMAN ESTATES, IL 60169
 PROJECT NO. D2100051
 DATE: 07.21.2021
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