### **GENERAL NOTES**

- ALL CONTRACTORS AND SUBCONTRACTORS WILL THOROUGHLY FAMILIARIZE THEMSELVES WITH THESE CONSTRUCTION DOCUMENTS AND WILL VERIFY EXISTING SITE AND CONDITIONS PRIOR TO SUBMITTING A BID. ALL SUBCONTRACTORS WILL PROVIDE ALL LABOR. SUPERVISION, AND MATERIALS OF EVERY TYPE WHICH MAY BE NECESSARY FOR A SUCCESSFUL COMPLETION. ALL WORK TO BE PERFORMED IN A GOOD AND WORKMANLIKE MANNER ACCORDING TO THE TRUE INTENT AND MEANING OF THE DRAWINGS AND
- THIS ARCHITECT AND HIS PROFESSIONAL CONSULTANTS WILL NOT HAVE CONTROL. OF AND WILL NOT BE RESPONSIBLE FOR. CONSTRUCTION MEANS, METHODS, TECHNIQUES, SEQUENCES, PROCEDURES, OR SAFETY PRECAUTIONS AND PROGRAMS IN OR OMISSIONS OF THE CONTRACTOR, SUBCONTRACTOR, OR ANY OTHER PERSONS PERFORMING ANY OF THE WORK ON THIS SITE, NOR FOR THE FAILURE OF ANY OF THEM TO CARRY OUT THE WORK IN ACCORDANCE WITH THE INTENT OF THE CONTRACT AND OR CONSTRUCTION DOCUMENTS.
- ALL CONTRACTORS WILL PROVIDE ADEQUATE BRACING AND/OR SHORING TO INSURE STRUCTURAL STABILITY OF THE BUILDING AND ALL RELATED BUILDING COMPONENTS IE: STRUCTURAL WALLS, INTERIOR WALL ASSEMBLIES, ETC. DURING THE CONSTRUCTION PHASE OF THIS PROJECT.
- WORK WILL BE COORDINATED WITH ALL TRADES IN ORDER TO AVOID INTERFERENCE, AND AVOID OMISSIONS.
- ALL MATERIALS USED WILL BE NEW AND BEAR U.L. LABELS WHERE REQUIRED AND MEET APPROPRIATE N.E.M.A. STANDARDS.
- LAYOUT ALL PARTITIONS BEFORE BEGINNING CONSTRUCTION TO PREVENT ERRORS BY DISCREPANCY. ALL DRYWALL PARTITIONS WILL BE INSTALLED AS NOTED ON THE DRAWINGS.
- EACH SUBCONTRACTOR WILL AMEND AND MAKE GOOD AT HIS OWN COST, ANY DEFECTS OR OTHER FAULTS IN HIS WORKMANSHIP AND/OR
- ALL CONTRACTORS WILL GUARANTEE ALL LABOR AND MATERIALS FOR A PERIOD OF ONE YEAR FROM DATE OF OCCUPANCY.
- VERIFY ALL DIMENSIONS IN THE FIELD PRIOR TO ORDERING, CUTTING AND/OR INSTALLING MATERIAL, PRODUCT OR EQUIPMENT. IN THE EVENT OF ANY DISCREPANCIES, CONTACT THE CONSTRUCTION MANAGER OR OWNER BEFORE PROCEEDING WITH THAT WORK.
- ALL SUBCONTRACTORS WILL PROVIDE A CERTIFICATE OF INSURANCE TO THE GENERAL CONTRACTOR PRIOR TO STARTING ANY WORK ON THIS PROJECT. CERTIFICATE OF INSURANCE CANNOT BE TERMINATED OR CANCELED WITHOUT 10 DAYS PRIOR WRITTEN NOTICE TO THE
- ANY ADDITIONS OR CHANGES TO WORK MUST BE AUTHORIZED IN WRITING BY THE OWNER. NO ALTERATIONS WILL BE MADE ON THIS PROJECT EXCEPT UPON WRITTEN ORDER BY THE OWNER.
- NO SUBSTITUTIONS OF ANY KIND FOR MATERIALS SPECIFIED ON THESE CONSTRUCTION DOCUMENTS IS ALLOWED. NO "EQUIVALENT" SUBSTITUTIONS WILL BE MADE, UNLESS DUE TO THE LACK OF AVAILABILITY OF THE ORIGINAL MATERIAL SPECIFIED AND APPROVED IN WRITING BY OWNER.
- WEATHER CONDITIONS: CONTRACTORS WILL PROTECT ALL PARTS OF THEIR WORK FROM WEATHER DAMAGE DUE TO FROST, RAIN, HEAT, ETC. AND WILL MAKE GOOD TO THE SATISFACTION OF THE CONSTRUCTION MANAGER AND/OR GENERAL CONTRACTOR ANY PORTION OF THE WORK WHICH MAY HAVE BECOME DAMAGED.
- 14. RESPONSIBILITY OF CONTRACTOR: EACH SUBCONTRACTOR IS RESPONSIBLE FOR WORKMANSHIP AND MATERIALS, EACH SUBCONTRACTOR IS RESPONSIBLE FOR THE CARE AND PROTECTION OF HIS OWN WORK AND MATERIALS.
- 15. SITE SAFETY: EACH CONTRACTOR WILL ABIDE BY LOCAL AREA STANDARDS AND RELATED OSHA STANDARDS FOR THE PROTECTION AND SAFETY FOR THEIR EMPLOYEES ON SITE. THIS ARCHITECT AND HIS PROFESSIONAL CONSULTANTS WILL BE HELD HARMLESS BY THE OWNER, GENERAL CONTRACTOR AND RELATED AWARDED TRADES ON THIS PROJECT FOR ACCIDENTS OR INJURIES CAUSED OR ACCRUED ON THIS PROPERTY DURING THE PRE/ACTUAL/POST CONSTRUCTION PHASES OF THIS PROJECT.
- 16. PILFERAGE: EACH CONTRACTOR WILL BE RESPONSIBLE FOR HIS OWN EQUIPMENT AND MATERIALS USED IN CONSTRUCTION INCLUDING THOSE ITEMS, FURNISHED BY THE OWNER, AND DELIVERED TO THE JOB SITE, TO BE INSTALLED BY THE CONTRACTOR. THE OWNER WILL NOT BE HELD LIABLE FOR STOLEN EQUIPMENT, MATERIALS OR DAMAGE OF THE SAME ON THIS JOB SITE.
- 17. LIENS: ALL SUBCONTRACTORS AND THE GENERAL CONTRACTOR WILL DELIVER TO THE OWNER. A COMPLETE RELEASE OF ALL CLAIMS ARISING OUT OF THIS CONTRACT.
- 18. GENERAL CONTRACTOR WILL BE RESPONSIBLE FOR REMOVAL OF DEBRIS ACCUMULATED BY EACH TRADE, HOWEVER, EACH TRADE WILL KEEP THE JOB SITE CLEAN AND SAFE AT ALL TIMES, ALONG WITH A BROOM FINISH AT THE END OF EACH WORKING DAY.
- 19. SCHEDULE OF WORK: THE OWNER CONSTRUCTION MANAGER WILL COORDINATE WITH THE GENERAL CONTRACTOR DURING THE BIDDING PROCESS, THE REQUIRED NUMBER OF CALENDAR DAYS TO COMPLETE



# BRIDGES OF POPLAR CREEK DRIVING RANGE

1400 POPLAR CREEK DRIVE HOFFMAN ESTATES, IL 60169



# DRAWING INDEX

#### **GENERAL**

CODE INFORMATION & EGRESS PLAN

#### **ARCHITECTURAL**

FLOOR PLAN A121 REFLECTED CEILING PLAN ROOF PLAN A131 SLAB PLAN **EXTERIOR ELEVATIONS** 

INTERIOR ELEVATIONS

SCHEDULES AND ELEVATIONS

#### A701

**MECHANICAL** 

MECHANICAL PLAN MECHANICAL SITE PLAN MECHANICAL DETAILS

#### ELECTRICAL

ELECTRICAL PLANS RISER DIAGRAM & PANEL SCHEDULES

#### ELECTRICAL SPECIFICATION, SYMBOLS AND NOTES LIGHTING FIXTURE SCHEDULE

SNOW MELT DETAILS SITE ELECTRICAL PLAN

CIVIL DRAWINGS AND FIRE PROTECTION DRAWINGS ARE UNDER SEPARATE DRAWING SET.

## PROJECT DIRECTORY

HOFFMAN ESTATES PARK DISTRICT ATTN: DUSTIN HUGEN 1685 W. HIGGINS ROAD HOFFMAN ESTATES, IL 60169 847.285.5465

#### <u>ARCHITECT</u>

API ARCHITECTS ATTN: CHRISTIAN KALISCHEFSKI 2675 PRATUM AVENUE HOFFMAN ESTATES, IL 60192 224.293.6333

#### CIVIL ENGINEER

WT GROUP ATTN: TODD ABRAMS 2675 PRATUM AVENUE HOFFMAN ESTATES, IL 60192 224.293.6333

# MECHANICAL, ELECTRICAL, AND PLUMBING ENGINEER

WT GROUP ATTN: MARK VENTRELLI 2675 PRATUM AVENUE HOFFMAN ESTATES, IL 60192 224.293.6333

**LOCATION MAP** 

# GENERAL BUILDING INFORMATION

#### HOFFMAN ESTATES ADOPTED CODES INTERNATIONAL BUILDING CODE INTERNATIONAL FIRE CODE INTERNATIONAL MECHANICAL CODE NATIONAL ELECTRICAL CODE CURRENT ILLINOIS STATE PLUMBING CODE ILLINOIS ACCESSIBILITY CODE CURRENT ILLINOIS ENERGY CONSERVATION CODE INTERNATIONAL FUEL GAS CODE CURRENT HOFFMAN ESTATES ZONING ORDINANCE

# BUILDING DATA

ZONING CLASSIFICATION: RPD - RESIDENTIAL PLANNED DEVELOPMENT DISTRICT OCCUPANCY: CONSTRUCTION TYPE: NUMBER OF STORIES:


BUILDING AREA:

THE INFORMATION CONTAINED ON THIS SHEET IS INTENDED AS A GENERAL OVERVIEW OF THE PROJECT. A FULL DETAILED CODE REVIEW FOR THIS PROJECT CAN BE FOUND ON SHEET G002.

4,492 SQ.FT.

## STATEMENT OF COMPLIANCE

I, CHRISTIAN KALISCHEFSKI, A.I.A., DULY LICENSED IN THE STATE OF ILLINOIS BY THE DEPARTMENT OF PROFESSIONAL REGULATION, DO HEREBY STATE THAT THIS DOCUMENT WAS PREPARED BY ME OR UNDER MY DIRECT SUPERVISION AND TO THE BEST OF MY KNOWLEDGE AND BELIEF DOES CONFORM TO THE APPLICABLE BUILDING CODES AND ORDINANCES, AND ARE IN COMPLIANCE WITH THE ENVIRONMENTAL BARRIERS ACT [410 ILLS 25] AND THE ILLINOIS ACCESSIBILITY CODE (71 III.ADM. CODE 400).

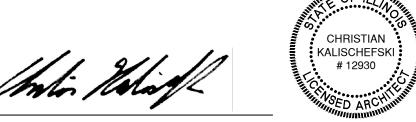

CHRISTIAN KALISCHEFSKI ILLINOIS REGISTRATION NUMBER: 001-012930 DATE OF EXPIRATION: NOVEMBER 30, 2022


## SCOPE OF WORK

THIS IS A NEW GOLF DRIVING RANGE SHELTER TO INCLUDE A NEW 4,492 SQ. FT. BUILDING.

03.19.2021 E

**COVER SHEET** 



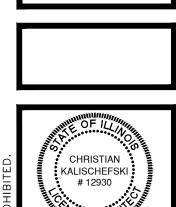







i roject & C	Code Information	200240710 -	· Bridges of Poplar Creek - I	ioninan Lotatoo, IL	
		contract shall comply with the provi	sions of the specifications and drawing and Licenses necessary for	s, and shall satisfy all applicable	
CODES					
2015 INTERNA	TIONAL BUILDING CODE		2017 NATIONAL ELECTRICAL CODE	=	
2015 INTERNA	TIONAL MECHANICAL COL	DE	2014 ILLINOIS PLUMBING CODE		
2015 INTERNA	TIONAL FIRE CODE		2018 ILLINOIS ACCESSIBILITY COD	E	
2018 ILLINOIS	ENERGY CONSERVATION	CODE	LOCAL ADMENDMENTS TO ABOVE	CODES	
CODE	SECTION	ITEM	REQUIRED or ALLOWED	PROVIDED	
IBC 2015	302.1	Use & Occupancy Classification	110 1 0 1 1 1 1 1 1 1 1 1 1 1 1 1 1 1 1	Group A-5	
IBC 2015	903.2	Automatic Sprinkler System	Group A-5 sprinkler required in retail	N/A - no sprinkler provided	
IBC 2013	905.2	Automatic Sprinkler System	and concessions areas over 1000 sf	14/A - 110 Sprillikier provided	
IBC 2015	602	Construction Type:	VB	VB	
IBC 2015	Table 504.3	Allowable Building Height in Feet Above Grade Plane	40'-0" max	19'-0"	
IBC 2015	Table 504.4	Allowable Number of Stories Above Grade Plane	UL (unlimited)	1 story	
IBC 2015	Table 506.2	Allowable Area	UL (unlimited)	4,492 SF	
IBC 2015	Table 601	Fire resistance - Structural frame (I.e. columns, beams,	VB = 0 HRS	0 HRS	
IBC 2015	Table 601	Fire resistance - Exterior bearing walls	0 HRS (as required by Table 602 & Table 705.8)	0 HRS	
IBC 2015	Table 601	Fire resistance - Interior bearing walls	VB = 0 HRS	0 HRS	
IBC 2015	Table 601	Fire resistance - Exterior non- bearing walls	VB = 0 HRS	0 HRS	
IBC 2015	Table 601	Fire resistance - Interior non- bearing walls	VB = 0 HRS	0 HRS	
IBC 2015	Table 601	Fire resistance - Floor Construction (incl. beams & joists)	VB = 0 HRS	0 HRS	
IBC 2015	Table 601	Fire resistance - Roof Construction (incl. beams and joists)	VB = 0 HRS	0 HRS	
IBC 2015	Table 602	Exterior Wall Fire Resistance	x < 5', 1 hour	North ≥ 30', 0 hour	
		Ratings	5' ≤ x < 10', 1 hour	East ≥ 30', 0 hour	
			10' ≤ x < 30', 0 hour	South ≥ 30', 0 hour	
			x ≥ 30', 0 hour	West ≥ 30', 0 hour	
IBC 2015	Table 1004.1.2	Occupant Load	Assembly (without fixed seats, unconcentrated) = 15 sf net	2899 SF / 15 SF = 193.27 peop	
			Business = 100 sf gross	283 SF / 100 SF = 2.83 people	
			Storage/Mech = 300 sf gross	275 SF / 300 SF = 0.92 people	
			Individual golf stations = 10	10 people	
			TOTAL	207.02 = 207 people	
IBC 2015	1005.3.2	Minimum Egress Width	Occupants 207 x .2" = 41.4"	36" x 2 = 72"	
IBC 2015	1005.7.1	Door encroachment	max 7" encroachment, less than 50% aisle reduction	OK	
IBC 2015	1010.1.1	Minimum Size of Doors	32"	36"	
IBC 2015	Table 1006.2.1	Common Path of Egress	75' maximum	26'-7"	
IBC 2015	Table 1006.2.1	Min Numbers of Exits Per Space	Group A - only 1 exit required if less than 49 occupants & travel distance is 75'-0" or less. Therefore 2 exist are required	2 provided	
IBC 2015	1007.1.1	Separation of Exits	>1/2 the Max Diagonal Building ( 144'-4" / 2 = 72'-2" min )	141'-11"	
IDO OS 1 T		F '' A T   15' '	1	4001.411	

Exit Access Travel Distance Group A, no sprinkler = 200' Max


162'-1" max

Table 1017.2

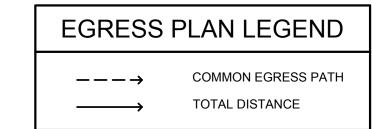


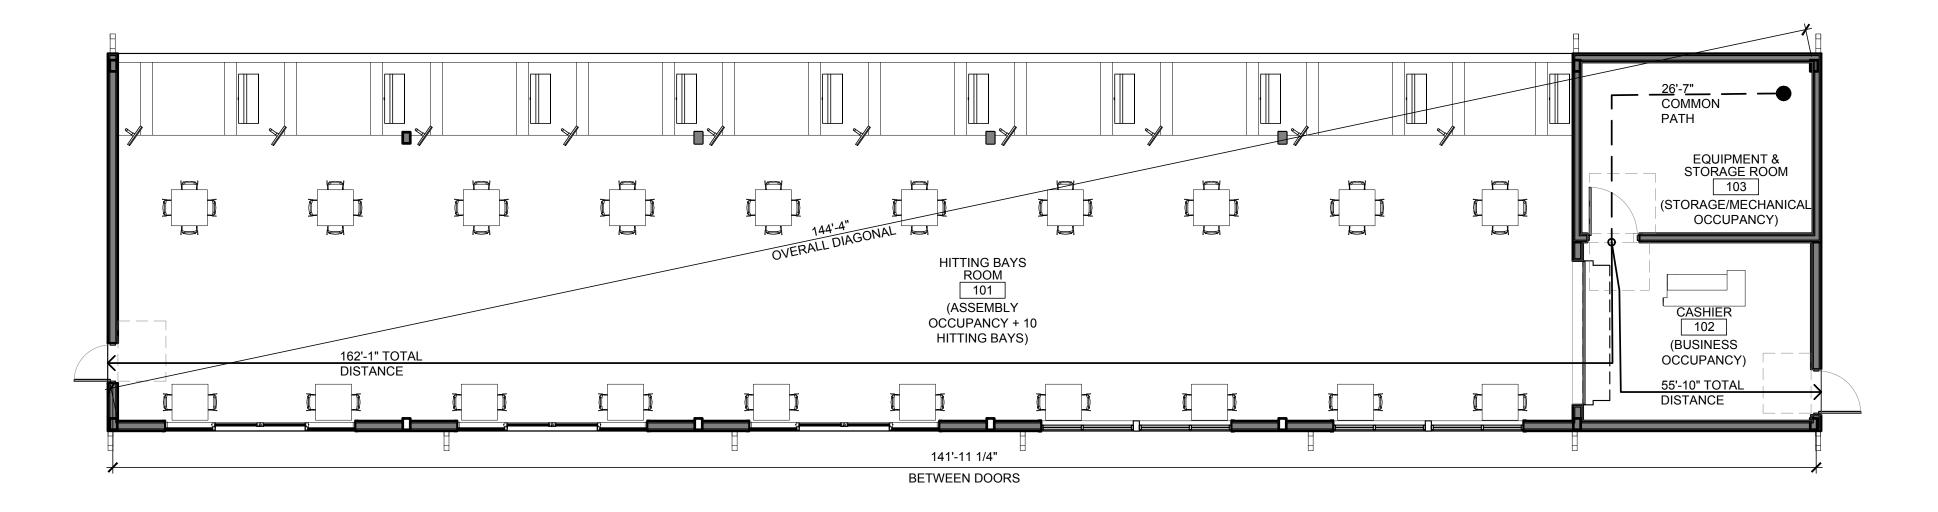


OCCUPANCY AND EGRESS PATH PLAN SCALE: 1/8" = 1' - 0"

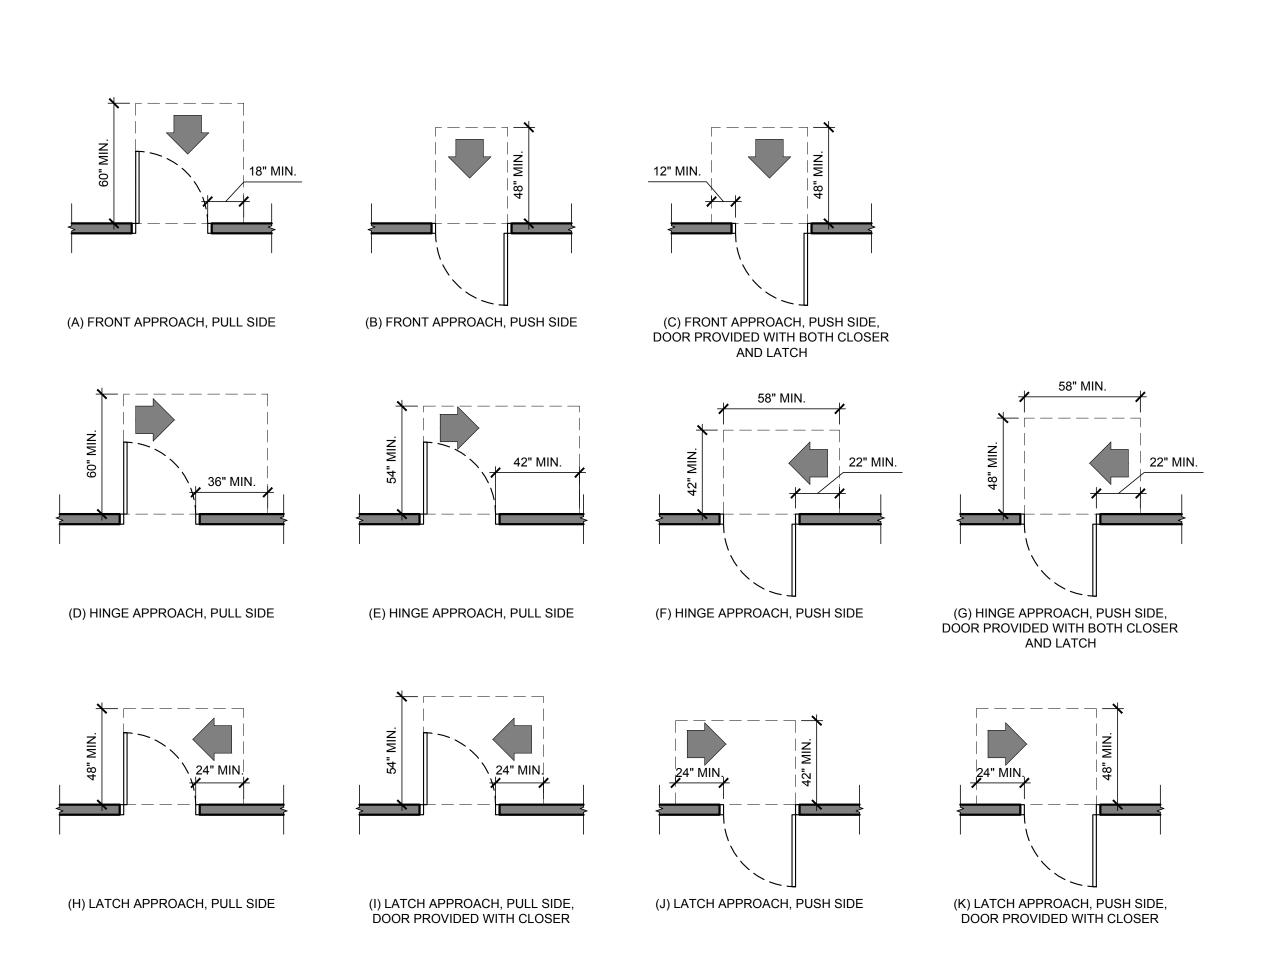



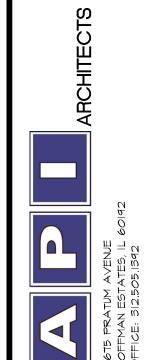

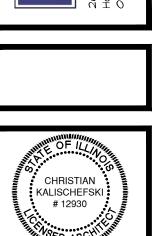

DRIVING DRIVE

60169

*0*3.19.2021 B

sheet title:
CODE INFORMATION
& EGRESS PLAN

# PRE-FABRICATED BUILDING SPECIFICATIONS

GENERAL PRE-FAB BUILDING DESCRIPTION 1. POST FRAME BUILDING COLUMN CONSISTING OF A WOOD TRUSSES (MINIMUM REQUIREMENTS) PRE-CAST CONCRETE EMBEDDED PORTION WITH EXPOSED REBAR DOWELS FOR EMBEDMENT IN CAST-IN-PLACE CONCRETE FOOTING, A WOOD UPPER PORTION, AN INTERNAL STEEL BRACKET CONNECTION BETWEEN WOOD AND CONCRETE, AND A STEEL ADJUSTING ROD FOR POST HEIGHT

#### STANDARDS

SCREWS.

- 1. BUILDING CODE REQUIREMENTS FOR STRUCTURAL CONCRETE BY THE AMERICAN CONCRETE
- ALL DEAD LOADS. RESISTANCE FACTOR DESIGN BY THE AMERICAN INSTITUTE OF STEEL CONSTRUCTION (AISC). INSTALL PLATES IN ACCORDANCE WITH
- CONSTRUCTION (NDS) BY THE AMERICAN FOREST AND PAPER ASSOCIATION (AF&PA). 4. 2015 INTERNATIONAL BUILDING CODE (2015 IBC) BY

#### THE INTERNATIONAL CODE COUNCIL (ICC) CONCRETE FOUNDATIONS (MINIMUM REQUIREMENTS)

- 1. CONCRETE COLUMN: 10,000 (NOMINAL) PSI PRE-CAST SELF-CONSOLIDATING CONCRETE (SCC) WITH FOUR (4) CONTINUOUS VERTICAL DEFORMED LOW-ALLOY-STEEL REINFORCING BARS OF ASTM A706 WELDABLE 60 KSI YIELD STRENGTH STEEL. SUPERPLASTICIZERS AND POLYMER FIBER REINFORCEMENT ARE ADDED AS WELL AS OTHER ADMIXTURES TO INCREASE FREEZE/THAW RESISTANCE, RUST RESISTANCE, FLEXURAL AND COMPRESSIVE STRENGTH AS WELL AS OPTIMIZING THE HYDRATION PROCESS.
- 2. ADJUSTING ANCHOR ROD ASSEMBLY: 36 KSI THREAD ROD AND ASTM A 36 BASE PLATE.
- 3. INTERNAL STEEL BRACKET: ASTM A 572, GRADE 50, STEEL BRACKET WITH 1/4" DIAMETERS HOLES FOR WOOD FASTENER
- WOOD COLUMNS (MINIMUM REQUIREMENTS) 1. FACTORY FABRICATED FROM MINIMUM 3-PLY NO. 1
- 2. ATTACH UPPER COLUMN TO LOWER COLUMN WITH APPROPRIATE NUMBER AND SIZE OF
- PNEUMATICALLY DRIVEN FASTENERS. 3. PROVIDE FACTORY OR FIELD INSTALLED BLOCKING ON OUTSIDE FACE OF COLUMN BETWEEN NAILERS.

- 1. LUMBER ALL MEMBERS TO BE SOUTHERN YELLOW PINE OF SIZE AND GRADE TO MEET DESIGN
- REQUIREMENTS 2. TRUSSES SHALL BE CONSTRUCTED OF SURFACED LUMBER (S4S) AND COMPLIANT WITH SPIB VISUAL AND STRUCTURAL GRADE REQUIREMENTS 3. PLATES: CONNECTOR PLATES SHALL MEET DESIGN REQUIREMENTS AND SHALL BE COMPLIANT WITH
- APPLICABLE ICC-ES STANDARDS AND SPECIFICATIONS 4. DESIGN AND FABRICATE TRUSSES AND CONNECTIONS TO WITHSTAND SNOW, WIND AND
- 5. FABRICATE TRUSSES IN PLANT, USING MECHANICAL OR HYDRAULIC FIXTURES AS REQUIRED TO BRING MEMBERS INTO CONTACT.
- - a. 2" X 8" NO. 1 SOUTHERN YELLOW PINE WITH 1/2" X 7/16" NOTCH
  - b. PRESSURE TREATED WITH WOOD PRESERVATIVE TO A RETENTION IN COMPLIANCE WITH APPLICABLE AWPA OR ICC-ES STANDARDS AND SPECIFICATIONS AND KILN DRIED AFTER TREATMENT TO 19%
  - SAPWOOD.
- WALL GIRTS a. FIRST NAILER (GIRT) ABOVE BASEBOARD: 2" X 6" NO. 2 OR BETTER
- NAILERS: 2" X 4" 2100 MSR (MINIMUM) SPF c. OVERHANG TOP NAILER: 2" X 6" NO. 2 OR
- BETTER SPF 3. BASE REINFORCEMENT - 7/16" X 32" OSB PANELS INSTALLED BETWEEN THE BASEBOARD AND FIRST
- 5. OVERHANG FRAMING a. PROVIDE FACTORY FABRICATED RAFTER
- FACTORY BEVELED FASCIA BOARDS.

- 6. WIND BRACING 2" X 6" NO. 2 OR BETTER SPF FROM ENDWALL COLUMN TO FIRST TRUSS BACK.
- 7. FRAMING AROUND OPENINGS a. 2" X 4" NO. 2 OR BETTER SPF AROUND
- PERSONNEL DOORS. b. 2" X 6" NO. 2 OR BETTER SPF AROUND OVERHEAD DOOR OPENINGS
- 8. HEADERS PROVIDE BUILT-UP HEADERS AS REQUIRED FOR PROPER INSTALLATION.
- INCIDENTAL FRAMING - 2" X 4" AND/OR 2" X 6" NO. 2 OR BETTER
- 10. INTERIOR FRAMING 2" X 4" NO. 2 OR BETTER SPF 11. ROOFING PANELS - 3/4" OSB
- METAL SIDING (MINIMUM REQUIREMENTS) 1. PANEL SUBSTRATE SHALL BE 0.019" MINIMUM THICKNESS COMMERCIAL STEEL SHEET WITH G90 (ZINC) COATING PER ASTM A653 OR AZ55
- (ALUMINUM/ZINC) COATING PER ASTM A792. 2. THE WEATHER SIDE OF THE PANEL SHALL RECEIVE A NOMINAL TWO TENTHS MIL POLYURETHANE PRIMER AND A NOMINAL EIGHT TENTHS MIL TOPCOAT OF 70\$ POLYVINYLIDENE DIFLUORIDE (PVDF) RESIN TO ACHIEVE A TOTAL NOMINAL PAINT
- FILM THICKNESS OF ONE MIL. 3. COLOR SELECTION OF SIDING PANELS SHALL BE FROM THE MANUFACTURER'S STANDARD COLOR
- CHART 4. THE NON-WEATHER SIDE PAINT SYSTEM SHALL CONSIST OF A TWO COAT FINISH WITH A TOTAL
- NOMINAL THICKNESS OF ONE-HALF MIL. 5. METAL TRIM ITEMS - DIE-FORMED STEEL FROM THE SAME QUALITY MATERIAL AS THE SIDING PANELS
- OTHER MATERIALS (MINIMUM REQUIREMENTS) 1. SEALANT - 100% NEUTRAL CURING SILICONE SEALANT, AND PAINTABLE SEALANT WHERE
- REQUIRED 2. INSULATION - MINIMUM 6" THICK, R19 FIBERGLASS BLANKETS IN WALL
- 3. VAPOR RETARDER 4 MIL. THICK POLYETHYLENE SHEETS

PREFABRICATED WALL CONSTRUCTION CLEAR FLOOR AREA PER ACCESSIBILITY


DOOR TAG, SEE DOOR SCHEDULE

WINDOW TAG, SEE WINDOW SCHEDULE

FINISH TAG, SEE FINISH SCHEDULE

#### FLOOR PLAN GENERAL NOTES

- A. ALL CONTRACTORS TO VERIFY EXISTING SITE CONDITIONS AND DIMENSIONS BEFORE ANY WORK IS TO BEGIN. NOTIFY ARCHITECT OF DISCREPANCIES.
- B. ALL WORK TO BE DONE IN ACCORDANCE WITH ALL GOVERNING
- STATE AND LOCAL CODES, ORDINANCES, AND AMENDMENTS. C. PROVIDE ALL REQUIRED IN WALL BLOCKING FOR ALL WALL
- MOUNTED EQUIPMENT, MILLWORK, SHELVING, AND ACCESSORIES. D. MOUNT ALL FIXTURES & ACCESSORIES AT HEIGHTS CONFORMING
- WITH ALL GOVERNING CODES & ACCESSIBILITY REQUIREMENTS.
- E. ALL WOOD BLOCKING AND PLYWOOD TO BE FIRE TREATED.
- FIRE EXTINGUISHERS ARE SUPPLIED AND INSTALLED BY THE G.C. QUANTITIES AND LOCATIONS TO BE COORDINATED W/ THE LOCAL FIRE DEPARTMENT.
- G. ALL DIMENSIONS ARE NOMINAL & ARE FROM FACE OF GYPSUM BOARD, SHEATHING, OR SUBSTRATE.
- H. PROVIDE CONTINUOUS BEAD OF CLEAR SILICONE SEALANT AT INTERIOR SIDE OF ALL WALL TRANSITIONS. SEAL ALL NEW AND EXISTING OPENINGS IN FLOORS, STRUCTURAL DECK AND EXTERIOR WALLS IN ORDER TO PROVIDE A WEATHER TIGHT SEAL.
- I. ALL WALLS ARE AT 90° UNLESS NOTED OTHERWISE.
- PROPERLY PREPARE & CLEAN SUBSTRATES & SURFACES AS REQUIRED TO ACCEPT FINISHES, MATERIALS, TREATMENTS, ETC.

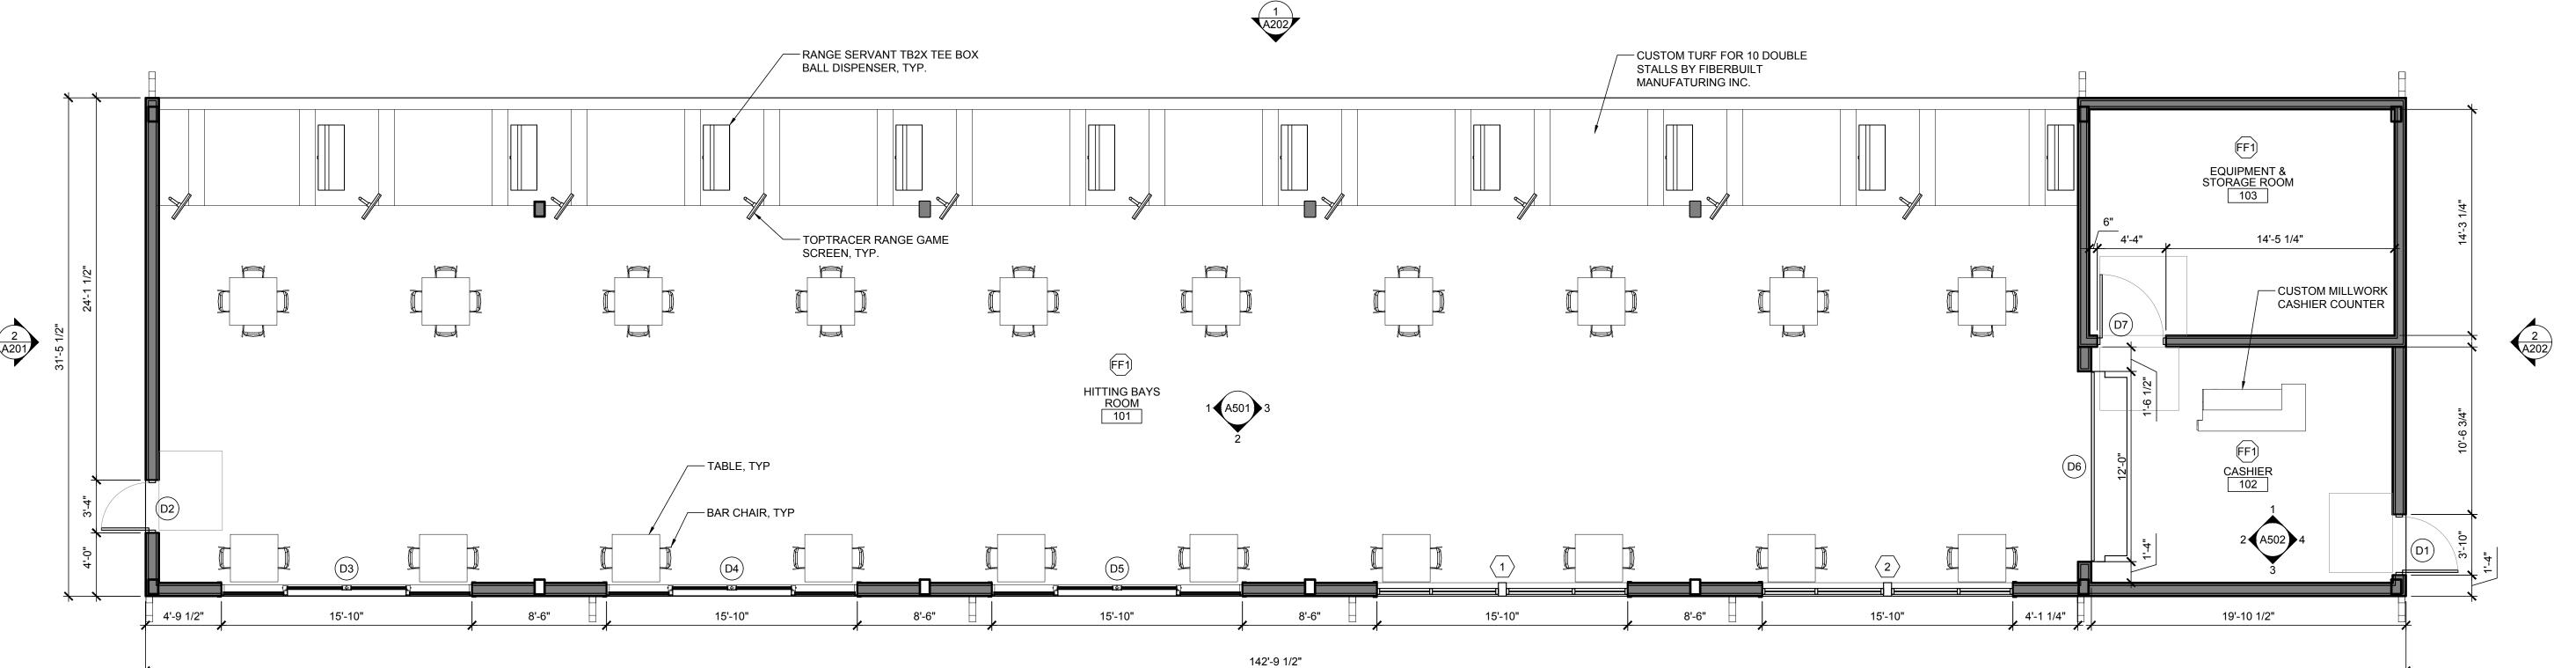



60169

DRIVE

CREEK

**FLOOR PLAN** 

ADJUSTMENT.

INSTITUTE (ACI 318). 2. MANUAL OF STEEL CONSTRUCTION, LOAD AND

3. THE NATIONAL DESIGN SPECIFICATION FOR WOOD MANUFACTURER'S INSTRUCTIONS.

OTHER WOOD FRAMING (MINIMUM REQUIREMENTS) 1. BASEBOARDS

MAXIMUM MOISTURE CONTENT c. PRESERVATIVE SHALL PENETRATE 100% OF


SPRUCE-PINE-FIR (SPF) b. BALANCE OF

NAILER AND LOCATED IN NOTCHES. 4. PURLINS AND TRUSS TIES - 2" X 4" NO. 2 OR BETTER

FRAMES. b. PROVIDE 2" X 6" NO. 2 OR BETTER SPF FLOOR PLAN LEGEND

2 A201

FLOOR PLAN

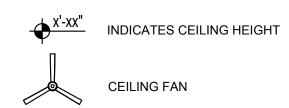

SEE ELECTRICAL AND MECHANICAL SHEETS FOR LIGHTING AND HEATING LOCATIONS AND SPECIFICATIONS

# BIRD NET SPECIFICATIONS

- A. BIRD.B.GONE BIRD NET 2000.
- B. 3/4" UV-STABILIZED, FLAME-RESISTANT, ROT-PROOF, NON-CONDUCTIVE POLYETHYLENE KNOTTED NET.
- C. FASTEN TO BOTTOM CHORD OF ROOF TRUSSES WITH BIRD.B.GONE SUPPORTS AT CORNERS AND INTERMEDIATE SPACED AT 1'-0" O.C. MAX.
- D. INSTALL (1) 6'-0" ZIPPER (VIA HOG RINGS) IN EACH BAY ADJACENT TO TRUSS AT 1/4 POINT FROM BACK WALL.
- E. COLOR: BLACK.

# REFLECTED CEILING PLAN GENERAL NOTES


- A. ALL CONTRACTORS TO VERIFY EXISTING SITE CONDITIONS AND DIMENSIONS BEFORE ANY WORK IS TO BEGIN. NOTIFY ARCHITECT OF DISCREPANCIES.
- B. ALL WORK TO BE DONE IN ACCORDANCE WITH ALL GOVERNING STATE AND LOCAL CODES, ORDINANCES,
- C. ALL DIMENSIONS ARE FROM FACE OF SUBSTRATE UNLESS NOTED OTHERWISE
- D. ALL CEILING HEIGHTS ARE TAKEN FROM PROJECT 0'-0".

AND AMENDMENTS.

DISCREPANCIES.

DRAWINGS.

- E. SEE ELECTRICAL DRAWINGS FOR LIGHTING SCHEDULE AND SPECIFICATIONS.
- F. COORDINATE LOCATION OF LIGHT FIXTURES AND POWER SUPPLY WITH ELECTRICAL DRAWINGS.
- G. CONTRACTOR TO SUBMIT LIGHTING CUTS TO OWNER FOR APPROVAL PRIOR TO ORDERING. CONTRACTOR SHALL VERIFY LIGHTING CATALOG NUMBER WITH ELECTRICAL DRAWINGS AND NOTIFY THE OWNER OF ANY
- H. PROVIDE MIN. 24"x24" ACCESS PANELS TO ALL EQUIPMENT WHICH REQUIRE MAINTENANCE ACCESS THAT ARE LOCATED ABOVE GYPSUM BOARD CEILINGS, PAINT TO MATCH COLOR OF ADJACENT CEILING. COORDINATE LOCATION OF ACCESS PANELS WITH MECHANICAL
- I. GENERAL CONTRACTOR TO COORDINATE LIGHT FIXTURE CLEARANCE REQUIREMENTS WITH ABOVE CEILING UTILITIES, I.E. PLUMBING, CONDUIT & DUCTWORK, BEFORE COMMENCING WORK.
- J. PAINT ALL EXPOSED DUCT WORK, PIPING, CONDUIT, AS INDICATED ON THE REFLECTED CEILING PLANS, FLOOR PLANS, AND ELEVATIONS.
- K. ELECTRICAL CONTRACTOR TO VERIFY ALL LOCATIONS OF WALL MOUNTED CLOCK OUTLETS, J-BOXES, AND ITEMS PROVIDED BY THE OWNER, SEE ELECTRICAL DRAWINGS.
- L. GENERAL CONTRACTOR TO PROVIDE POWER FOR EXTERIOR SIGNAGE, COORDINATE WITH TENANT'S SIGNAGE CONTRACTOR.
- M. GENERAL CONTRACTOR TO INSTALL CONDUIT AND PULL STRINGS IN CEILING AS REQUIRED BY CODE FOR LOW VOLTAGE SYSTEMS. COORDINATE WITH OWNER'S SOUND SYSTEM VENDOR AND SECURITY CAMERA VENDOR.
- N. GENERAL CONTRACTOR TO COORDINATE LOCATION OF ALL FIRE ALARM DEVICES PRIOR TO INSTALLATION.

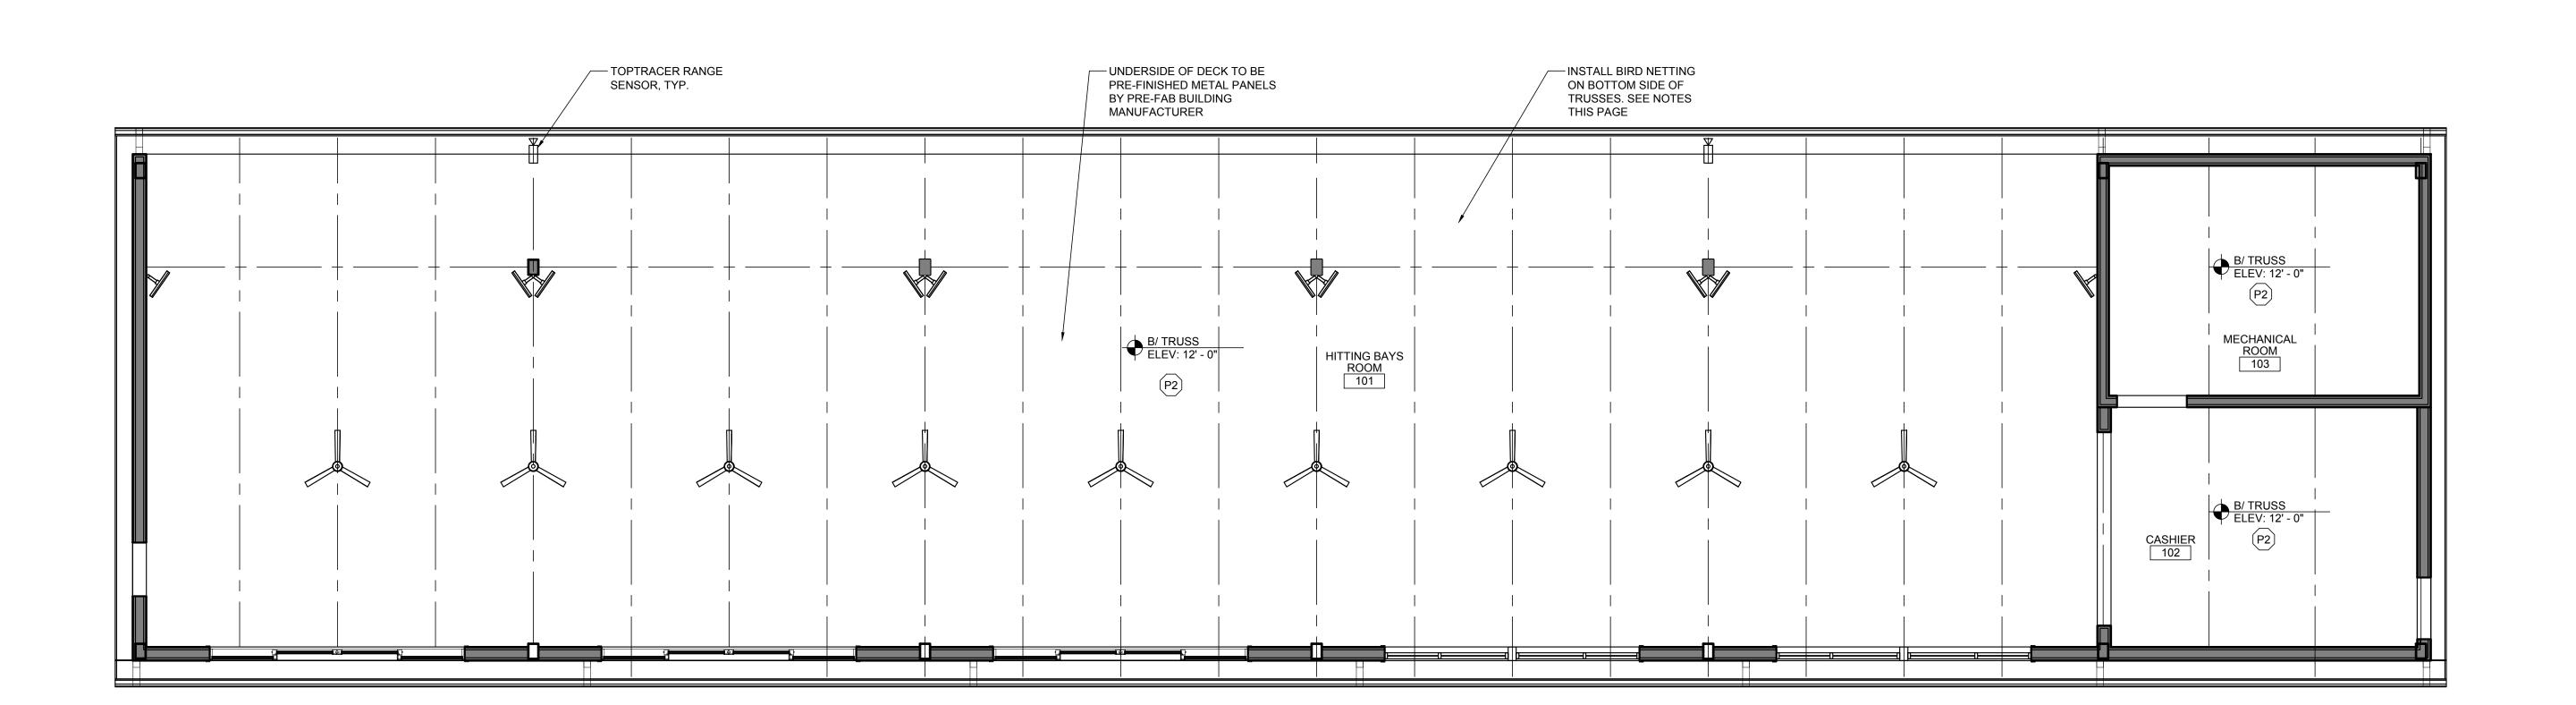


REFLECTED CEILING PLAN

SCALE: 3/16" = 1'-0"



ARCHITE
AN ESTATES, IL 60192
312 505 1992

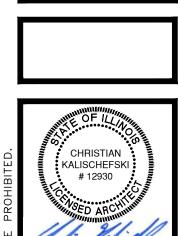

Signature

DOCUMENTS TO THE ORIGINAL SITE OR PURPOSE FOR CREEK DRIVING RANGE

POPLAR CREEK DRIVE

project no. 2002487 date: 03.19.2021 B revision 1: revision 2: revision 3: revision 4:

sheet title:
REFLECTED
CEILING PLAN
sheet number:
A 1 2 1

#### ROOF PLAN LEGEND

----- - ARROW INDICATES DIRECTION OF ROOF SLOPE

# ASPHALT SHINGLE ROOFING SYSTEM

PITCHED ROOF CLADDING PRODUCT TO BE APPROVED BY THE OWNER PRIOR TO ORDER AND CONSTRUCTION

USE CERTAINTEED 'LANDMARK' ARCHITECTURAL SHINGLES W / LIFETIME WARRANTY. (SEE ELEVATIONS FOR COLOR)

ROOF SYSTEM MUST BE INSTALLED BY A CERTAINTEED AUTHORIZED ROOFING APPLICATOR (IF APPLICABLE).

USE 30# ROOFING FELT UNDER CERTAINTEED SHINGLE SYSTEM. ICE AND WATER SHIELD TO BE INSTALLED 18" EACH SIDE OF RIDGE, 36" AT EAVES.

ALL FLASHING TO HAVE METAL DRIP EDGE AND TO EXTEND UNDER ICE AND WATER SHIELD 8" MINIMUM.

### ROOF GENERAL NOTES

- A. PROVIDE A COMPLETE AND WATER TIGHT ROOFING SYSTEM THAT MAINTAINS THE ROOF SYSTEM MANUFACTURER'S WARRANTY.
- B. PROCEED WITH WORK ONLY WHEN WEATHER CONDITIONS PERMIT WORK TO PROCEED WITHOUT WATER ENTERING THE ROOFING SYSTEM.
- C. PROTECT ALL MATERIAL FROM SATURATION OF WATER PRIOR TO FINAL INSTALLATION OF ROOF MEMBRANE.
- D. MAINTAIN ROOF DRAINS IN FUNCTIONING CONDITION TO ENSURE ROOF DRAINAGE AT END OF EACH WORK DAY. PREVENT DEBRIS FROM ENTERING OR BLOCKING ROOF DRAINS.
- E. ALL METAL FASTENERS TO BE CORROSION RESISTANT.
- ALL INSTALLED MATERIALS TO BE COMPATIBLE WITH ONE ANOTHER CAUSING NO DELETERIOUS EFFECTS.
- G. SEE M.E.P. SHEETS FOR VENTING PENETRATIONS LOCATIONS.

— CONTRACTOR TO PROVIDE & INSTALL OSB WOOD DECK AND MATERIALS. BUILDING OWNER TO PROVIDE AND INSTALL ICE & WATER SHIELD ROOFING UNDERLAYMENT AND ARCHITECTURAL ASPHALT SHINGLES. SEE BUILDING ELEVATION FOR ROOF SLOPE

LINE OF WALL BELOW

1) ROOF PLAN
SCALE: 3/16" = 1'-0"



ARCHITECTS
675 PRATUM AVENUE
OPEMAN ESTATES, IL 60/92
PPICE: 312.505.1392

sheet title:

ROOF PLAN
sheet number:

#### REINFORCED CONCRETE GENERAL NOTES

#### REINFORCED CONCRETE NOTES

- 1. ALL CAST-IN-PLACE CONCRETE SHALL BE OF THE TYPES AND HAVING MINIMUM 28-DAY COMPRESSIVE STRENGTHS AS FOLLOWS:
  FOOTINGS AND FOUNDATION WALLS: 4,000 PSI
  SLABS-ON-GRADES: 4,000 PSI
- MISCELLANEOUS FILLS AND PADS: 4,000 PSI

  2. ALL CONCRETE SHALL CONTAIN AN APPROVED WATER REDUCING PLASTICIZING ADMIXTURE. APPROVED, HIGH-RANGE, WATER REDUCING ADMIXTURES MAY BE UTILIZED. ALL CONCRETE FOR PERIMETER FOUNDATION
- WALLS AND OTHER EXTERIOR EXPOSED CONCRETE SHALL ALSO CONTAIN AN APPROVED AIR-ENTRAINING ADMIXTURE.
- 3. ALL REINFORCING BARS SHALL BE NEW BILLET STEEL CONFORMING TO THE STANDARDS OF ASTM A615, GRADE 60. Fy = 60,000 PSI OR ASTM A775, GRADE 60 EPOXY COATED REBAR.
- 4. ALL WELDED WIRE FABRIC SHALL CONFORM TO THE STANDARDS OF ASTM A185.
- 5. ALL CONCRETE REINFORCEMENT SHALL BE DETAILED, FABRICATED, LABELED, SUPPORTED, SPACED IN FORMS, AND SECURED IN PLACE IN ACCORDANCE WITH THE PROCEDURES AND REQUIREMENTS OUTLINED IN THE LATEST EDITION OF THE "BUILDING CODE REQUIREMENTS FOR REINFORCED CONCRETE," ACI 318, AND THE "MANUAL OF STANDARD PRACTICE FOR DETAILING REINFORCED CONCRETE STRUCTURES," ACI 315.
- 6. THE CONTRACTOR SHALL SUBMIT CHECKED SHOP DRAWINGS SHOWING REINFORCING DETAILS. INCLUDING STEEL SIZES, SPACING, PLACEMENT, AND SUPPORT DETAILS TO THE ARCHITECT FOR REVIEW PRIOR TO FABRICATION.
- 7. THE CONTRACTOR SHALL SUBMIT SHOP DRAWINGS SHOWING THE LOCATION OF ALL CONSTRUCTION JOINTS, CURBS, SLAB DEPRESSIONS, SLEEVES, OPENINGS, AND EMBEDMENTS TO ARCHITECT FOR REVIEW PRIOR TO
- 8. ALL REINFORCING SPLICES SHALL CONFORM TO THE REQUIREMENTS OF ACI 318. BUT IN NO CASE SHALL BE LESS THAN 36 BAR DIAMETERS, UNLESS NOTED OTHERWISE.
- 9. ALL WELDED WIRE FABRIC SHALL BE LAPPED TWO (2) FULL MESH PANELS AND TIED SECURELY.
- 10. WHERE REQUIRED, DOWELS SHALL MATCH THE SIZE AND NUMBER OF MAIN REINFORCING, UNLESS NOTED OTHERWISE.
- 11. ALL WALLS AND STRUCTURAL SLABS SHALL BE REINFORCED WITH MINIMUM NO. 4 AT 12" O.C. EACH WAY, EACH FACE, UNLESS NOTED OTHERWISE. ALL SLABS-ON-GRADE SHALL BE REINFORCED WITH AT LEAST ONE (1) LAYER OF 6X6 W1.4XW1.4 W.W.F., UNLESS NOTED OTHERWISE. PROVIDE ONE (1) LAYER OF 6X6 W1.4XW1.4 W.W.F. CONTINUOUS IN ALL CONCRETE FILLS ABOVE THE STRUCTURAL SLAB. ALL MECHANICAL, PLUMBING AND ELECTRICAL EQUIPMENT PADS SHALL BE REINFORCED WITH AT LEAST ONE (1) LAYER OF 6X6 W.W.F. (SEE HVAC, PLUMBING, AND ELECTRICAL DRAWINGS FOR ADDITIONAL REINFORCING REQUIREMENTS FOR PADS.)
- 12. ADDITIONAL BARS SHALL BE PROVIDED AROUND ALL FLOOR AND WALL OPENINGS, AS SHOWN ON DETAILS.
- 13. CONSTRUCTION JOINTS IN ALL WALLS SHALL NOT BE FURTHER APART THAN 60 FEET IN ANY DIRECTION.
- 14. ALL CONSTRUCTION JOINTS SHALL BE WIRE BRUSHED, CLEANED AND MOISTENED IMMEDIATELY PRIOR TO PLACING NEW CONCRETE.
- 15. PLACE ALL SLABS-ON-GRADE IN A CHECKERBOARD FASHION BETWEEN CONSTRUCTION JOINTS ALONG COLUMN CENTERLINES WITH A MINIMUM OF 24 HOURS BETWEEN ADJACENT POURS OR BE IN STRIP POURS OF MAXIMUM 15'-0" WIDTH. STRIP POURED SLABS SHALL HAVE SAWCUT CENTRAL JOINTS AS SHOWN ON FOUNDATION PLAN.
- 16. NO CALCIUM CHLORIDE SHALL BE USED IN ANY CONCRETE.
- 17. ALL BAR SUPPORTS SHALL BE GALVANIZED. BAR SUPPORTS IN CONTACT WITH EXPOSED SURFACES SHALL ALSO
- 18. FOOTINGS AND WALLS SHALL NOT BE SLEEVED OR BOXED-OUT OR HAVE THE REINFORCING INTERRUPTED, EXCEPT AS SHOWN ON THE STRUCTURAL DRAWINGS.
- 19. SEE ARCHITECTURAL DRAWINGS FOR TYPE AND LOCATION OF ALL FLOOR FINISHES, FLOOR DEPRESSIONS AND
- 20. SEE ARCHITECTURAL, HVAC, ELECTRICAL, AND PLUMBING DRAWINGS FOR ADDITIONAL WALL/SLAB OPENINGS.
- 21. PROVIDE APPROVED CURING COMPOUND AND SEALER FOR THE TOP SURFACE OF ALL SLAB WORK, UNLESS NOTED OTHERWISE.

#### 22. OPENINGS:

- A. OPENING SHOWN ARE FOR BIDDING PURPOSES ONLY. COORDINATE THE EXACT SIZE AND LOCATIONS WITH HVAC, PLUMBING, AND OTHER APPLICABLE TRADES BEFORE PROCEEDING WITH WORK.
- B. IF ANY OPENING NOT SHOWN ON THE PLAN IS REQUIRED, SECURE APPROVAL OF THE STRUCTURAL
- ENGINEER BEFORE PROCEEDING.
- C. PROVIDE TWO #5 BARS AROUND ALL SLAB AND WALL OPENINGS, EXTENDING 2 FEET BEYOND OPENING IN EVERY DIRECTION, U.N.O.; OPENINGS NOT EXCEEDING 16 INCHES X 16 INCHES MAY BE SLEEVED AS REQUIRED BY WORKING THE REINFORCING STEEL AROUND THEM.

#### 23. FOOTINGS AND PIERS:

- A. PROVIDE DOWELS IN FOOTINGS TO MATCH VERTICAL PIER OR WALL REINFORCING U.N.O.
- B. PROVIDE CORNER BARS AT WALL CORNERS TO MATCH HORIZONTAL REINFORCING. MINIMUM LAP LENGTH WITH HORIZONTAL REINFORCEMENT 45 BAR DIAMETERS.
- C. CAST IN CONTINUOUS DOVETAIL ANCHOR SLOTS ON VERTICAL SURFACES WHERE MASONRY ABUTS, 16 INCHES O.C. PARALLEL SURFACES AT CENTERLINE OF MASONRY FOR PERPENDICULAR SURFACES.

  D. PROVIDE LEAN CONCRETE (CLASS IV) UNDER FOUNDATIONS FOR ACCIDENTAL OVER-EXCAVATION, SOFT
- 24. SPLICES UNLESS NOTED OTHERWISE, MINIMUM LAB SPLICE LENGTHS SHALL BE AS FOLLOWS:
  A. VERTICAL BARS IN PIERS, (INCLUDING DOWELS): 48 BAR DIAMETERS

#### 25. CONSTRUCTION JOINTS:

- A. CONSTRUCTION JOINTS ARE PERMITTED ONLY WHERE SHOWN ON THE CONTRACT DRAWINGS OR AS APPROVED BY THE STRUCTURAL ENGINEER. ALL CONSTRUCTION JOINTS SHALL BE KEYED. KEYWAYS SHALL BE 1-1/2 INCHES DEEP X 1/3 MEMBER THICKNESS.
- 26. CONCRETE COVER: UNLESS NOTED OTHERWISE, DETAIL REINFORCING TO PROVIDE CONCRETE COVER AS
- FOLLOWS:
  A. CONCRETE CAST AGAINST AND PERMANENTLY EXPOSED TO EARTH: 3 INCHES
- B. CONCRETE EXPOSED TO EARTH OR WEATHER: #6 BARS THROUGH #18 BARS: 2 INCHES
- #5 BARS AND SMALLER OTHERS: 1 1/2 INCHES
  C. SLABS, JOINTS, AND WALLS NOT EXPOSED TO EARTH OR WEATHER:

B. HORIZONTAL BARS IN SLABS & FOOTINGS: 48 BAR DIAMETERS

- #14 BARS AND #18 BARS: 1 1/2 INCHES #11 BARS AND SMALLER: 3/4 INCH
- D. BEAMS, COLUMNS, PEDESTALS, AND TENSION TIES NOT EXPOSED TO EARTH OR WEATHER: 1 1/2 INCHES


#### 27. MISCELLANEOUS:

- A. GROUT UNDER BEARING PLATES, SETTING PLATES, AND COLUMN BASE PLATES SHALL BE NON-SHRINKING TYPE. THE USE OF LEVELING PLATES AT COLUMN BASES IS PROHIBITED. GROUT BELOW BEARING PLATES, SETTING PLATES, AND COLUMN BASE PLATES SHALL BE INSTALLED ONLY AFTER THE STEEL IN PLUMBED.
- 28. CUTTING AND BO
  - A. CONCRETE CUTTING AND BORING METHODS ARE "WAYS AND MEANS" OF CONSTRUCTION AND SHALL BE DETERMINED BY THE CONTRACTOR.

TURF MANUFACTURER

FIBERBUILT MANUFACTURING INC. PROJECT NUMBER: FG 112020-02 3613 - 63 AVENUE N.E. CALGARY, ALBERTA, CANADA T3J 5K1 833.328.3218 INFO@FIBERBUILT.COM



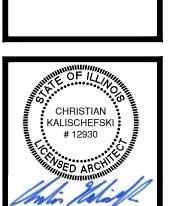

CHRISTIAN KALISCHEFSKI # 12930

Signature Expires: November 30, 202

PURPOSE FOR WHICH THEY WERE PREPARED. REPRODUCTIONS,

ESE DOCUMENTS TO THE ORIGINAL SITE OR PURPOSE FOR CREEK DRIVING RANGE

OPLAR CREEK DRIVE AN ESTATES, IL 60169


project no. 2002487.
date: 03.19.2021 B
revision 1:
revision 2:
revision 3:
revision 4:


sheet title:

SLAB PLAN

sheet number:

A 1 4 1

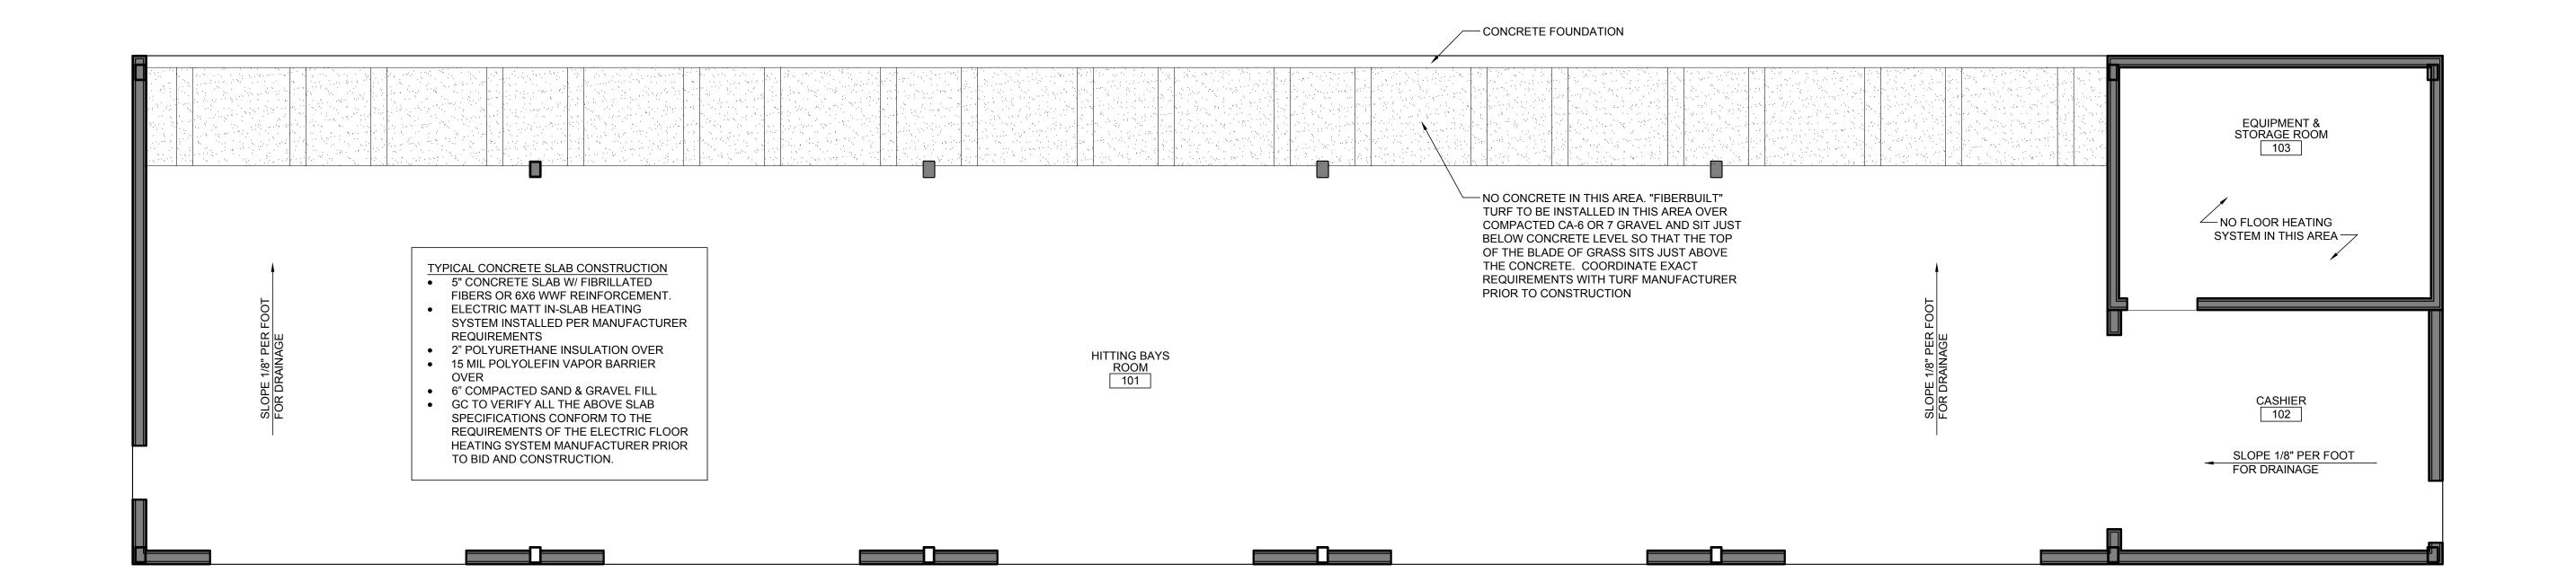

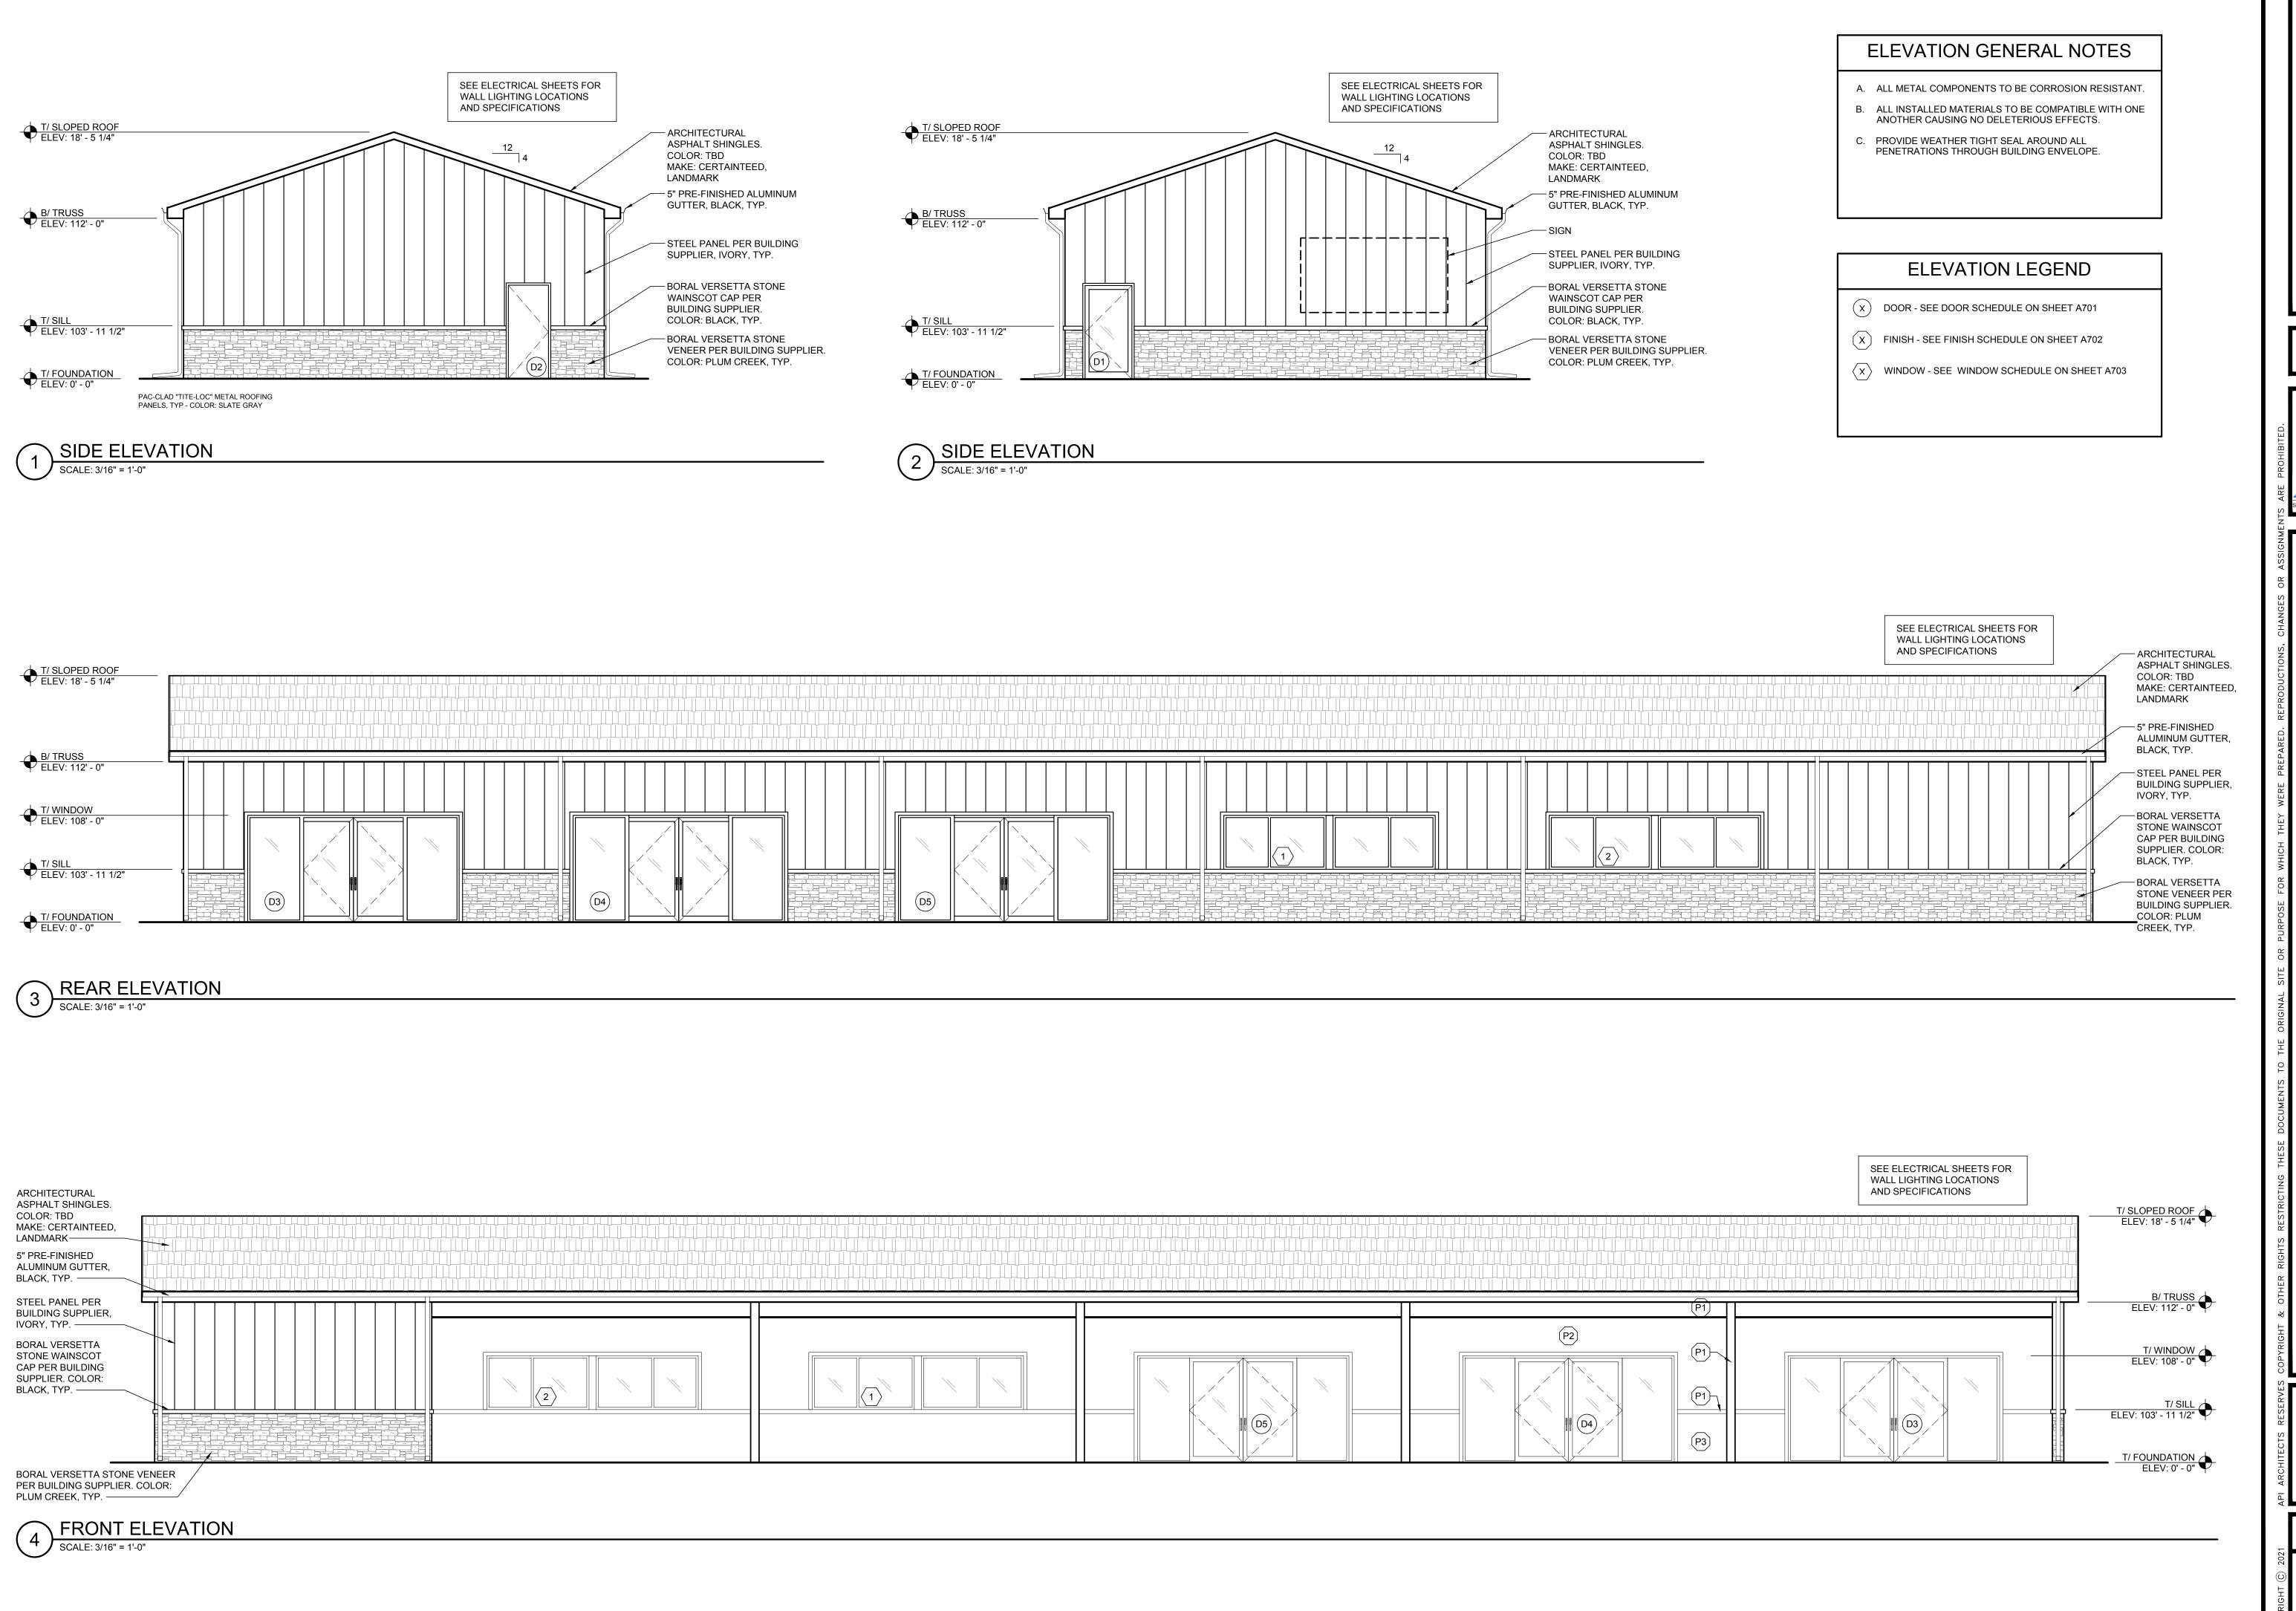





CREEK

60169

03.19.2021 B


EXTERIOR ELEVATIONS

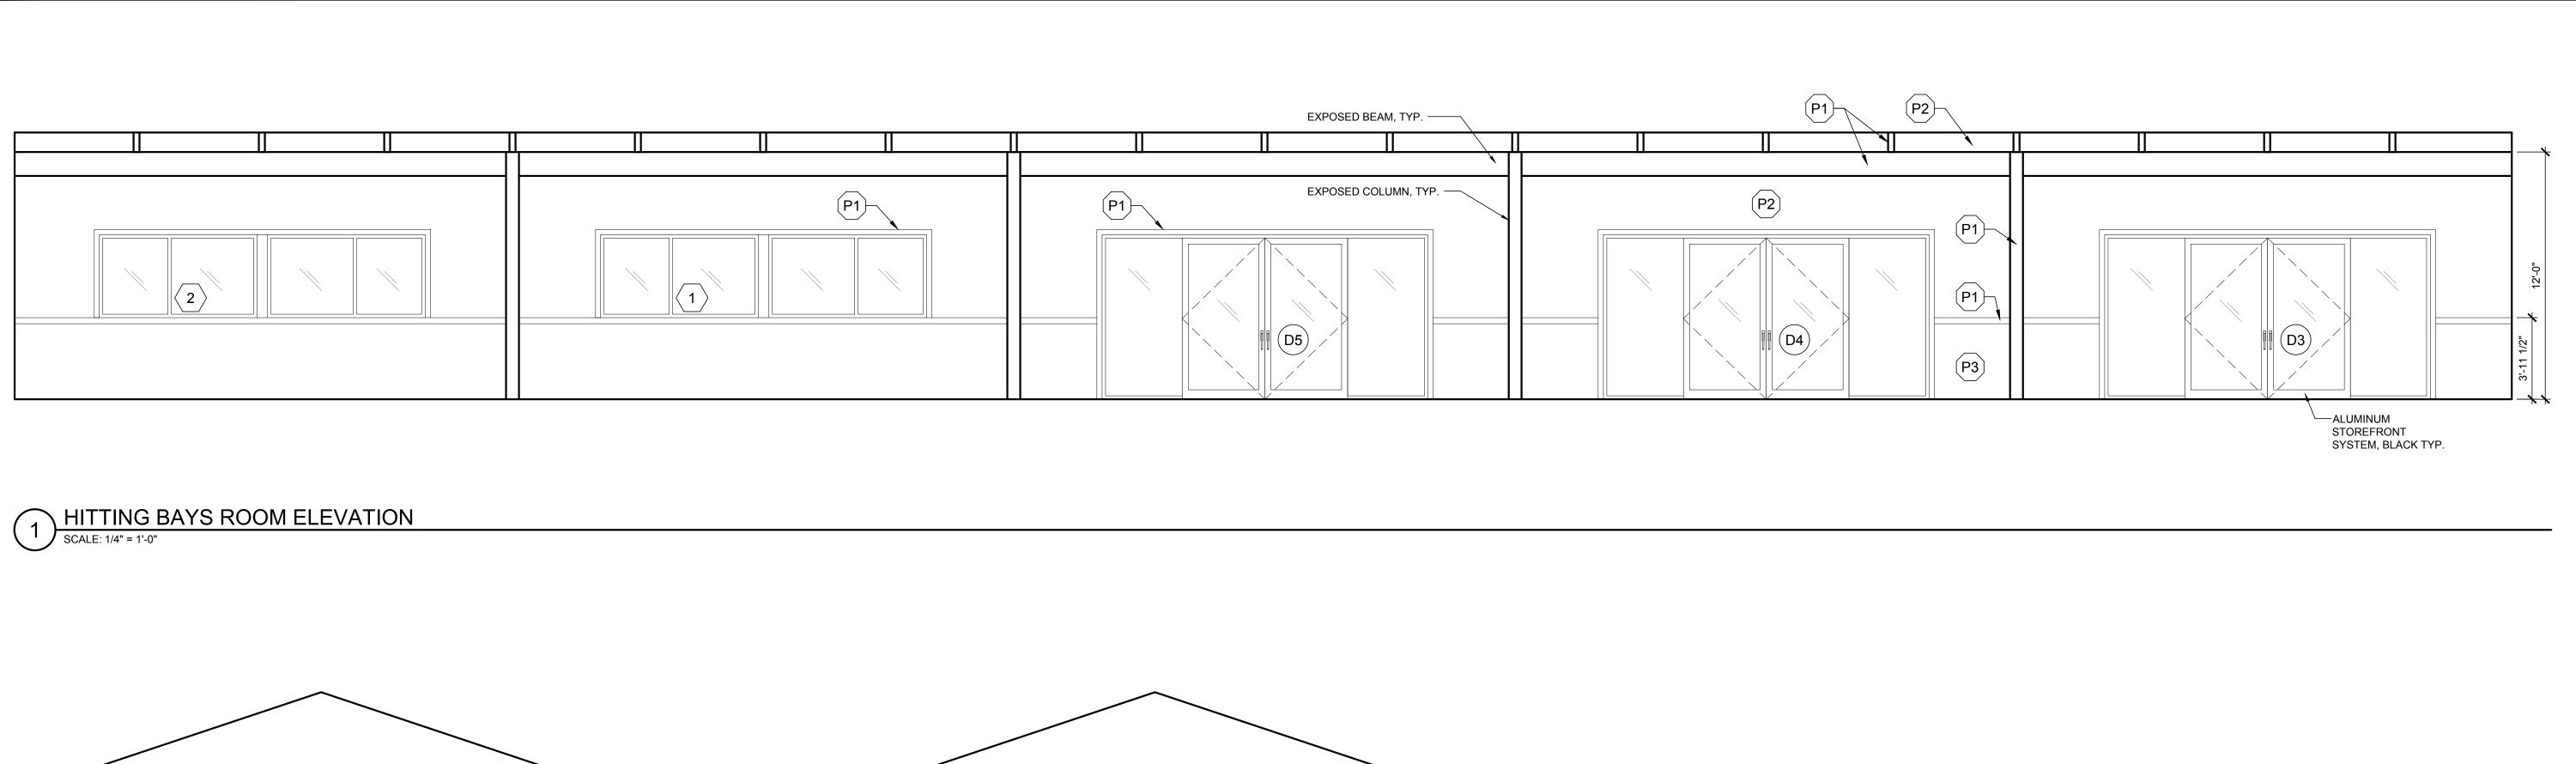


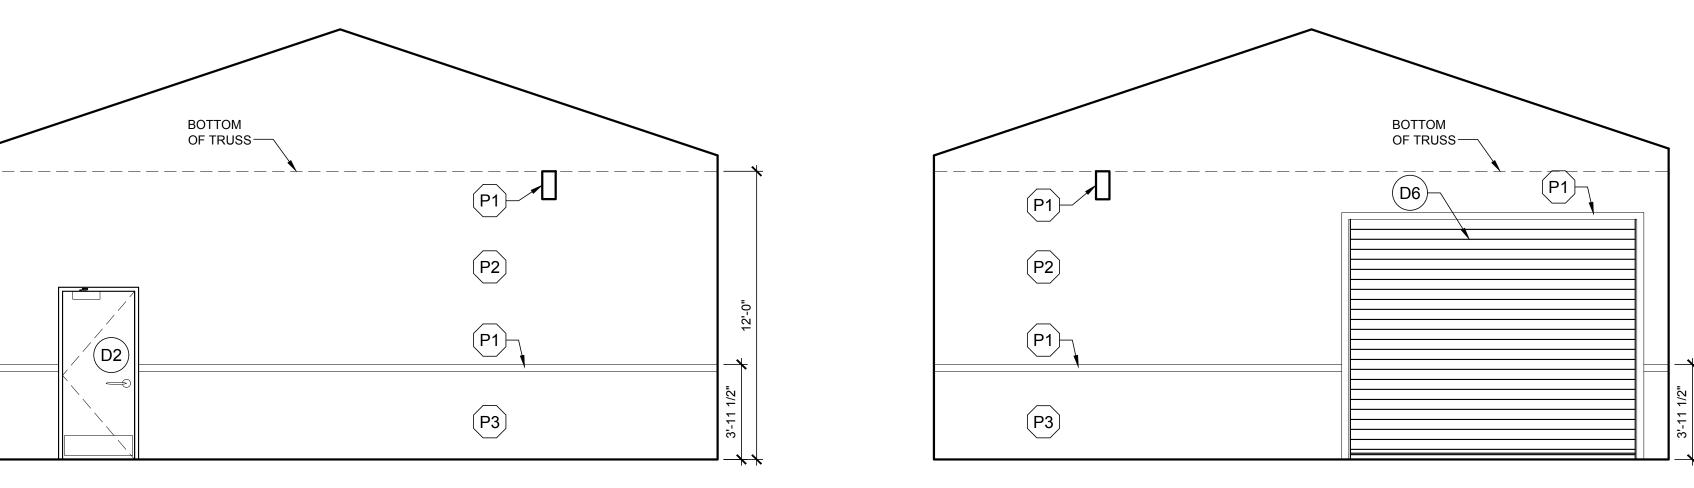



2 HITTING BAYS ROOM ELEVATION
SCALE: 1/4" = 1'-0"



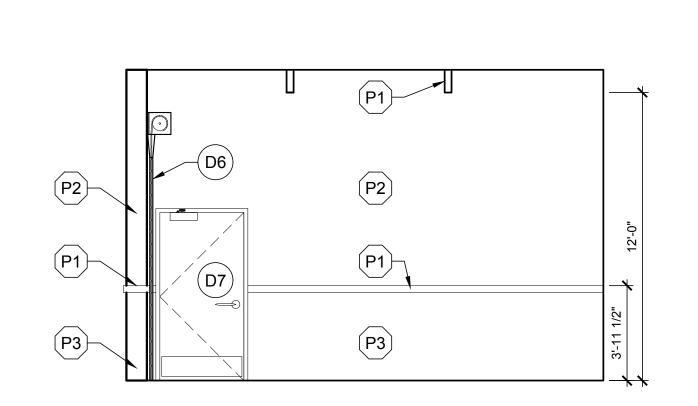

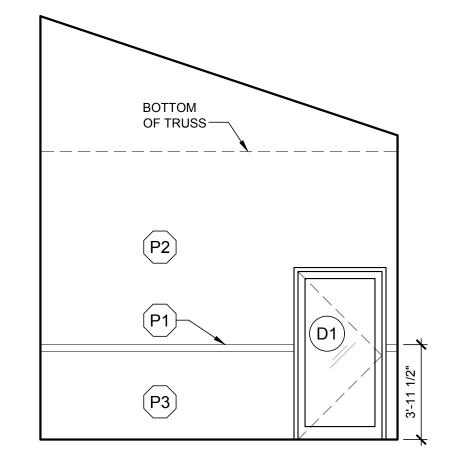

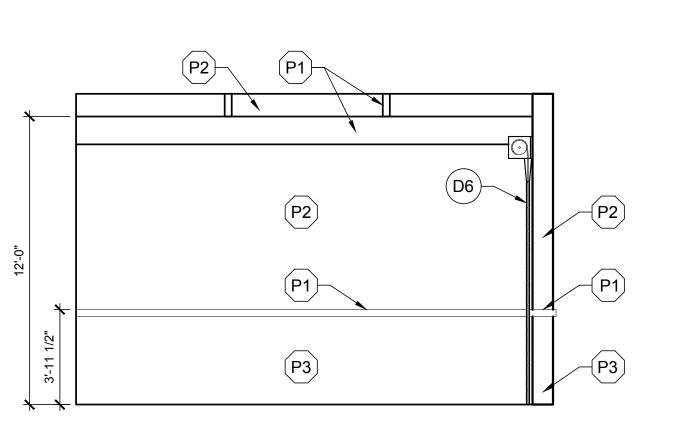

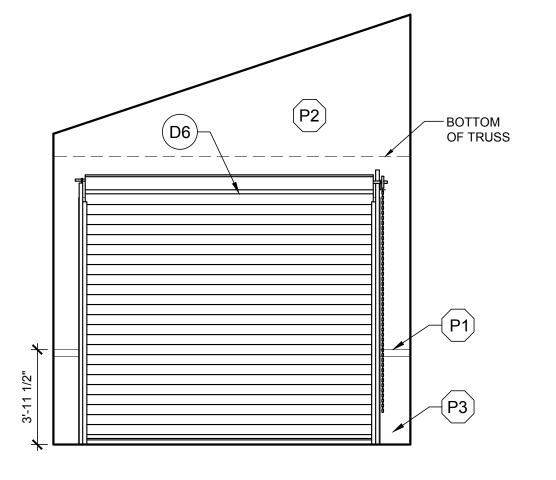

4 CASHIER ELEVATION

SCALE: 1/4" = 1'-0"

SCALE: 1/4" = 1'-0"

6 CASHIER ELEVATION

SCALE: 1/4" = 1'-0"


7 CASHIER ELEVATION


SCALE: 1/4" = 1'-0"

CREEK *0*3.19.2021 B


60169


INTERIOR ELEVATIONS

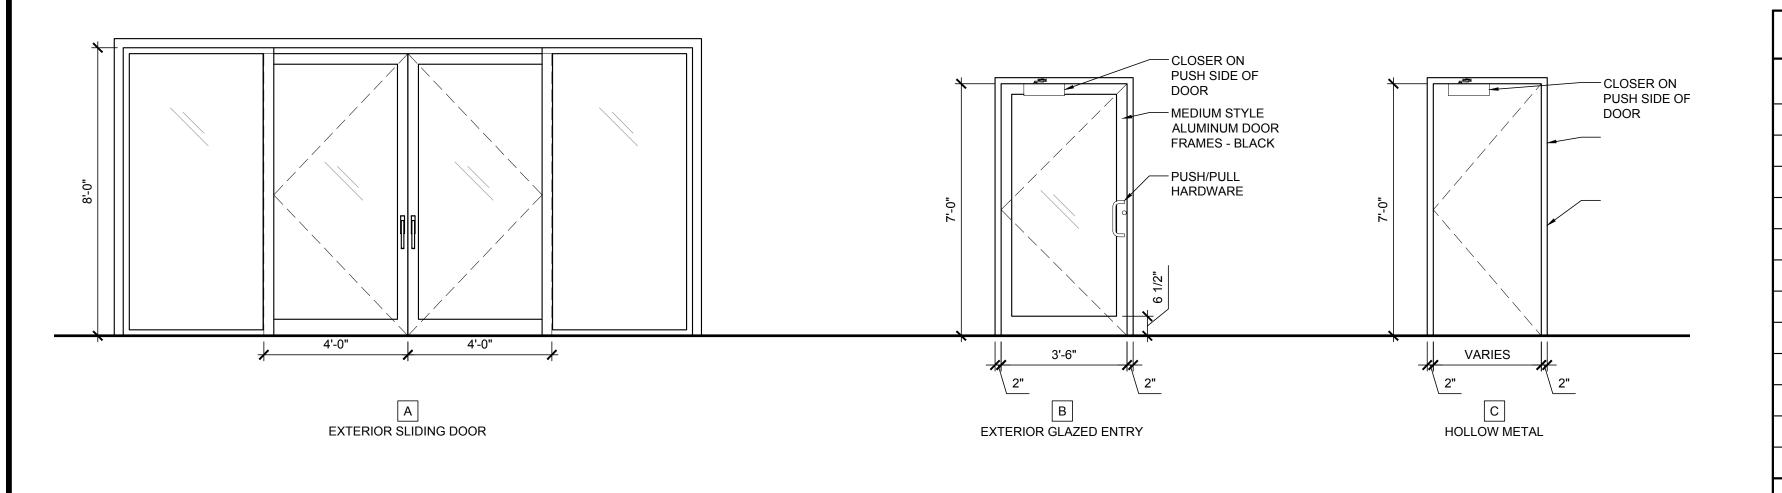

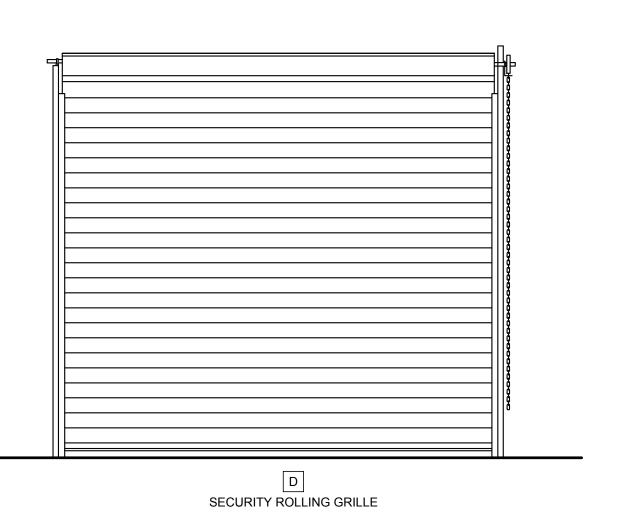

# DOOR ELEVATIONS SCALE: 3/8" = 1'-0"

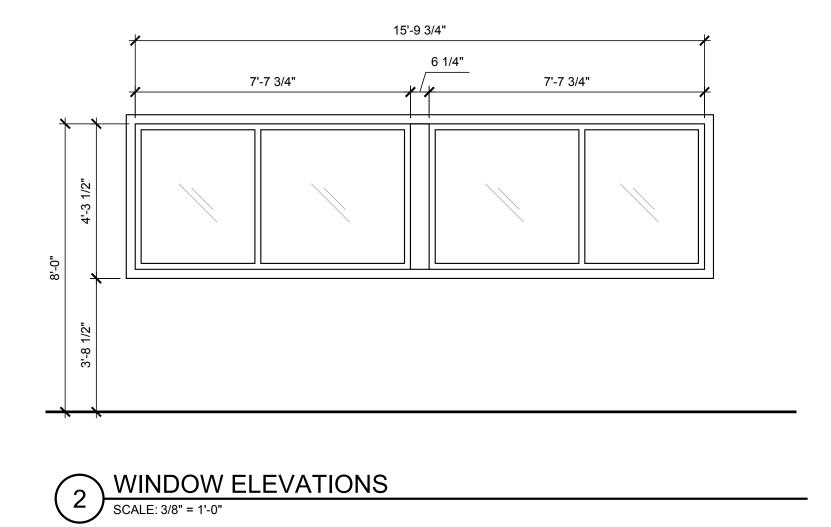

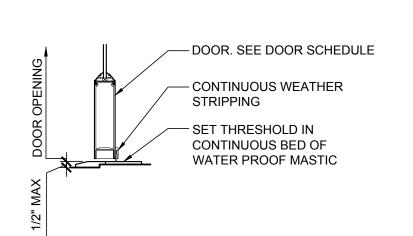

	DOOR SCHEDULE 🗴												
TAG	ROOM NAME	DOOR SIZE	FRAME SIZE	DOOR TYPE	MATERIAL DOOR / FRAME	THRESHOLD DETAIL	MANUFACTURER	HARDWARE	FIRE RATING	COMMENTS			
D1	CASHIER ENTRY	3'-6" x 7'-0"	3'-10" x7'-2"	В	CLAD WOOD	-	JELD-WEN	-	0-HOUR	SEE SPECIFICATIONS BELOW			
D2	HITTING BAY EXTERIOR	3'-0" x 7'-0"	3'-4" x7'-2"	С	H.M.	-	CURRIES OR EQUAL	-	0-HOUR	-			
D3	HITTING BAY SLIDER	(2) 4'-0" x 8'-0"	-	Α	CLAD WOOD	-	JELD-WEN	-	0-HOUR	SEE SPECIFICATIONS BELOW			
D4	HITTING BAY SLIDER	(2) 4'-0" x 8'-0"	-	Α	CLAD WOOD	-	JELD-WEN	-	0-HOUR	SEE SPECIFICATIONS BELOW			
D5	HITTING BAY SLIDER	(2) 4'-0" x 8'-0"	-	Α	CLAD WOOD	-	JELD-WEN	-	0-HOUR	SEE SPECIFICATIONS BELOW			
D6	CASHIER SECURITY	12'-0"W x 10'-0"T	-	D	STEEL	-	O.H. DOOR OR EQUAL	-	0-HOUR	-			
D7	MECHANICAL ROOM	4'-0" x 7'-0"	4'-4" x 7'-2"	С	H.M.	-	CURRIES OR EQUAL	-	0-HOUR	-			

- ALL DOORS ARE 1 3/4" THICK UNLESS NOTED OTHERWISE.
- ALL INTERIOR HOLLOW METAL FRAMES ARE 16 GA, WELDED TYPE.
- ALL CLOSERS AND HARDWARE TO BE US26D UNLESS NOTED OTHERWISE.
- ALL LOCKSETS TO BE KEYED SEPARATELY. ALL KEYWAYS TO BE STANDARD KEYWAYS.
- CONTRACTOR TO CONFIRM THAT ALL CYLINDERS WILL BE PROVIDED FROM ONE SOURCE.
- ALL CLOSERS AND LOCKSETS SHALL MEET ACCESSIBILITY REQUIREMENTS.
- ALL HINGES ON DOORS WITH CLOSERS TO BE OIL IMPREGNATED BEARING TYPE.
- ALL FRAMES TO RECIEVE STANDARD ANSI CURVED LIP STRIKE WITH ANSI WROUGHT STRIKE BOX WHERE
- REQUIRED. ALL CLOSERS TO BE SET FOR 110 DEGREE OPENING WHERE THE DOOR SWING WILL NOT BE IN CONFLICT
- WITH ADJACENT CONSTRUCTION. ALL MOUNTING SCREWS FOR CLOSERS, CLOSER ARMS, AND OPERATOR ARMS ON ALUMINUM DOORS
- SHALL BE SCREWED INTO "NUTSERTS". NUTSERTS TO BE STAINLESS STEEL TYPE. THE PRESCRIBED USE OF THE NUTSERTS PRODUCT IS SUBJECT TO NO EXCEPTION BEING TAKEN BY THE ALUMINUM DOOR MANUFACTURER / INSTALLER.
- EXTERIOR DOORS TO HAVE MAXIMUM 8.5 POUNDS PUSH/PULL OPENING FORCE.
- INTERIOR DOORS TO HAVE MAXIMUM 5 POUNDS PUSH/PULL OPENING FORCE.
- CONTRACTOR TO SUBMIT MANUFACTURER'S SPECIFICATIONS FOR DOOR HARDWARE. ALL DOOR HANDLES, PULLS, LATCHES, LOCKS, AND OTHER OPERATING DEVICES SHALL BE INSTALLED AT LEAST 34" BUT NOT MORE THAN 48" ABOVE FINISH FLOOR.
- THE OPERATING DEVICES SHALL BE CAPABLE OF OPERATION WITH ONE HAND AND SHALL NOT REQUIRE TIGHT GRASPING, TIGHT PINCHING, OR TWISTING OF WRIST TO OPERATE.
- EGRESS DOORS SHALL OPEN READILY FROM THE EGRESS SIDE WITHOUT THE USE OF A KEY OR SPECIAL KNOWLEDGE OR EFFORT.
- THE USE OF MACHINE SCREWS FOR CONTINUOUS HINGE ANCHORAGE IS REQUIRED. PROVIDE ADDITIONAL REINFORCING FOR THE HINGES IN THE FRAMES AND DOOR STILES.
- FOR ALUMINUM DOOR WITH TUBULAR PULLS, AN OFFSET FROM THE CENTER OF THE STILE IS REQUIRED TO PREVENT A CONFLICT WITH THE LOCK CYLINDER. THE PULLS TO BE OFFSET TO THE LITE SIDE OF THE STILE. ALL PULLS TO BE INSTALLED WITH THIS OFFSET, EVEN WITHOUT A CYLINDER ON THE STILE.

• CONTRACTOR TO REVIEW ALL DOOR ACTUATOR LOCATIONS WITH THE OWNER PRIOR TO INSTALLING BACK

 THE HARDWARE INSTALLER TO CONFIRM THAT ALL CLOSERS HAVE THE BACKCHECK VALVE SCREWED IN, FOR PARALLEL ARM INSTALLATIONS.

#### ADDITIONAL DOOR SPECIFICATIONS

SLIDING DOORS (INCLUDES THEIR WINDOWS ON SIDES) JELD-WEN SITELINE CLAD SLIDING PATIO DOOR, AURALAST

- STATIONARY-O / LEFT-X, / PASSIVE, / STATIONARY, NARROW
- STILE, STANDARD SILL
- BLACK SILL BLACK EXTERIOR
- CLEAR PANEL/FRAME BLACK INTERIOR
- NAIL FIN (STANDARD), COLOR MATCH METAL DRIP CAP, INSULATED TEMPERED GLASS, PROTECTIVE FILM, BLACK
- SPACER NO SCREEN
- SILL HEIGHT TO MEET ADA REQUIREMENTS

#### GLAZED ENTRY DOOR

- JELD-WEN SITELINE CLAD AURALAST PINE, OUTSWING DOOR PRODUCT, (SINGLE-SWING) SINGLE PANEL DOOR
- 4 5/8" STILE, 10" BOTTOM RAIL, BLACK EXTERIOR,
- CLEAR FRAME
- BLACK INTERIOR
- NAIL FIN (STANDARD), COLOR MATCH METAL DRIP CAP, STANDARD SILL, BLACK SILL,
- INSULATED TEMPERED GLASS, PROTECTIVE FILM, BLACK
- DOOR CLOSER
- SILL HEIGHT TO MEET ADA REQUIREMENTS

	WINDOW SCHEDULE ®												
MARK	DIMENSION (W x H)	MANUFACTURER AND MODEL	MULLION SIZE	FRAME	FINISH	JAMB	REMARKS						
1	15'-9 3/4" X 4'-3 1/2"	JELD-WEN, SITELINE	-	-	-	-	SEE SPECIFICATIONS BELOW						
2	15'-9 3/4" X 4'-3 1/2"	JELD-WEN, SITELINE	-	-	-	-	SEE SPECIFICATIONS BELOW						

## **GENERAL NOTES:**

- CONTRACTOR TO FIELD MEASURE ALL WINDOW LOCATIONS BEFORE ORDERING
- JELD-WEN (WINDOW MANUFACTURER) TO VERIFY SYSTEMS ORDERED ARE ADEQUATE FOR APPLICATIONS SHOWN
- WINDOWS (SMALLER FIXED WINDOWS)
- JELD-WEN SITELINE FIXED WINDOWS, STANDARD, CLAD MULL AURALAST PINE, CASEMENT/AWNING PRODUCT BLACK EXTERIOR
- BLACK INTERIOR
- NAIL FIN (STANDARD), COLOR MATCH METAL DRIP CAP
- INSULATED ANNEALED GLASS, PROTECTIVE FILM, BLACK SPACER

	INTERIOR FINISH LEGEND (×)											
TAG	ITEM DESCRIPTION	MANUFACTURER	PRODUCT NUMBER / COLOR	SIZE / SPECS	GROUT	COMMENTS						
FF1	CONCRETE FLOOR FINISH	-	-	-	<del>-</del>	DRY SHAKE ON FRESH CONCRETE, 1.0 PSF						
P1	PAINT	SHERWIN WILLIAMS	BLACK - EXACT COLOR TBD BY OWNER	-	-	TRUSSES, TRIM, H.M. DOORS						
P2	PAINT	PRE-FAB BUILDING MFR	IVORY - EXACT COLOR TBD BY OWNER	-	-	GENERAL INTERIOR - UPPER 1/2 OF WALLS, UNDERSIDE OF ROOF DECK						
P3	PAINT	PRE-FAB BUILDING MFR	TAN - EXACT COLOR TBD BY OWNER	-	-	GENERAL INTERIOR - LOWER 1/2 OF WALLS						

*0*3.19.2021 E

SCHEDULES AND **ELEVATIONS** 

				INFRARE	D HEATER (IN	IDIRECT FIR	ED GAS)	SCHEDULE			
EQUIPMENT NUMBER	DESCRIPTION	LOCATION / AREA SERVED	NG INLET PRESSURE (W.C.)	INPUT (MBH)	OUTPUT TOTAL(MBH)	FAN MOTOR  MOTOR (V/Ph/Hz)	MOUNTING HEIGHT (FT)	COMBUSTION TUBE LENGTH (FT)	WEIGHT INCL. MOTOR (LB)	BASE OF DESIGN	REMARKS
IRH-1-7	GAS FIRED INFRARED HEATER	RANGE	5-12"	40	40	120/1/60	10'-6"	12'	72#	ROBERTS GORDON MODEL HEV-40	1 THRU 8
IRH-8-17	GAS FIRED INFRARED HEATER	RANGE	5-12"	100	100	120/160	<mark>10'-6</mark> "	17'-U	160#	ROBERTS GORDON MODEL HEV-100	1 THRU 8

1) ALL TUBING SHALL BE HEAT TREATED ALUMINIZED STEEL AS SHOWN ON PLAN NO SWAGGED TUBES ALLOWED

2) REFLECTORS SHALL COVER ALL TUBING WITHOUT ANY GAPS FOR SUSPENSION POINTS, ALL JOINTS SHALL BE TERMINATED WITH END CAPS

3) UNITS ARE DIRECT VENTED TO ATMOSPHERE -M.C TO PROVIDE VENT CAP AT END OF UNIT 4) EQUIPMENT SUPPLIER SHALL PROVIDE S.STEEL GAS LINE FLEX -36" W/ SHUT OFF VALVE


5) EQUIPMENT PROVIDER SHALL PROVIDE EQUIPMENT TRAINING AND START-UP 6) EQUIPMENT PROVIDER TO SUPPLY SPRING WOUND TIMER - TIMER MUST BE MIN OF 30 MIN


7) E.C TO RECEPTACLE FOR EACH IR HEATER TO PLUG INTO 8) E.C TO PROVIDE A SERVICE AT EVERY BURNER

CONTACT MIDWEST ENVIRONMENTAL SALES -847-290-8888 OR GANDROS@MIDWEST-ENVIRONMENTAL.COM

### MECHANICAL NOTES

- PROVIDE A GAS SHUT-OFF VALVE, UNION, AND MIN. 6" DIRT LEG AT ALL HEATING UNITS.
- 2. THE MECHANICAL CONTRACTOR SHALL INSTALL ALL GAS PIPING SHOWN ON THIS PLAN. GAS PIPING SHALL BE SCHEDULE 40 BLACK STEEL, ASTM A53 MALLEABLE IRON OR FORGED STEEL WELDING TYPE. ALL GAS PIPING SHALL BE INSTALLED PER A.G.A. REQUIREMENTS.
- 3. ALL GAS PIPING EXPOSED TO THE OUTDOORS SHALL BE CLEANED AND PAINTED BLACK FOR CORROSION PROTECTION PER IMC 1303.21

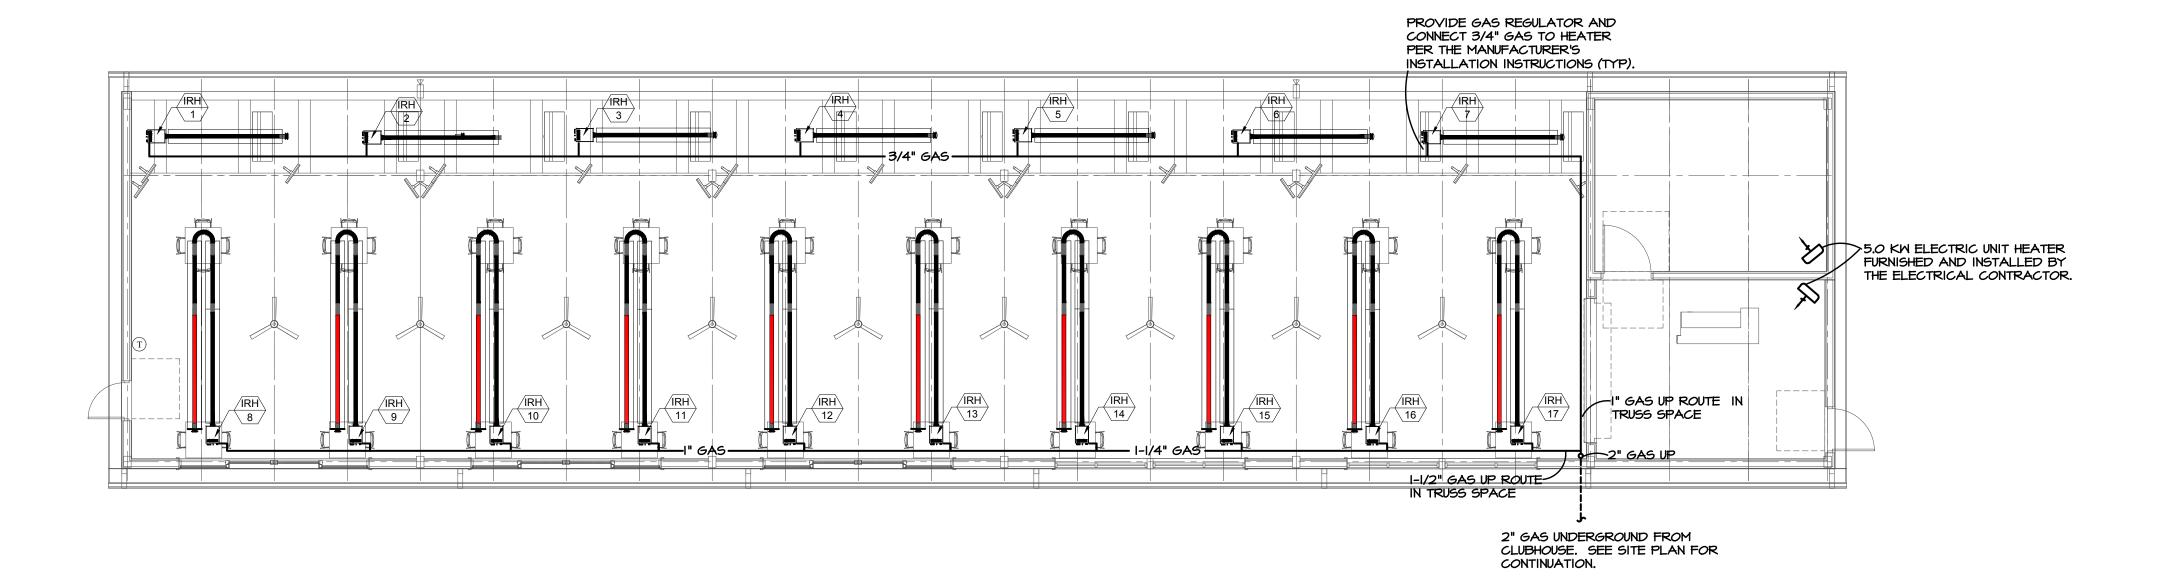

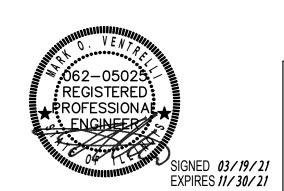



WT GROUP
Structural | Mechanical/Electrical/Plumbing Civil | Land Survey | Telecommunication| Aquatic
Accessibility Consulting | Design & Program Management
Engineering with Precision, Pace & Passion. 2675 Pratum Avenue | Hoffman Estates, IL 60192 P: 224.293.6333 | F: 224.293.6444 wtengineering.com IL License No: 184.007570-0015 | Exp: 04.30.2021 © COPYRIGHT 2021 THE W-T GROUP, LLC

DRIVE


60169

1400


03.19.2021 BID

MECHANICAL PLAN

revision 3: revision 4:

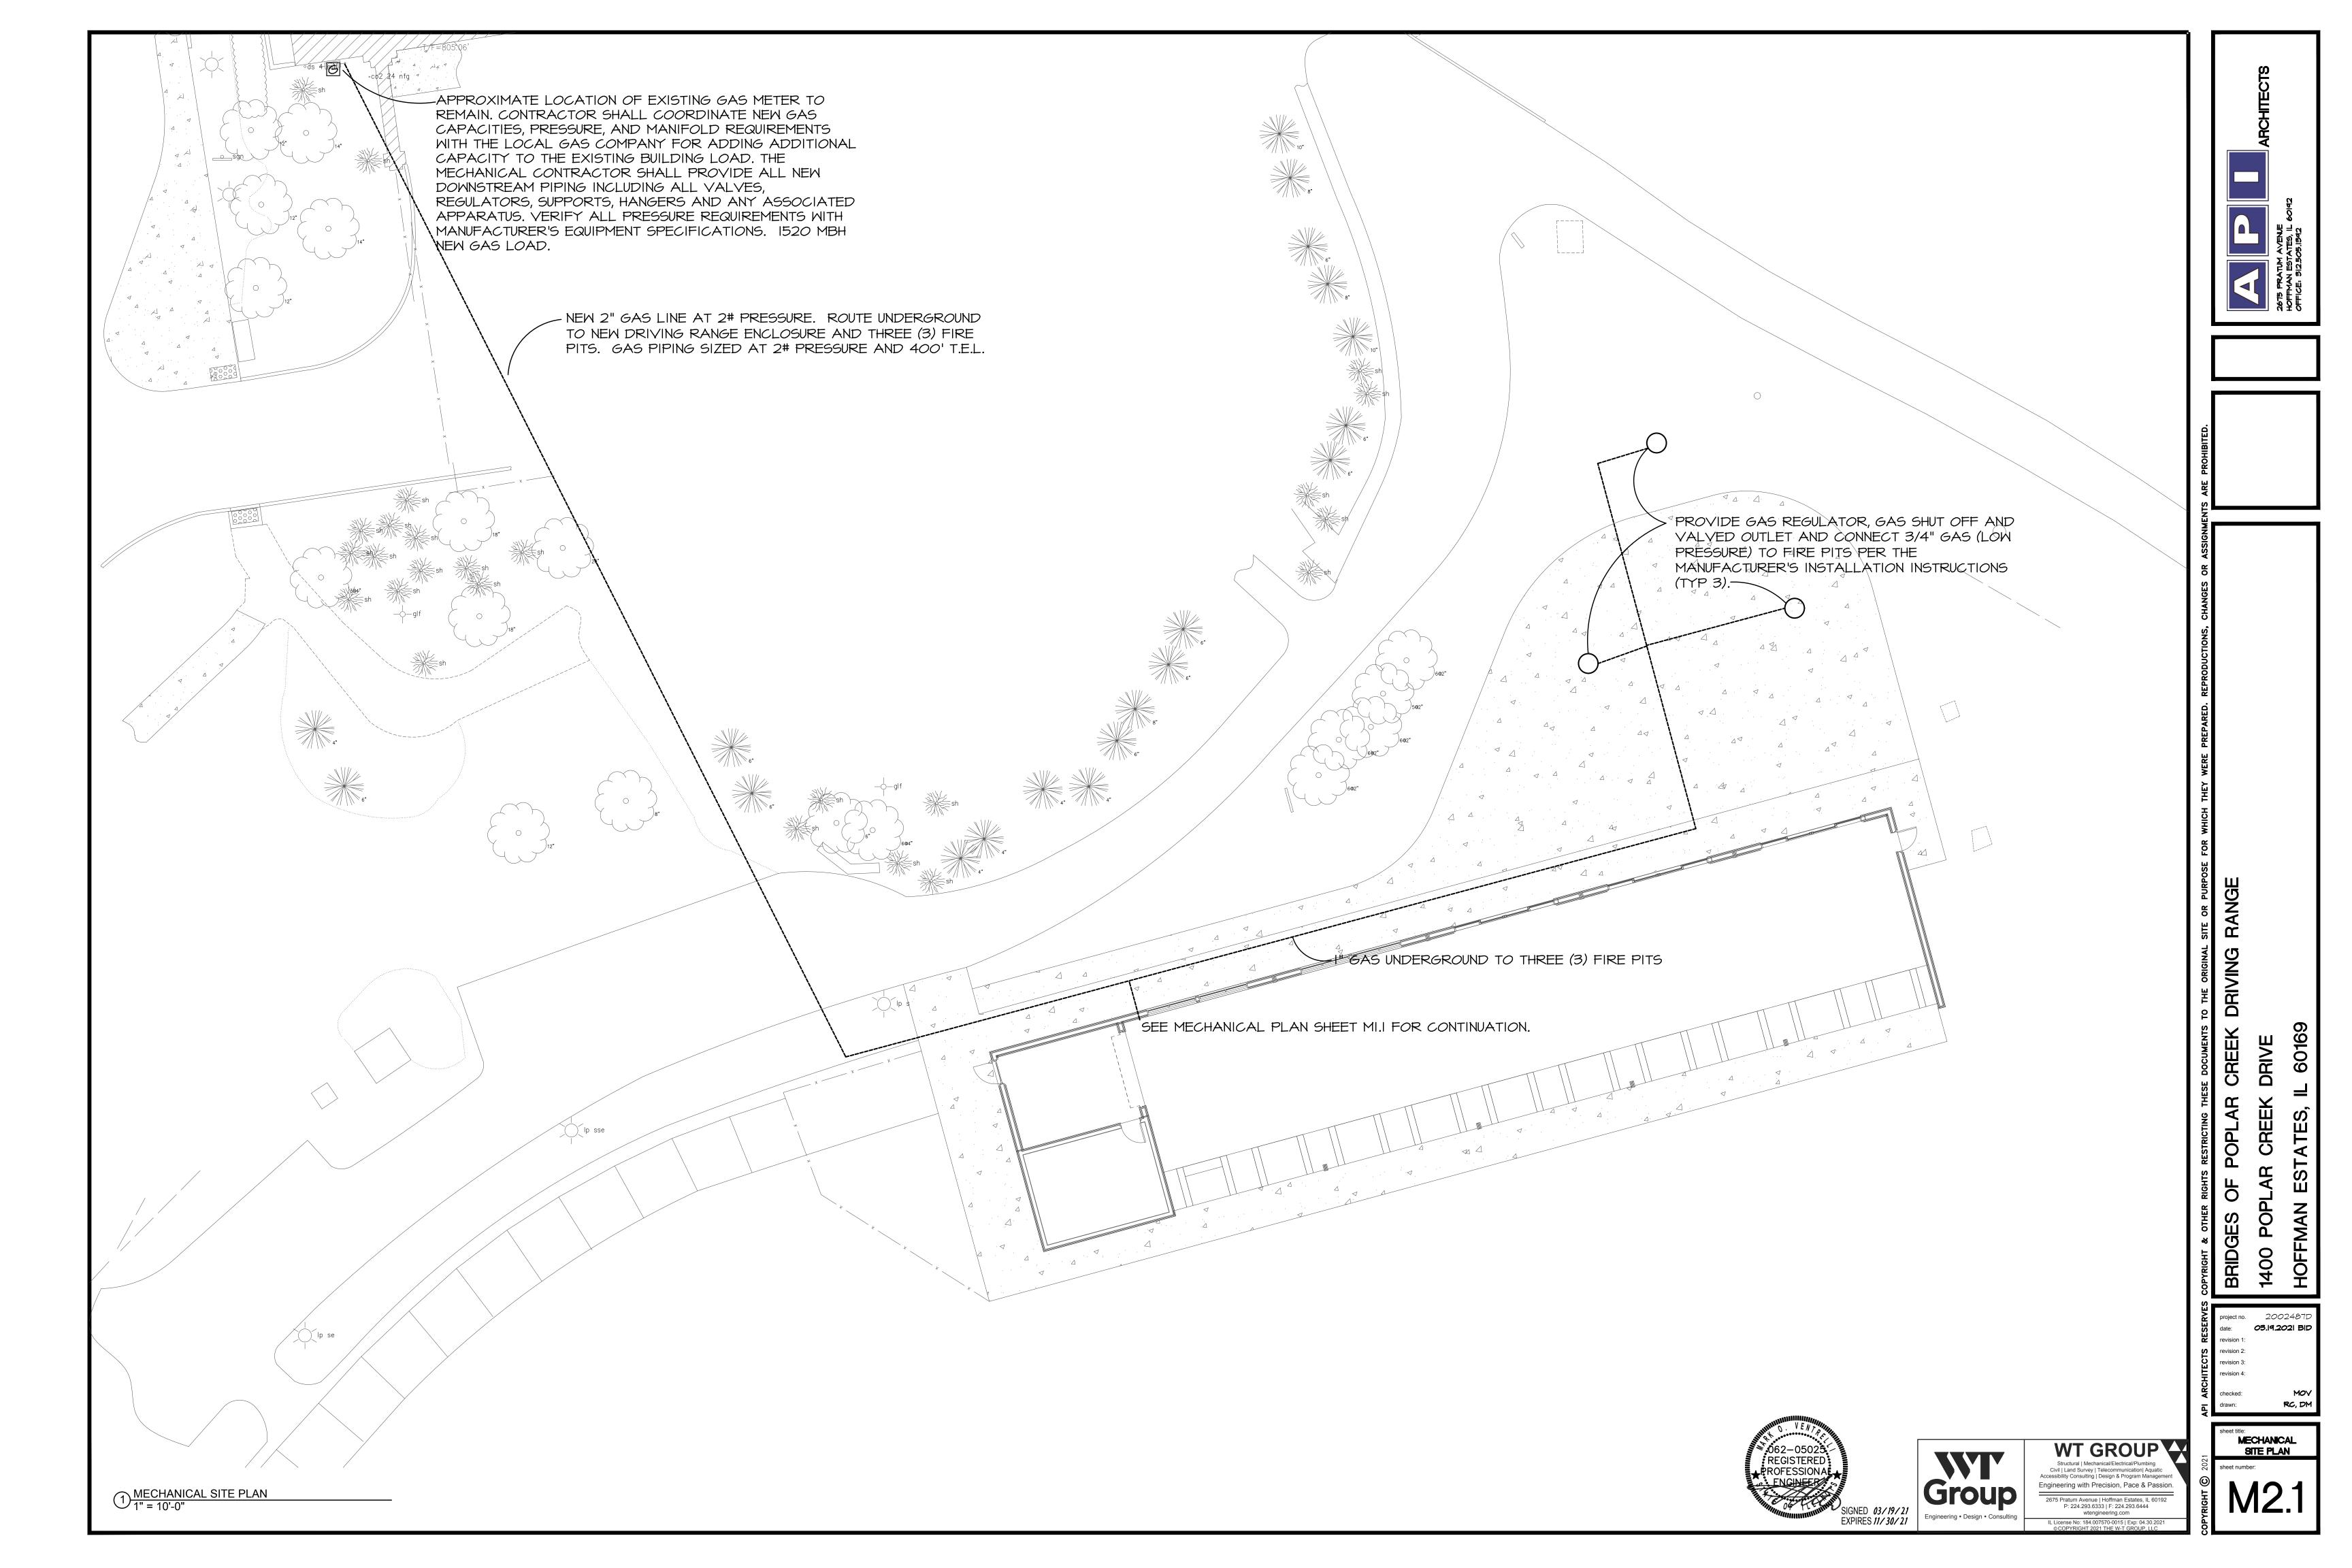

# GAS CONNECTION Shut-Off Valve ---

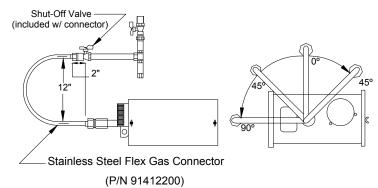


Gas pipe work must be installed and tested in accordance with United States ANSIZ223.1/NFPA54 latest addition and Canada-CNA/CSA-B149.1 and B149.2

a) Install the flex gas connector as shown. The flex gas connector accommodates expansion of the heating system and allows for easy installation and service of the burner. b) Shut-Off Valve must be parallel to burner inlet. The 2" (5cm) displacement shown is for the cold condition. This displacement may reduce when the

system is fired.

# HORIZONTAL VENTING CONFIGURATIONS

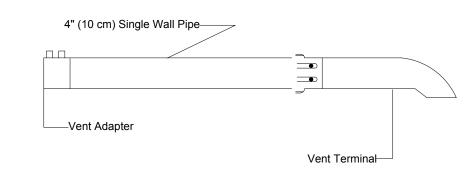

manufacturer's instructions for proper installation.
c) 4" (10 cm) O.D. vent pipe, maximum 45 ft.(13.7m) in length may be used as shown above with an approved vent cap. NOTE: Condensate may develop when long vent pipes are used. It is recommended that the pipe length should be less d) When heater extension packages are used they directly effect maximum vent length. Refer to Installation, Operation and Service Manual for requirements. e) Vent terminal must be installed at a height sufficient to prevent blockage by snow. Building materials must be protected from degradation by vent gases.


a) Refer to Installation, Operation and Service Manual for proper design.

b) In combustible or noncombustble walls, use insulated vent terminal. Follow vent

A CAUTION


Hold gas line securely with pipe wrench when attaching the flex gas connector.

Failure to follow these instructions will result in property damage.

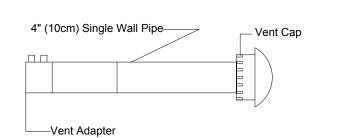


# WARNING Electrical Shock Hazard Disconnect electrical power before servicing. Replace door before operating.


#### LOW VOLTAGE TIMER WIRING

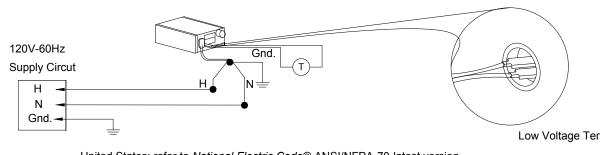



United States: refer to National Electric Code® ANSI/NFPA-70-latest version Canada: refer to Canadian Electric Code® CSA C22.1 Part I-latest version.

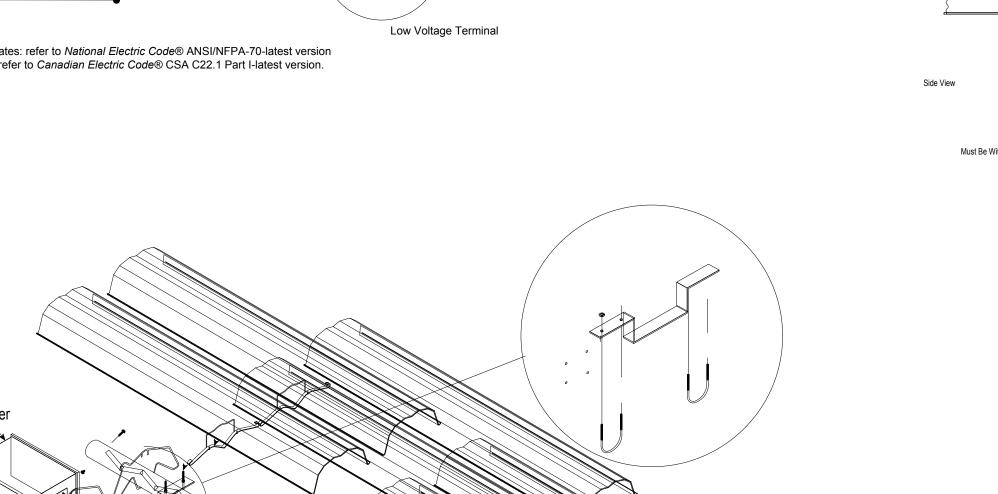

Failure to follow these instructions will result in death or electrical shock.

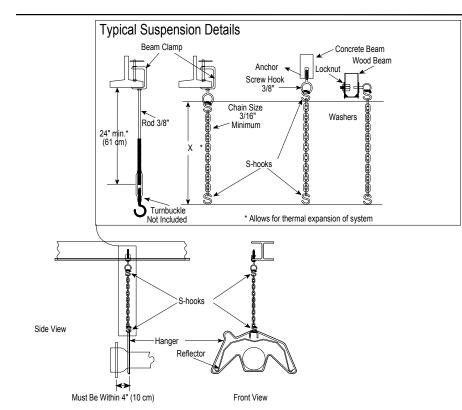

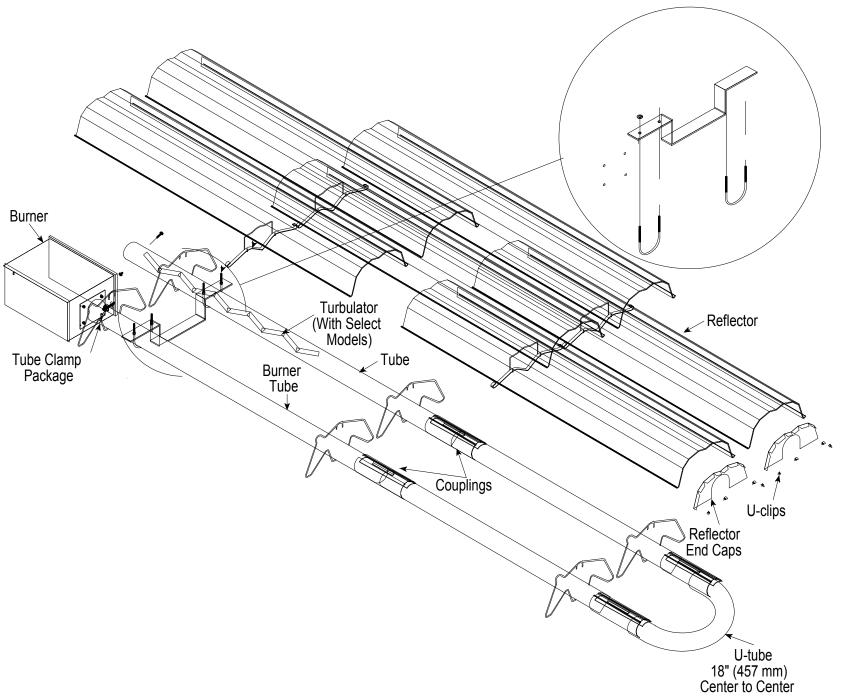

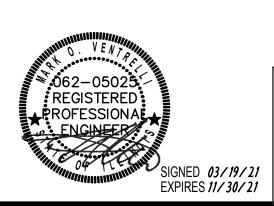






60169 DRIVE

03.19.2021 BID

MECHANICAL DETAILS

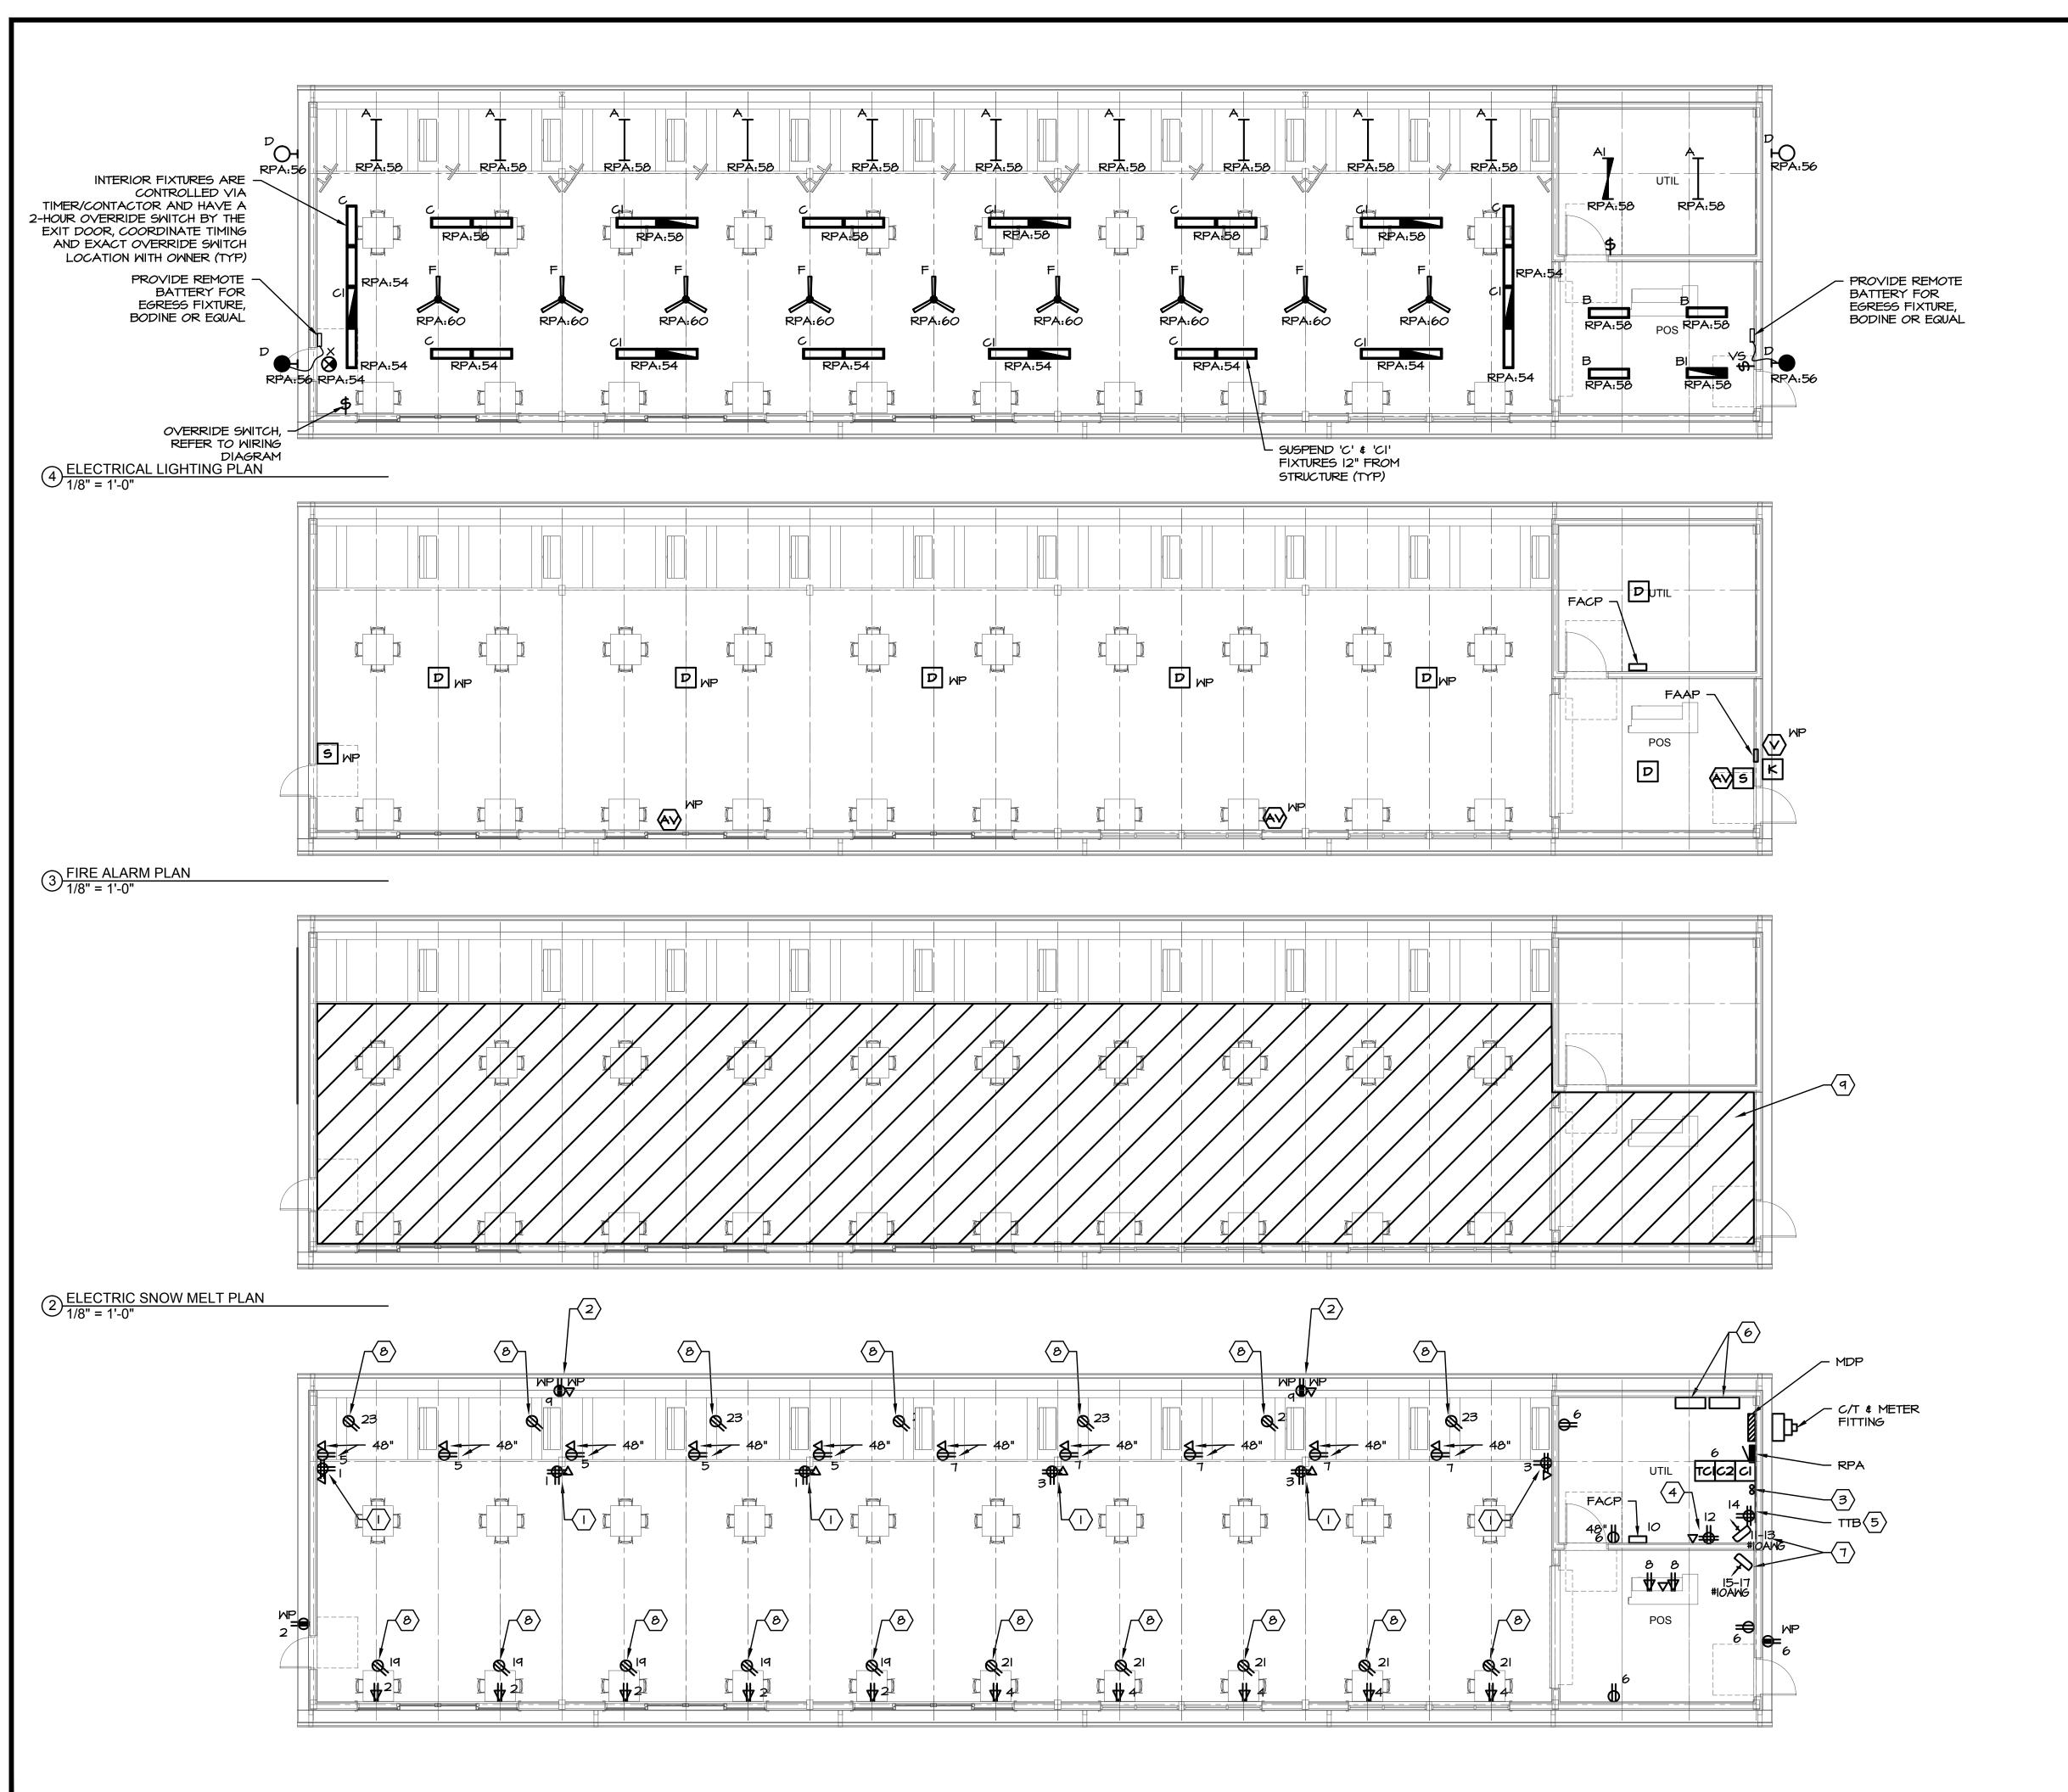

**GENERAL NOTES** 

I. ALL LOW VOLTAGE WIRING (DATA, VOICE, TV, FIRE ALARM, SECURITY, DOOR ACCESS, ALERTING, ETC) AREA SHALL BE PIPED IN FULL EMT CONDUIT. EXPOSED WIRING IS NOT ACCEPTABLE

## **\*** KEYED NOTES

- I. POWER AND DATA OUTLET FOR TV DISPLAY. VERIFY EXACT MOUNTING HEIGHT IN FIELD.
- 2. POWER AND DATA OUTLETS FOR GOLF BALL TRACKING SENSOR. VERIFY EXACT LOCATION AND HEIGHT IN FIELD.
- 3. INCOMING COMMUNICATION CONDUITS FROM EXISTING CLUBHOUSE. REFERENCE SITE ELECTRICAL PLAN, SHEET SEI.I FOR EXACT SPECIFICATION AND ROUTING.
- 4. POWER AND DATA FOR TOPTRACER RANGE SERVER, VERIFY FINAL LOCATION
- 5. PROVIDE 4'W  $\times$  8'H 3/4" FIRE-RATED (OR PAINTED WITH A MINIMUM OF THREE (3) COATS FIRE RETARDANT PAINT) A-C GRADE VOID FREE PLYWOOD SHEETING. THE PLYWOOD SHALL BE MOUNTED SUCH THAT THE TOP OF THE PLYWOOD IS 8' 6" AFF AND THE BOTTOM EDGE OF THE PLYWOOD IS 6" AFF.
- 6. SNOW MELT CONTROL PANEL. PANEL FURNISHED BY SNOW MELT MANUFACTURER, INSTALLED BY EC. ELECTRICAL FEEDER TO EACH PANEL BY EC. SNOW MELTING DISTRIBUTION PANEL (200-AMP, 120/208V, 3 PHASE FEED) MANUFACTURED BY PENTAIR OR EQUAL UTILIZING SHEATHED MI HEATING CABLE. SEE INSTALLATION DETAILS ON E2.4.
- 7. ELECTRICAL UNIT HEATER 5.0 KW, 208V, SINGLE PHASE WITH BUILD IN THERMOSTAT AND DISCONNECT SWITCH. MARKEL #F2F5105N-CAI-T5100-DCS202/510-A5105.
- 8. POWER FOR INFRARED RADIANT HEAT BURNER. PROVIDE CEILING MOUNTED DUPLEX RECEPTACLE. CORONATE LOCATION WITH MECHANICAL CONTRACTOR.
- 9. PROVIDE ELECTRIC SNOW MELT SYSTEM (APPROX 3,200 SQ. FT.) AT 35-WATTS / SQ. FT. SEE SHEET E2.4 FOR ADDITIONAL INFORMATION. SNOW MELTING DISTRIBUTION PANELS LOCATION IN UTILITY ROOM (SEE KEYED NOTE #6); SEE THIS SHEET. PROVIDE ALL NECESSARY IN-GRADE QUAZITE JUNCTION BOXES AND ROOF MOUNTED SNOW MELTING SYSTEM AERIAL SENSOR; WIRE BACK TO CONTROLLER (3#18 AWG) IN DEDICATED CONDUIT.


REGISTERED

PROFESSIONA

ENGINEER

SIGNED 03/19/21

EXPIRES 11/30/21

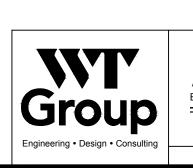

Structural | Mechanical/Electrical/Plumbing
Civil | Land Survey | Telecommunication| Aquatic
Accessibility Consulting | Design & Program Management
Engineering with Precision, Pace & Passion.

2675 Pratum Avenue | Hoffman Estates, IL 60192
P: 224.293.6333 | F: 224.293.6444
wtengineering.com

IL License No: 184.007570-0015 | Exp: 04.30.2021

ARCHITECTS
A AVENUE
STATES, IL 60192
S505.1392

REEK DRIVING RANGE

OPLAR CREEK DRIVE
IAN ESTATES, IL 60169

project no. 2002487E
date: 03.19.2021 BIE
revision 1:
revision 2:
revision 3:
revision 4:

sheet title:


ELECTRICAL PLANS


sheet number:

1 1 1


	400	_AMP	BUS			DIGT		MAIN	<u>400A/3P M.C.B.</u> MAIN BREAKER N PANEL
120	<u> / 208</u>	.V, <u>3</u>	_ PHA	SE, <u>4</u>			KIL "		
CKT	POLE	TRIP	KVA	WIRE	GND	COND	HP	AMPS	DESCRIPTION
I	3	200	57.50	4#3/0	#6	2-1/2"		159.0	SNOW MELT SYSTEM
2	3	200	57.50	4#3/0	#6	2-1/2"		159.0	SNOW MELT SYSTEM
3	3	200	-	4#3/0	#6	2-1/2"		-	PANEL RPA
4	3	60	-	4#6	#6	I"			TVSS (SURGE PROTECTION DEVICE)
5	3								BUSSED SPACE
6	3								BUSSED SPACE
7	3								BUSSED SPACE
8	3								BUSSED SPACE
ТОТ	TOTAL CONNECTED LOAD								TOTAL CONNECTED AMPS


PAN	NEL			<b>.</b>	120/20		304W		
AMI	PS		225 MAIN		M.L.O	A.I.C	10,000		
LO	CATI	ON	UTILITY ROOM			MOUNTING	SURFACE		
CIRCUIT	POLE	TRIP	DESCRIPTION	KVA	KVA	DESCRIPTION	TRIP	POLE	CIRCUIT
<b>*</b> 1	ı	20	TV DISPLAYS	1.08	1.08	GENERAL OUTLETS	20	)	2
<b>*</b> 3	ı	20	TV DISPLAYS	1.08	1.08	GENERAL OUTLETS	20	)	4
<b>*</b> 5	1	20	GOLF DISPLAY	0.50	0.90	GENERAL OUTLETS	20	)	6
<b>*</b> 7	ı	20	GOLF DISPLAY	0.50	0.36	RECEPTION OUTLETS	20	)	8
9	ı	20	GOLF TRACKING SENSORS	0.20	0.20	FACP	20	)	10
11	2		ELECTRIC UNIT HEATER - UTILITY RM	5.00	1.00	GOLF SERVER	20	)	12
13		30			0.36	ттв	20	)	14
15	2		ELECTRIC UNIT HEATER - LOBBY RM	5.00		SPARE	20	)	16
17		30				SPARE	20	)	18
19	1	20	RADIANT HEATERS	0.50		SPARE	20	)	20
21	ı	20	RADIANT HEATERS	0.50		SPARE	20	)	22
23	1	20	RADIANT HEATERS	0.70		SPARE	20	)	24
25	ı	20	FIRE PIT POWER	0.20		SPARE	20	)	26
27	1	20	SPARE			SPARE	20	)	28
29	1	20	SPARE			SPARE	20	)	30
31	ı	20	SPARE			SPARE	20	)	32
33	1	20	SPARE			SPARE	20	)	34
35	1	20	SPARE			SPARE	20	)	36
37	ı	20	SPARE			SPARE	20	)	38
39	1	20	SPARE			SPARE	20	)	40
41	ı	20	SPARE			SPARE	20		42
43	ı	20	SPARE		13.00	SITE LIGHTING		2	
45	1	20	SPARE				60		46
47	ı	20	SPARE		13.00	SITE LIGHTING		2	48
49	1	20	SPARE				60		50
51	1	20	SPARE		0.25	PHOTOCELL/TIMER	20	)	52
53	1	20	SPARE		1.10	INTERIOR LIGHTING	20		54
55	1	20	SPARE		0.58	EXTERIOR LIGHTING	20		56
57		20	SPARE		1.10	INTERIOR LIGHTING	20		58
59	1	20	SPARE		0.27	INTERIOR PADDLE FANS	20		60
* INDI	ICAT	ES G	FCI C/B TOTAL	= 15.26	34.28	= TOTAL TOTAL KVA = 49.54	OTAL AMPS	=	137.6

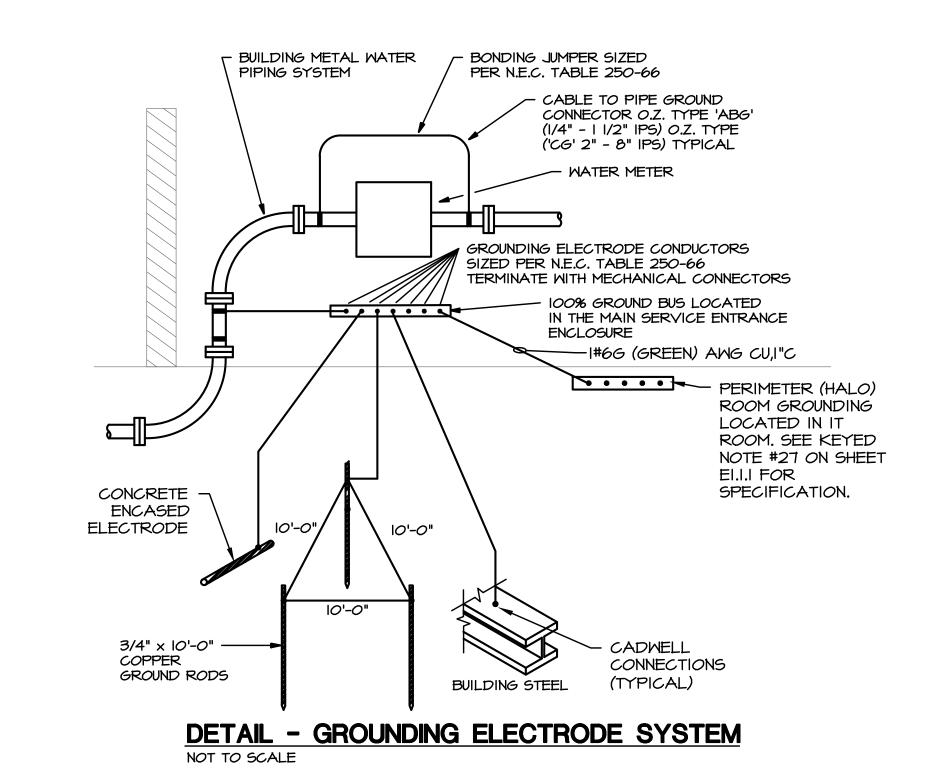

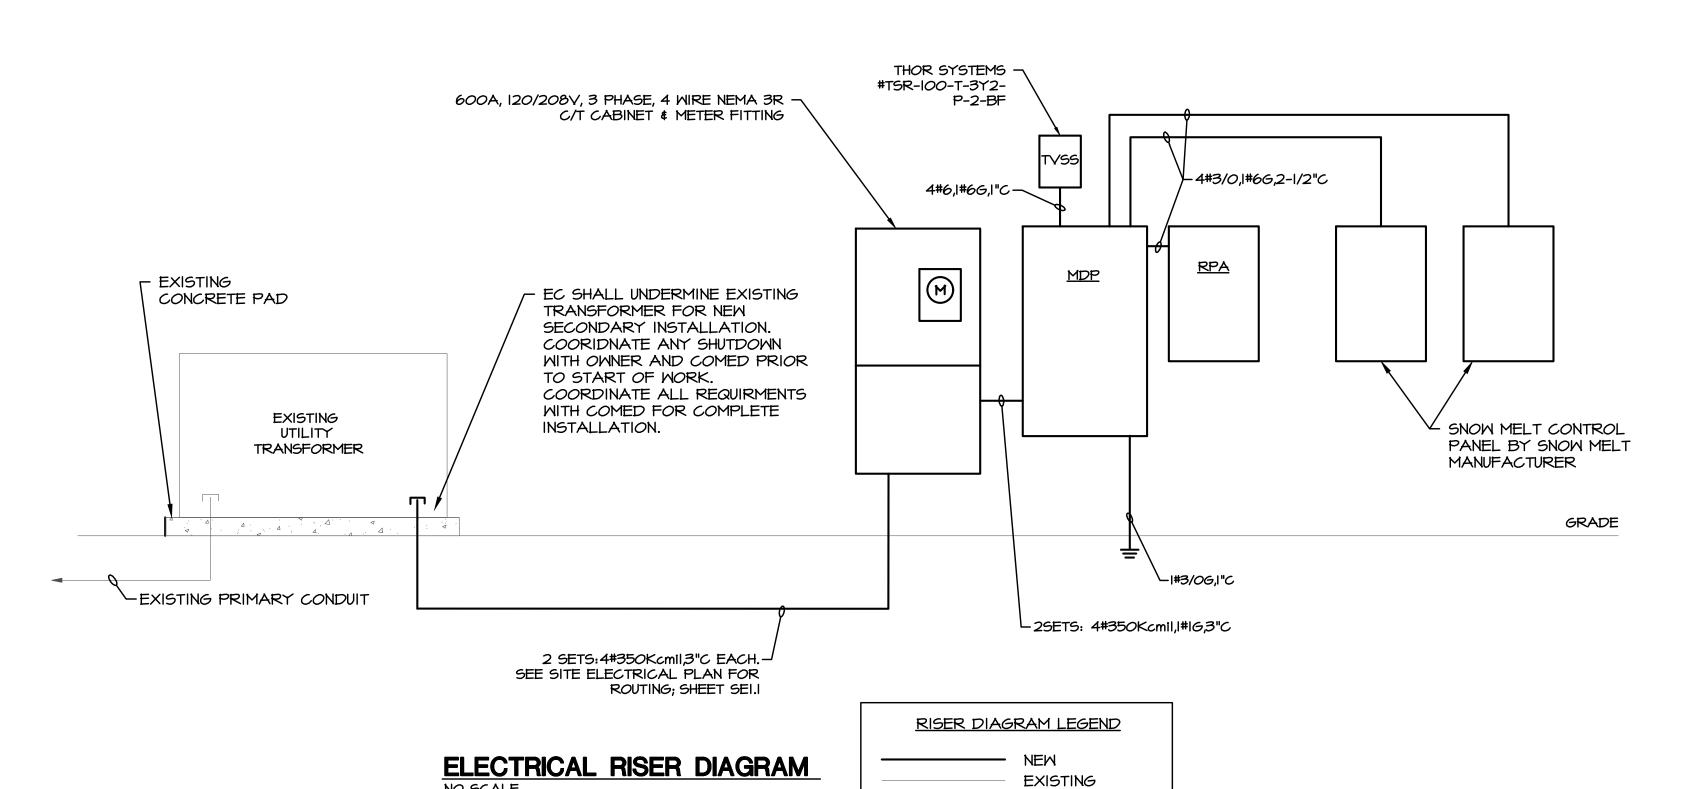

NO SCALE

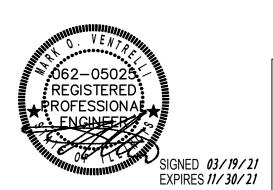

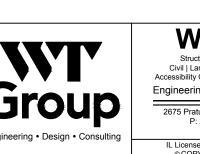



SE DOCUMENTS

CREEK POPLAR

60169

DRIVE 1400

project no. 2002487E 03.19.2021 BID

sheet title:
RISER DIAGRAM +
PANEL SCHEDULES

#### FIRE ALARM SYMBOLS


ADDRESSABLE FIRE ALARM CONTROL PANEL WITH REMOTE 24 FACP HOUR TELEPHONE MONITORING FAAP FIRE ALARM ANNUNCIATOR PANEL FIRE ALARM SYSTEM DUAL ACTION PULL STATION (+48"AFF, MOUNT WITHIN 5 FT. OF DOOR) WITH COVER/SOUNDER PLASTIC SHIELD FIRE ALARM SYSTEM HORN & STROBE LIGHT (AUDIO-VISUAL ALARM, +80"AFF, CANDELA RATING BY OTHERS) VISUAL STROBE LIGHT (+80"AFF, CANDELA RATING BY OTHERS) SMOKE DETECTOR, MINIMUM 3FT. FROM SUPPLY VENT D HEAT DETECTOR, 135° DEGREE FIXED TEMP/RATE OF RISE K KNOX BOX (WEATHER PROOF)

FIRE ALARM SYSTEM SHALL BE AN ADDRESSABLE TYPE ZONED PER NFPA CODE, NON-CODED, CONTINUOUS SOUNDING, UL LISTED, WITH SERIES BATTERIES. MINIMUM WIRE TWO CONDUCTOR INSULATED #14 AWG. TWISTED PAIR, PROVIDE BACKBOXES FOR EACH DEVICE. PROVIDE FULL CONDUIT SYSTEM

DEVICE LAYOUT IS REPRESENTATIVE ONLY. PROVIDE ACTUAL QUANTITY OF DEVICES PER NFPA 12, NFPA IOI, IBC, NEC, IFC, AND PER LOCAL AUTHORITY HAVING JURISDICTION REQUIREMENTS. ELECTRICAL CONTRACTOR SHALL VERIFY EXACT QUANTITY OF FIRE ALARM DEVICES PRIOR TO BIDDING.

ELECTRICAL CONTRACTOR IS RESPONSIBLE FOR THE FIRE ALARM PERMIT AND CONSTRUCTION DOCUMENTS. SUBMIT SHOP DRAWINGS TO ENGINEER AND PERMITTING AUTHORITY FOR REVIEW PRIOR TO INSTALLATION AND RESUBMIT BASED ON COMMENTS, AS REQUIRED. PROVIDE BATTERY AND VOLTAGE DROP CALCULATIONS.

FIRE ALARM DEVICES WIRED TO FACP SHALL BE ADDRESSABLE (DUCT SMOKE DETECTORS, PULL STATIONS, HORNS, VISUALS, FLOW SWITCHES, TAMPER SWITCHES, AND BELLS), VERIFY AND COORDINATE IN FIELD, FACP SHALL BE CONNECTED TO WIRELESS TRANSMITTER.

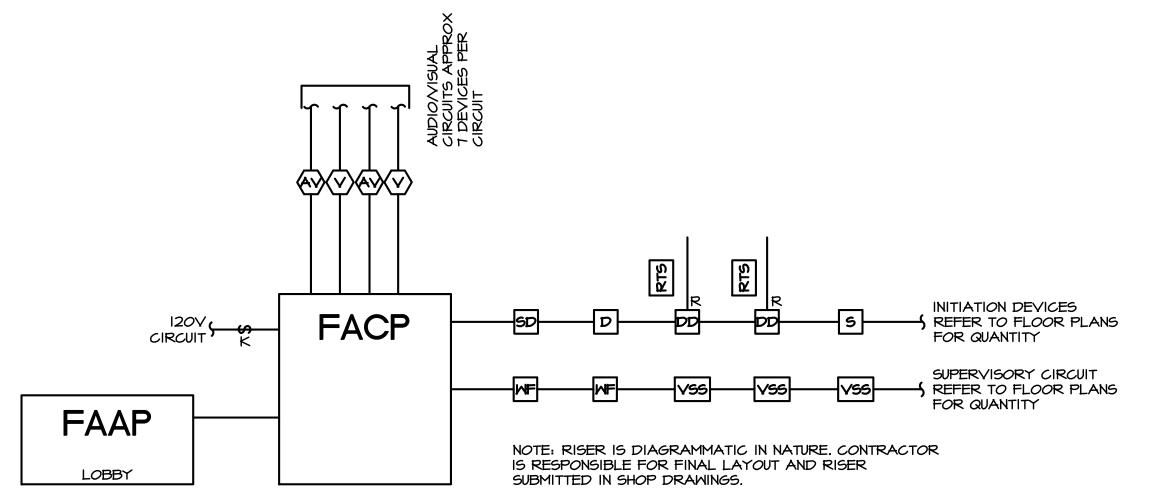

# FIRE ALARM RISER DIAGRAM

# **ELECTRICAL SPECIFICATIONS**

THE GENERAL CONDITIONS AND SUPPLEMENTAL GENERAL CONDITIONS BY THE ARCHITECT SHALL GOVERN WHERE APPLICABLE.

THIS CONTRACTOR SHALL THOROUGHLY FAMILIARIZE HIMSELF WITH THE PLANS AND SHALL VERIFY EXISTING SITE CONDITIONS AT THE JOB SITE BEFORE SUBMITTING BID. FAILURE TO RECOGNIZE WORK REQUIRED SHALL BE AT THE EXPENSE OF THIS CONTRACTOR. NO CONSIDERATION SHALL BE GIVEN FOR ADDITIONAL COMPENSATION AFTER THE LETTING OF BIDS

ENTIRE INSTALLATION SHALL BE PERFORMED IN A FIRST-CLASS WORKMANLIKE MANNER AND SHALL CONFORM TO ALL APPLICABLE CODES AND ORDINANCES. THE COMPLETED SYSTEMS SHALL BE FULLY OPERATIONAL; ACCEPTANCE BY THE OWNER SHALL BE A CONDITION OF THE CONTRACT. ALL WORK SHALL BE COORDINATED WITH OTHER TRADES IN ORDER TO AVOID INTERFERENCE'S, PRESERVE MAXIMUM HEADROOM, AND AVOID OMISSIONS. ALL MATERIALS, WORKMANSHIP AND EQUIPMENT SHALL BE GUARANTEED FOR ONE (I) YEAR AFTER SYSTEM ACCEPTANCE.

RECEPTACLES AND SWITCHES SHALL BE THE TYPE AS SHOWN ON THE DRAWINGS AND SHALL BE SPECIFICATION GRADE.

MINIMUM BRANCH WIRE SIZE SHALL BE #12 AWG COPPER EXCEPT FOR CONTROL AND SIGNAL CIRCUITS. INSULATION (INTERIOR) SHALL BE SOLID TYPE THHN OR THWN SIZES #12 THROUGH #10. SIZES #8 THROUGH 750 MCM SHALL BE STRANDED TYPE THHN OR THAN AT THE CONTRACTOR'S OPTION.

MINIMUM OUTLET BOXES SHALL BE 4" SQUARE, UNLESS OTHERWISE SPECIFIED.

CONTRACTOR SHALL NOT SCALE DRAWINGS FOR DIMENSIONS BUT SHALL CONTACT THE PROJECT ARCHITECT FOR ALL DIMENSIONAL DATA AND SHALL VERIFY EXACT LOCATION AND MOUNTING HEIGHTS OF ALL OUTLETS WITH ARCHITECT AND/OR OWNER PRIOR TO INSTALLATION.

GROUNDING SHALL COMPLY WITH REQUIREMENTS OF ALL APPLICABLE CODES.

ALL MATERIALS USED SHALL BE NEW AND BEAR THE U/L LABEL AND BE OF

THE APPROPRIATE NEMA STANDARD.

THIS CONTRACTOR SHALL ALLOW IN HIS INITIAL BID THE COST OF SERVICES ON ALL EQUIPMENT INSTALLED UNDER HIS CONTRACT FOR A PERIOD OF ONE (I) YEAR FROM DATE OF FINAL ACCEPTANCE OF THE WORK.

LAYOUT IS DIAGRAMMATIC AND WORK SHALL BE INSTALLED TO MEET FIELD CONDITIONS AND EQUIPMENT SELECTED. PROVIDE SHOP DRAWINGS AS REQUIRED AND VERIFY ALL EQUIPMENT.

PANELBOARDS SHALL BE DEAD FRONT WITH BOLT-ON TYPE CIRCUIT BREAKERS W/CU BUS. A TYPED LEGEND, UNDER A CLEAR PLEXAN-GLASS SHALL BE PROVIDED FOR CIRCUIT IDENTIFICATION.

CONTRACTOR SHALL INCLUDE ALL MISCELLANEOUS ITEMS REQUIRED TO COMPLETE THE WORK.

CONTRACTOR SHALL OBTAIN AND PAY FOR ALL PERMITS AND REQUIRED

IT SHALL BE THE RESPONSIBILITY OF THIS CONTRACTOR TO COORDINATE AND REVIEW THE ELECTRICAL CHARACTERISTICS, AMPACITY AND OTHER

REQUIREMENTS OF ALL EQUIPMENT PRIOR TO INSTALLATION.

IT SHALL BE THE RESPONSIBILITY OF THIS CONTRACTOR TO COORDINATE THE LOCATIONS OF CONDUIT ROUTING, EQUIPMENT, LIGHTING, ETC. WITH ALL OTHER TRADES IN THE FIELD PRIOR TO INSTALLATION.

THE ENTIRE INSTALLATION OF ALL COMPONENTS OF THIS PROJECT SHALL COMPLY WITH ALL FEDERAL ADA REQUIREMENTS. VERIFY EXACT LOCATIONS AND HEIGHTS OF ALL FIXTURES AND OUTLETS BEFORE INSTALLATION TO INSURE COMPLIANCE WITH FEDERAL REGULATIONS.

FOR CLARITY OF ALL PLANS, SOME CONDUIT AND WIRE HAS NOT BEEN SHOWN. IT IS THE RESPONSIBILITY OF THIS CONTRACTOR TO FURNISH AND INSTALL COMPLETE AND OPERATING SYSTEMS INCLUDING ALL CONDUIT AND WIRING.

FOR ALL NIGHT LIGHTING, EXIT SIGNS AND BATTERY POWERED EMERGENCY LIGHTING CIRCUITS, THIS CONTRACTOR SHALL USE #10 AWG FOR THE ENTIRE CIRCUIT LENGTH UNLESS INDICATED OTHERWISE.

THIS CONTRACTOR SHALL MAINTAIN THE FIRE RATED INTEGRITY OF ALL FLOORS, CEILINGS AND WALLS. ALL PENETRATIONS THROUGH FIRE RATED BUILDING ELEMENTS SHALL BE EFFECTIVELY SEALED USING APPROVED MATERIALS AND METHODS. ALL LIGHTING FIXTURES MOUNTED IN FIRE RATED CEILINGS SHALL MAINTAIN THE INTEGRITY OF THE FIRE RATED CEILINGS USING APPROVED MATERIALS AND METHODS. REFER TO ARCHITECTURAL DRAWINGS FOR FIRE RATINGS.

THIS CONTRACTOR SHALL INSPECT THE COMPLETE SET OF DRAWINGS AND SPECIFICATIONS TO DETERMINE HIS ENTIRE SCOPE OF WORK. THIS CONTRACTOR SHALL VISIT THE SITE AND BECOME FAMILIAR WITH THE EXISTING CONDITIONS AND EXTENT OF DEMOLITION AND NEW WORK FOR THIS PROJECT PRIOR TO SUBMITTING HIS BID.

THE ELECTRICAL INSTALLATION IS TO BE IN STRICT ACCORDANCE WITH THE APPLICABLE RULES AND REGULATIONS OF ALL LOCAL, STATE AND FEDERAL ELECTRICAL CODES AND THE LOCAL UTILITY COMPANY REQUIREMENTS OR ANY OTHER AUTHORITIES HAVING LAWFUL JURISDICTION.

ALL SITE UNDERGROUND BRANCH CIRCUIT WIRING IN CONDUIT SHALL BE TYPE THWN OR XHHW.

ALL EXPOSED TO THE WEATHER CONDUIT SHALL BE HEAVYWALL, GALVANIZED RIGID STEEL 'RGS' OR INTERMEDIATE METAL CONDUIT 'IMC', MINIMUM SIZE 3/4".

ALL UNDERFLOOR, UNDERGROUND CONDUIT SHALL BE SCHEDULE 40 PVC, MINIMUM SIZE 3/4". PVC CONDUIT ROUTED UNDERFLOOR, UNDERGROUND SHALL BE TRANSITION TO HEAVYWALL GALVANIZED RIGID STEEL 'RGS' OR INTERMEDIATE METAL CONDUIT 'IMC' PRIOR TO GRADE.

ALL WIRE SHALL BE INSTALLED IN THINWALL, ELECTRICAL METALLIC TUBING (EMT) CONDUIT UNLESS OTHERWISE NOTED. MINIMUM SIZE SHALL BE 3/4" FOR BRANCH CIRCUIT WIRING, DROPS TO SWITCHES AND BRANCH DEVICES MAY BE 1/2" UNLESS OTHERWISE NOTED ON DRAWINGS. ALL THINWALL FITTINGS SHALL BE OF THE STEEL COMPRESSION GLAND TYPE PER ALL APPLICABLE CODE REQUIREMENTS. ALL CONDUITS SHALL BE CONCEALED WHERE POSSIBLE, WHERE EXPOSED, THIS CONTRACTOR SHALL RUN CONDUITS IN STRAIGHT LINES PARALLEL AND/OR PERPENDICULAR TO THE BUILDING CONSTRUCTION. CONDUITS INSTALLED IN AREAS SUBJECT TO MECHANICAL DAMAGE SHALL BE RIGID GALVANIZED, OR INTERMEDIATE METAL TYPE.

THIS CONTRACTOR SHALL PROVIDE ALL TEMPORARY WIRING FOR ALL TRADES FOR CONSTRUCTION EQUIPMENT (ie: HANDTOOLS, WELDERS, PIPE BENDERS, ETC.) AND CONSTRUCTION LIGHTING PER THE LATEST OSHA STANDARDS. INCLUDE ALL COSTS IN THE BASE BID. THIS CONTRACTOR SHALL ESTABLISH SAFE WORKING PROCEDURES FOR THE PROTECTION OF THE WORKMEN IN ALL PHASES OF WORK, COMPLYING WITH THE APPLICABLE PROVISIONS OF ALL CITY, STATE AND FEDERAL SAFETY LAWS (OSHA).

LED LIGHT FIXTURE. CAPITAL LETTER DENOTES FIXTURE TYPE, NUMERAL INDICATES CIRCUIT ASSIGNMENT, SUBSCRIPT LETTER DENOTES SWITCH LEG. SHADING OF ANY FIXTURE INDICATES CIRCUITED TO UNSWITCHED NIGHT LIGHT CIRCUIT. SEE "LIGHTING FIXTURE SCHEDULE."

> EXIT SIGN UNIVERSAL MOUNT SHADED AREA INDICATES FACE, ARROWS AS REQUIRED. SEE "LIGHTING FIXTURE SCHEDULE."

LIGHTING FIXTURE OUTLET - SEE "LIGHTING FIXTURE SCHEDULE"

NON FUSED SAFETY SWITCH, RATING AS INDICATED FUSED DISCONNECT SWITCH, SWITCH AND FUSE RATING AS

3-PHASE COMBINATION MAGNETIC STARTER WITH NEMA SIZE INDICATED BY E.C.

ISOLATED GROUND DUPLEX RECEPTACLE, NEMA 5-20R, I5"A.F.F. U.N.O.

SINGLE RECEPTACLE, NEMA 5-20, 15" A.F.F. U.N.O.

DUPLEX RECEPTACLE, NEMA 5-20R, 15"A.F.F. U.N.O. DUPLEX RECEPTACLE, NEMA 5-20R, CROSS LINE DENOTES

6" ABOVE COUNTER OR BACKSPLASH U.N.O. DOUBLE DUPLEX RECEPTACLE, NEMA 5-20R, 15"A.F.F. U.N.O.

DUPLEX RECEPTACLE, NEMA 5-20R, SHADING DENOTES GROUND FAULT CIRCUIT INTERRUPTER "GFCI"., 15"A.F.F. U.N.O.

DUPLEX RECEPTACLE, NEMA 5-20R, SHADING DENOTES GROUND FAULT CIRCUIT INTERRUPTER "GFCI", CROSS LINE DENOTES 6" ABOVE COUNTER OR BACKSPLASH U.N.O.

DOUBLE DUPLEX RECEPTACLE, NEMA 5-20R, SHADING DENOTES GROUND FAULT CIRCUIT INTERRUPTER "GFCI"., 15"A.F.F. U.N.O.

DUPLEX RECEPTACLE W 2 USB PORTS, NEMA 5-20R,

DUPLEX RECEPTACLE W/ 2 USB PORTS, NEMA 5-20R, CROSS LINE DENOTES 6" ABOVE COUNTER OR BACKSPLASH U.N.O.

SPECIAL PURPOSE RECEPTACLE NEMA CONFIGURATION AS REQUIRED BY MANUFACTURERS EQUIPMENT. VERIFY CONDUIT, CONDUCTOR AND DISCONNECT/CIRCUIT BREAKER REQUIREMENTS PRIOR TO ROUGH-IN.

LIGHTING AND/OR POWER PANEL

15"A.F.F. U.N.O.

**/**/ MOTOR

O

町

 $\blacksquare$ 

INDICATED.

PHOTO ELECTRIC CONTROL, ROOF MOUNTED, (FACE NORTH) 120Y OPERATION, 20A RATED TIED TO LIGHTING RELAY PANEL (LRP); ACUITY #PCELL-2MO-BB

CONDUIT ROUTED CONCEALED IN CEILING OR WALL CONSTRUCTION. (CROSS LINES DENOTE NUMBER OF WIRES.) CONDUIT ROUTED EXPOSED, PARALLEL OR PERPENDICULAR

TO WALLS. CONDUIT ROUTED CONCEALED IN CONCRETE FLOOR SLAB

**J** AUXILIARY JUNCTION BOX

OR UNDERGROUND.

FLEXIBLE CONDUIT CONNECTION

HOME RUN TO PANELBOARD CONDUIT - PHASE CONDUCTORS NEUTRAL CONDUCTOR EQUIPMENT GROUND ISOLATED GROUND

WEATHER PROOF (NEMA 3R)

F.B.O. FURNISHED BY OTHERS

DENOTES 6" ABOYE COUNTER OR BACKSPLASH U.N.O.

UNLESS NOTED OTHERWISE U.N.O.

A.F.F. ABOVE FINISH FLOOR

WIRE GUARD BY SAFETY TECHNOLOGY INTERNATIONAL, INC WG

> 2-GANG RECESSED FLOOR-BOX / POKE-THRU DEVICE. VERIFY EXACT DEVICE IN FIELD. MOUNTED FLUSH IN FLOOR. PROVIDE SEPARATE CONDUIT STUBS FOR POWER AND DATA (I") CABLING. COVER ASSEMBLY AND DEVICES AS INDICATED. COVER FINISH TO BE SELECTED BY ARCHITECT. LEGRAND

EVOLUTION 6" SERIES

**ELECTRICAL SYMBOLS** 

TELEPHONE OUTLET, WITH I" CONDUIT

DATA SYSTEM OUTLET WITH I" CONDUIT

TY OUTLET, WITH I" CONDUIT

SINGLE POLE TOGGLE SWITCH, 48"AFF, SUBSCRIPT LETTER DENOTES SWITCH LEG, 20 AMP, 120 VOLT

MALL TELEPHONE OUTLET (48"AFF) WITH I" CONDUIT

THREE WAY TOGGLE SWITCH, 48"AFF, 20AMP, 120VOLT.

MANUAL SINGLE PHASE MOTOR STARTER WITH THERMAL OVERLOAD PROTECTION. "P" DENOTES DEVICE FURNISHED WITH PILOT LIGHT., 48"AFF UNLESS INDICATED OTHERWISE

SINGLE POLE PILOT LIGHT SWITCH, 48"AFF, PILOT LIGHT ON WHEN DEVICE IS TURNED ON, 20 AMP, 120 YOLT

FAN SPEED SWITCH; 48"AFF

MOMENTARY CONTACT SWITCH

48"A.F.F.

WALL MOUNTED OCCUPANCY SENSOR SWITCH (AUTO ON / AUTO OFF) 48"A.F.F. ACUITY #WSX-PDT-XX

MALL MOUNTED VACANCY SENSOR SWITCH (MANUAL ON / AUTO OFF) 48"A.F.F. ACUITY #MSX-PDT-SA-XX

, DVS WALL MOUNTED VACANCY SENSOR DIMMER SWITCH (MANUAL ON / AUTO OFF) 48"A.F.F. ACUITY #WSX-PDT-D-SA-XX

nLIGHT (ON/OFF) SWITCH; 48"A.F.F. ACUITY #NPODM-XX

 $_{+}^{ extsf{LVD}}$  nLIGHT (ON/OFF + RAISE/LOWER) SWITCH; 48"A.F.F. ACUITY #NPODM-DX-XX

LVSC NLIGHT SCENE CONTROLLER (ON/OFF + RAISE/LOWER) SWITCH; 48"A.F.F. ACUITY #NPODM-4SB-DX-WH

nLIGHT O-IOY POWER PACK; ACUITY #NPPI6-D

nLIGHT ELV POWER PACK; ACUITY #NSP5-PCD

NLIGHT CEILING MOUNTED ULTRASONIC/ PASSIVE INFRARED OCCUPANCY SENSOR; ACUITY #nCM-PDT-10-RJB

nLIGHT CEILING MOUNTED ULTRASONIC/ PASSIVE INFRARED VACANCY SENSOR; ACUITY #nCM-PDT-10-RJB

### **BRANCH WIRING NOTES**


PROVIDE THE FOLLOWING MINIMUM WIRE SIZE TO THE FIRST OUTLET OF A 15 OR 20 AMPERE BRANCH CIRCUIT. PROVIDE MINIMUM #10AMG TO THE LAST OUTLET FOR ALL BRANCH CIRCUITS MORE THAN 200 FEET IN LENGTH.

**DISTANCE** AMG WIRE SIZES UP TO 100 FEET 100 TO 200 FEET MORE THAN 200 FEET

PROVIDE MINIMUM AWG CONDUCTOR SIZES FOR GENERAL BRANCH CIRCUITING AS FOLLOWS. WHERE APPLICABLE INCREASE AS REQUIRED TO ACCOMMODATE VOLTAGE

#8 MINIMUM

OVERCURRENT CU AMG OVERCURRENT CU AMG PROTECTION <u> WIRE SIZE</u> <u>WIRE SIZE</u> <u>PROTECTION</u> 15/20 AMPERE 60 AMPERE 25/30 AMPERE 70/80 AMPERE 90 AMPERE 40 AMPERE 50 AMPERE 100 AMPERE

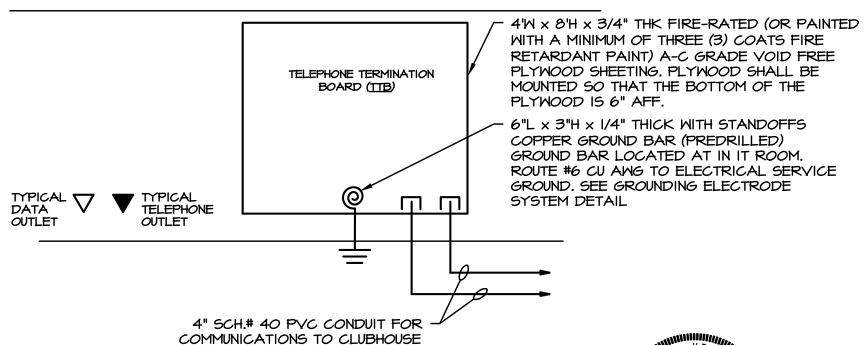

DETAIL - TELEPHONE/CATV RISER 'TTB' NOT TO SCALE

FOR ROUTING

WITH PULL CORD. SEE SITE PLAN

ROFESSIONA EXPIRES 11/30/21

WT GROUP W Civil | Land Survey | Telecommunication| Aquatic Accessibility Consulting | Design & Program Managem Engineering with Precision, Pace & Passion. Pratum Avenue | Hoffman Estates, IL 60192 P: 224.293.6333 | F: 224.293.6444 wtengineering.com

evision 2 revision 3 evision 4: **ELECTRICAL SPEC** SYMBOLS + NOTES


2002487

03.19.2021 BI

DRIV

OP


.09

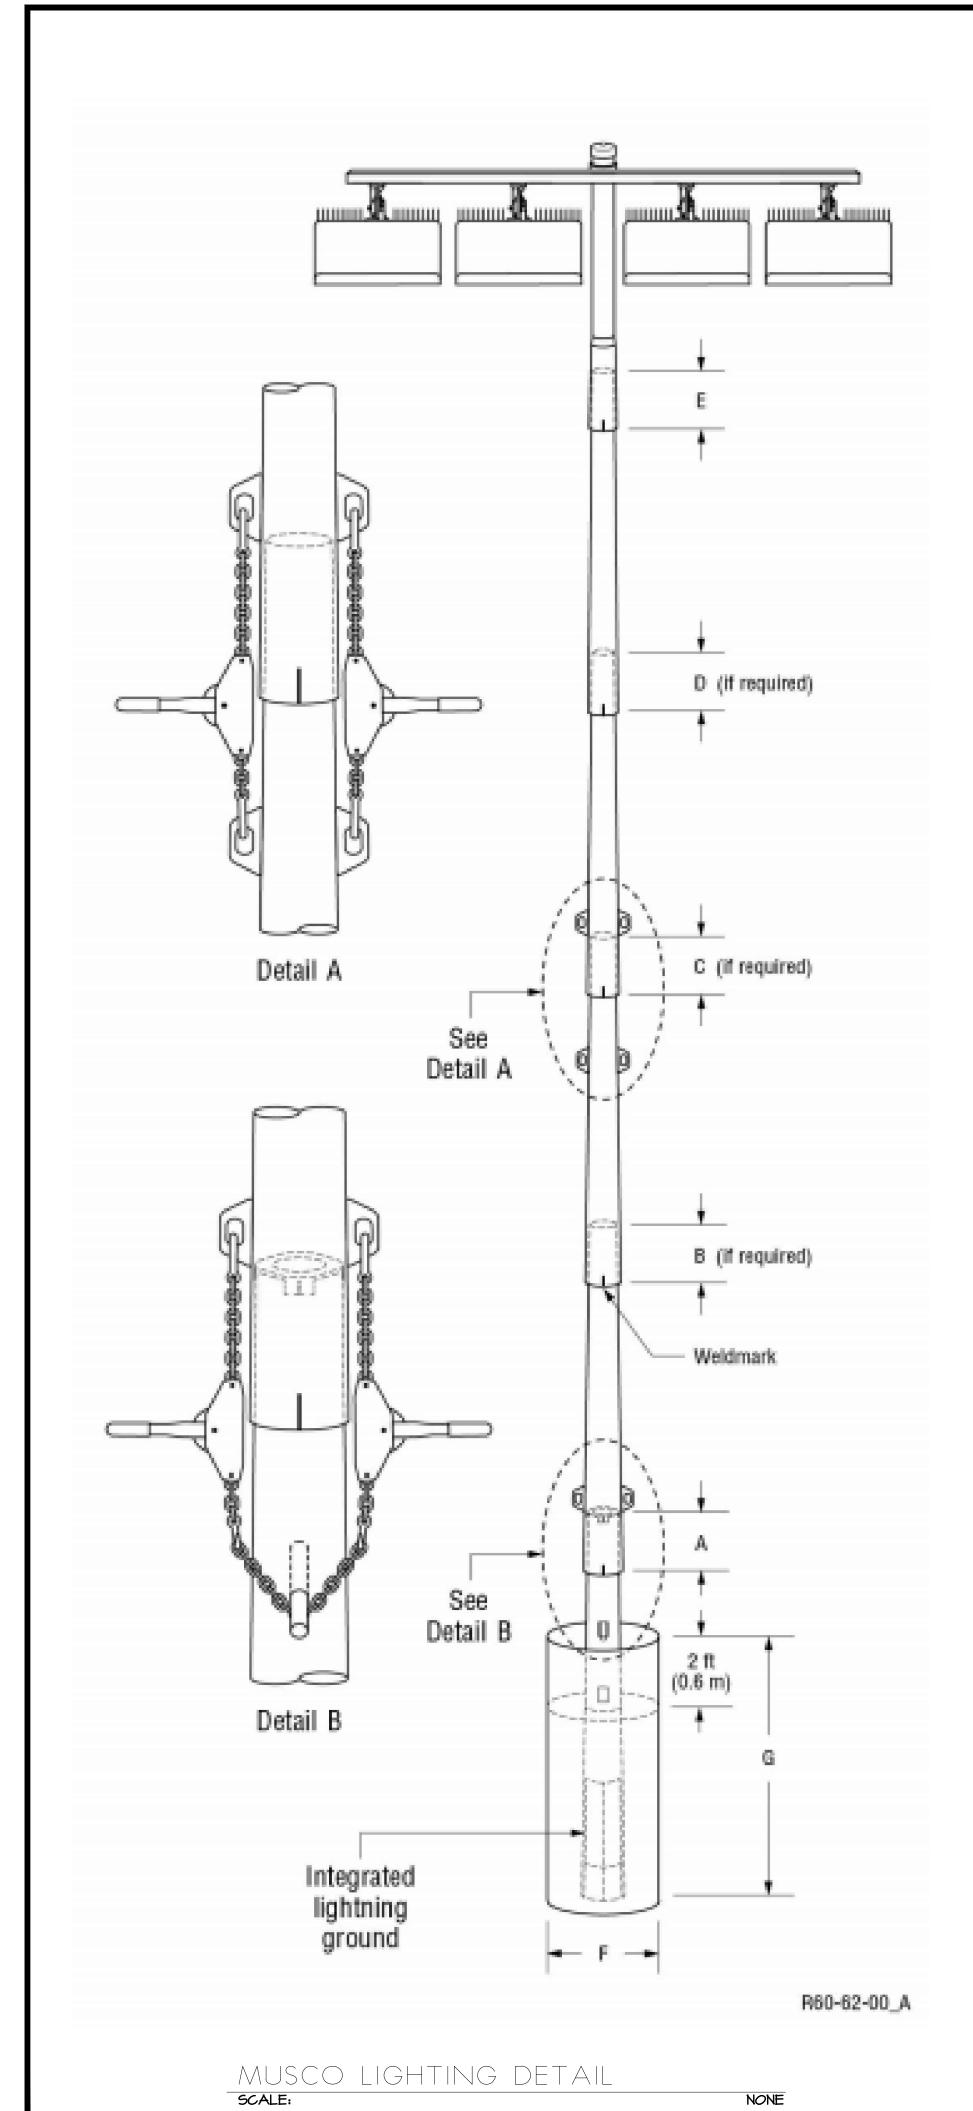


NONE

A	DESCRIPTION & FEATURES		LAMPS	MOUNTING		SPECIFIED MANUFACTURER
A		QTY.	TYPE	TYPE CLG./POLE-TYPE	VOLT	AND CATALOG NUMBER
	4'-0" LED STRIP WITH LENS		30M LED	SURFACE	120	LITHONIA #ZLID-L48-3000LM-FST-
						MVOLT-35K-80CRI-WH
A1	4'-0" LED STRIP WITH LENS & BUILT-IN		30W LED	SURFACE	120	LITHONIA #ZLID-L48-3000LM-FST-
	EMERGENCY BATTERY BACK-UP					MVOLT-35K-80CRI-E7M-WH
В	4'-0" LED WRAPAROUND		45.2M LED	SURFACE	120	LITHONIA #STL4-48L-EZI-LP830
B1	4'-0" LED WRAPAROUND W/BUILT-IN		34.9W LED	SURFACE	120	LITHONIA #STL4-48L-EZI-LP830
	EMERGENCY BATTERY BACK-UP					ELI4L
С	8'-0" LED SUSPENDED		50M LED	SUSPENDED	120	LITHONIA LL8 8000LM 80CRI 35K EPD
						MINIO ZT MVOLT WH ZACI20
C1 -	8'-0" LED SUSPENDED		50M LED	SUSPENDED	120	LITHONIA LL8 8000LM 80CRI 35K EPD
	EMERGENCY BATTERY BACK-UP					MINIO ZT MVOLT IEIOMCP WH ZACI20
D	EXTERIOR CYLINDER		14W LED	SURFACE	120	LITHONIA-OLLWD LED PI 40K MVOLT DDE
F	60" PADDLE FAN			SURFACE	120	BIG ASS FAN-16 60" OUTDOOR FAN
						WITH REMOTE CONTROL
S	SPORTS LIGHT W./ 40' POLE		8-1430W LED	POLE	208	MUSCO-TLC LED 1500 5700K 75CRI
						208V 40' POLE
X	LED EXIT SIGN WITH EMERGENCY		IM LED	SURFACE	120	LITHONIA #LQM-S-W-3-R-120/277-ELN

- I. THE FIXTURE SCHEDULE DOES NOT NECESSARILY LIST ALL ACCESSORIES AND HARDWARE NECESSARY FOR THE COMPLETION OF INSTALLATION, NOR DOES IT DETAIL THE CEILING CONSTRUCTION TO BE ENCOUNTERED. IT IS THE CONTRACTOR'S RESPONSIBILITY TO PROPERLY DETERMINE AND PROVIDE CORRECT COMPONENTS, ACCESSORIES, AND HARDWARE AS REQUIRED FOR THE INSTALLATION.
- 2. CONTRACTOR SHALL COORDINATE WITH ARCHITECTURAL DRAWINGS AND CEILING CONTRACTOR FOR EXACT LIGHTING FIXTURE LOCATION.
- 3. ALL BATTERY BACK-UP EMERGENCY LIGHT AND EXIT SIGN LIGHTING FIXTURES INDICATED SHALL HAVE BATTERY BACK-UP RATED FOR I-1/2 HOURS MINIMUM AND AS APPROVED BY LOCAL FIRE PREVENTION BUREAU.
- 4. EMERGENCY LIGHTING SHALL BE PROVIDED WITH SEPARATE EMERGENCY BATTERY PACK POWERED WITH SEPARATE HOT LEG. THE NORMAL DRIVER SHALL BE CONNECTED WITH ALL OTHER NORMAL FIXTURES CONTROLS. THE FIXTURE SHALL ACT AS A NORMAL CONTROLLABLE FIXTURE UNTIL LOSS OF POWER, AT THAT CONDITION EMERGENCY BATTERY PACK SHALL ENERGIZE LAMPS

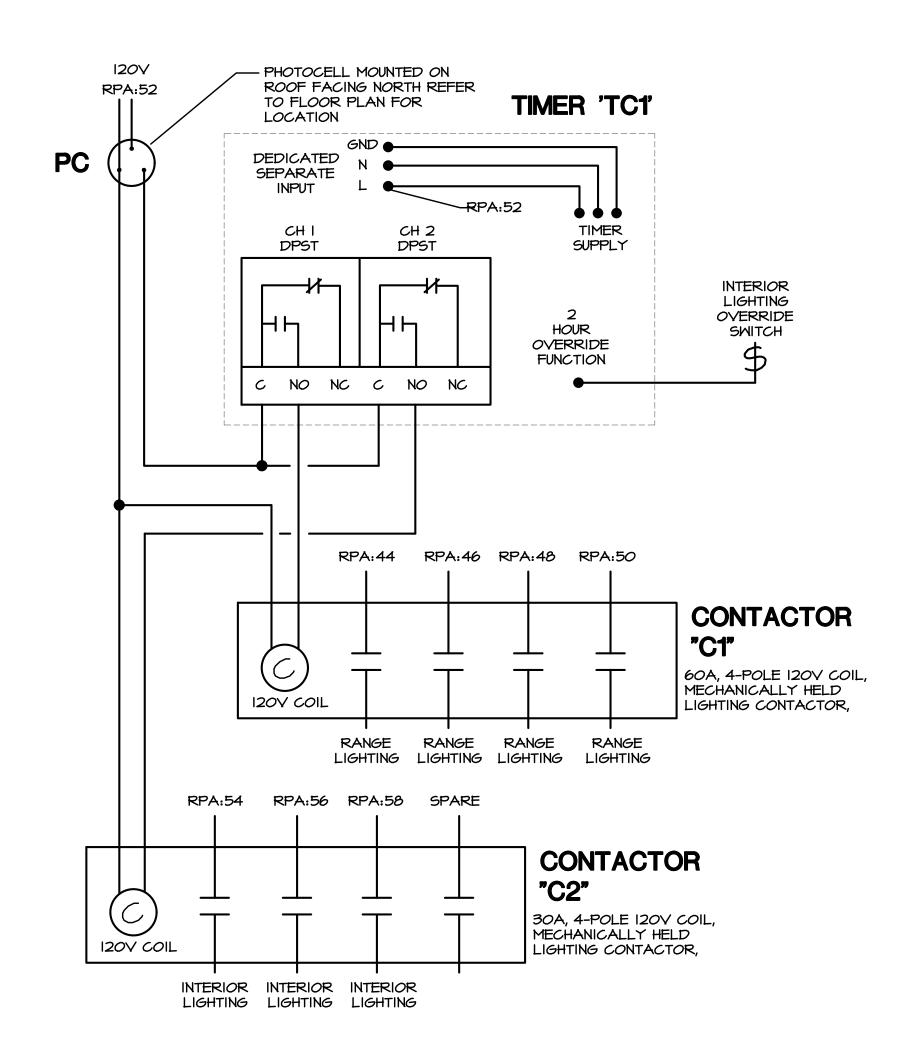

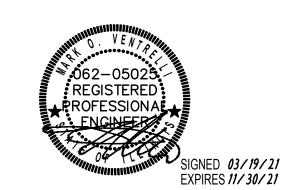





60169

03.19.2021 BID sheet title:
LIGHTING FIXTURE
SCHEDULE

11. CONTRACTOR'S NOTE: FOR PRODUCT AND COMPANY INFORMATION VISIT www.CADdetails.com/info

DISTRIBUTION PANELBOARD - ALARM HORN (OPTIONAL) -MAIN CIRCUIT DOOR DISCONNECT BREAKER (OPTIONAL) ALARM RELAY (OPTIONAL) PUSH BUTTON FOR COMMON ALARM LIGHT TESTING PUSH TO ACKNOWLEDGE FUSE HOLDER -POWER ON TERMINALS -(OPTIONAL) HAND/OFF.AUTO - SELECTOR SWITCH GROUND BUS BAR -ALARM OPTION SHOWN ABOVE MAIN CONTACTOR-

1. INSTALLATION TO BE COMPLETED IN ACCORDANCE WITH MANUFACTURER'S SPECIFICATIONS. 2. DO NOT SCALE DRAWING.

DIGITRACE HTPG POWER DISTRIBUTION PANEL

CABLE IN 150MM (6") FROM EDGE UNLESS CURBS USED

FASTEN CABLE TO MESH OR -REBAR WITH PLASTIC TIE WRAPS.

3. THIS DRAWING IS INTENDED FOR USE BY ARCHITECTS, ENGINEERS, CONTRACTORS, CONSULTANTS AND DESIGN PROFESSIONALS FOR PLANNING PURPOSES ONLY. THIS DRAWING MAY NOT BE USED FOR CONSTRUCTION.

4. ALL INFORMATION CONTAINED HEREIN WAS CURRENT AT THE TIME OF DEVELOPMENT BUT MUST BE REVIEWED AND APPROVED BY THE PRODUCT MANUFACTURER TO BE CONSIDERED ACCURATE.

5. CONTRACTOR'S NOTE: FOR PRODUCT AND COMPANY INFORMATION VISIT www.CADdetails.com/info AND ENTER REFERENCE NUMBER 3408-118.

HEAT TRACING POWER DISTRIBUTION PANELS

HANDHOLE COVER LEAD HANDHOLE ENCLOSURE -COILED INSTALLED ACCORDING OTAK TO MANUFACTURER'S INSTRUCTIONS INSIDE WELL DRAINED GRAVEL BASE HOT/COLD NON-METALLIC CONDUIT ACCORDING TO MANUFACTURER'S JOINTS FOR COLD LEAD FROM INSTRUCTIONS EMBEDDED IN SLAB TO HANDLE


1. INSTALLATION TO BE COMPLETED IN ACCORDANCE WITH MANUFACTURER'S SPECIFICATIONS.

2. ALL DIMENSIONS ARE CONSIDERED TRUE AND REFLECT MANUFACTURER'S SPECIFICATIONS. 3. DO NOT SCALE DRAWING.

4. THESE DRAWINGS ARE NOT FOR CONSTRUCTION PURPOSES AND ARE FOR INFORMATION PURPOSES ONLY. ALL INFORMATION CONTAINED HEREIN WAS CURRENT AT THE TIME OF DEVELOPMENT BUT MUST BE REVIEWED AND APPROVED BY THE PRODUCT MANUFACTURER TO BE CONSIDERED ACCURATE.

5. CONTRACTOR'S NOTE: FOR PRODUCT AND COMPANY INFORMATION VISIT www.CADdetails.com/info REFERENCE NUMBER 3408-160.

PYROTENAX MINERAL INSULATED SNOW MELTING SYSTEMS MI TERMINATIONS IN HANDHOLE ENCLOSURES

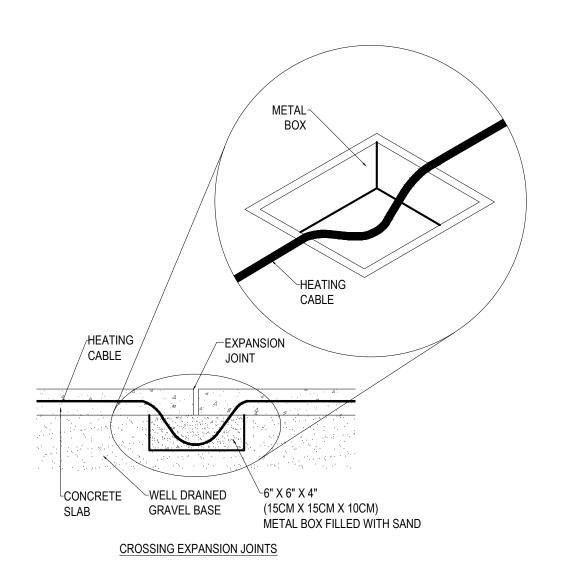

9. O EUR-5A TERMINAL

□ CONTROL PANEL TERMINAL

REFERENCE NUMBER 3408-127.

**SNOW MELT PANEL** 

**EUR-5A WIRING DIAGRAM** 

10. DO NOT SCALE DRAWING.


1. INSTALLATION TO BE COMPLETED IN ACCORDANCE WITH MANUFACTURER'S SPECIFICATIONS.

2. DO NOT SCALE DRAWING. 3. THIS DRAWING IS INTENDED FOR USE BY ARCHITECTS, ENGINEERS, CONTRACTORS, CONSULTANTS AND DESIGN

PROFESSIONALS FOR PLANNING PURPOSES ONLY. THIS DRAWING MAY NOT BE USED FOR CONSTRUCTION. 4. ALL INFORMATION CONTAINED HEREIN WAS CURRENT AT THE TIME OF DEVELOPMENT BUT MUST BE REVIEWED AND APPROVED BY THE PRODUCT MANUFACTURER TO BE CONSIDERED ACCURATE.

5. CONTRACTOR'S NOTE: FOR PRODUCT AND COMPANY INFORMATION VISIT www.CADdetails.com/info AND ENTER REFERENCE NUMBER 3408-126.

MI EXPANSION JOINT DETAIL CROSSING EXPANSION JOINTS WITH MI HEATING CABLE

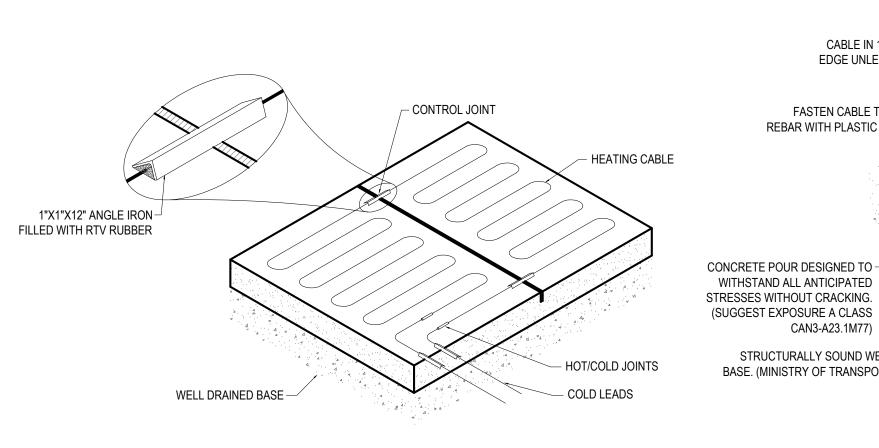

METHOD OF CROSSING CONTROL JOINT WITH M.I. HEATING CABLE IN CONCRETE SLAB

1. INSTALLATION TO BE COMPLETED IN ACCORDANCE WITH MANUFACTURER'S SPECIFICATIONS.

2. DO NOT SCALE DRAWING.

3. THIS DRAWING IS INTENDED FOR USE BY ARCHITECTS, ENGINEERS, CONTRACTORS, CONSULTANTS AND DESIGN PROFESSIONALS FOR PLANNING PURPOSES ONLY. THIS DRAWING MAY NOT BE USED FOR CONSTRUCTION.

4. ALL INFORMATION CONTAINED HEREIN WAS CURRENT AT THE TIME OF DEVELOPMENT BUT MUST BE REVIEWED AND APPROVED BY THE PRODUCT MANUFACTURER TO BE CONSIDERED ACCURATE.

5. CONTRACTOR'S NOTE: FOR PRODUCT AND COMPANY INFORMATION VISIT www.CADdetails.com/info AND ENTER REFERENCE NUMBER 3408-078.

SURFACE SNOW MELTING PYROTENAX - CONTROL JOINT INSTALLATION DETAIL



CAN3-A23.1M77)

STRUCTURALLY SOUND WELL DRAINED — BASE. (MINISTRY OF TRANSPORT CLASS A)

1. LEAD-IN CABLE SHOULD BE TERMINATED IN A JUNCTION BOX ABOVE GRADE LEVEL TO PREVENT MOISTURE FROM ENTERING FROM ENTERING THE BOX.

2. CARE MUST BE TAKEN NOT TO DAMAGE CABLE WITH RAKES, SHOVELS, WHEELBARROWS, ETC.

3. CONTROL JOINTS TO BE PLACED NO FURTHER THAN 20' IN ANY ONE DIRECTION. 4. CUT CONTROL JOINTS 1/8" WIDE AND 3/4" DEEP APPROX. 6 HOURS AFTER PLACING CONCRETE.

5. INSTALLATION TO BE COMPLETED IN ACCORDANCE WITH MANUFACTURER'S SPECIFICATIONS. DO NOT SCALE DRAWING.

7. THIS DRAWING IS INTENDED FOR USE BY ARCHITECTS, ENGINEERS, CONTRACTORS, CONSULTANTS AND DESIGN

PROFESSIONALS FOR PLANNING PURPOSES ONLY. THIS DRAWING MAY NOT BE USED FOR CONSTRUCTION. 8. ALL INFORMATION CONTAINED HEREIN WAS CURRENT AT THE TIME OF DEVELOPMENT BUT MUST BE REVIEWED AND APPROVED BY THE PRODUCT MANUFACTURER TO BE CONSIDERED ACCURATE.

9. CONTRACTOR'S NOTE: FOR PRODUCT AND COMPANY INFORMATION VISIT www.CADdetails.com/info AND ENTER

REFERENCE NUMBER 3408-082.







WT GROUP Civil | Land Survey | Telecommunication| Aquatic Accessibility Consulting | Design & Program Manageme Engineering with Precision, Pace & Passion. 5 Pratum Avenue | Hoffman Estates, IL 60192 P: 224.293.6333 | F: 224.293.6444

- 6X6X6 REINFORCING MESH OR


SUPPORTED EVER 18" WITH CHAIR

RE-BAR IN TWO DIRECTIONS.

LEAD-IN CABLES PROTECTED WITH METAL

ONES WHERE THEY EMERGE FROM SLAB.

GUARD AND SPACED 150MM (6") FROM ADJACENT

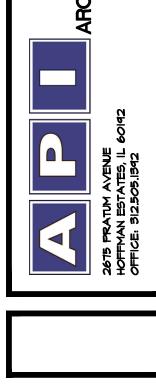

DRIVE

2002487 03.19.2021 BI

SNOW MELT DETAILS

