
SOUTH RIDGE COMMUNITY PARK (BID SET) ENHANCEMENT PLAN 2019

1450 FREEMAN ROAD HOFFMAN ESTATES, IL 60192

| CIVIL DRAWING INDEX | | | | | |
|---------------------|---|---------|--|--|--|
| SHEET | SHEET DESCRIPTION | | | | |
| T-1.0 | TITLE SHEET | 1-23-20 | | | |
| C-1.0 | OVERALL SITE PLAN | 1-23-20 | | | |
| C-2.0 - C-2.4 | SITE DEMOLITION PLAN | 1-23-20 | | | |
| C-3.0 - C-3.4 | SITE GEOMETRIC PLAN | 1-23-20 | | | |
| C-4.0 - C-4.4 | SITE DEVELOPMENT PLAN | 1-23-20 | | | |
| C-4.5 - C-4.8 | SITE DEVELOPMENT DETAILS | 1-23-20 | | | |
| C-5.0 - C-5.5 | SITE GRADING PLAN | 1-23-20 | | | |
| C-6.0 - C-6.4 | SITE UTILITY PLAN | 1-23-20 | | | |
| C-6.5 - C-6.7 | SITE UTILITY DETAILS | 1-23-20 | | | |
| C-7.0 - C-7.4 | STORM WATER POLLUTION PREVENTION PLAN | 1-23-20 | | | |
| C-7.5 | STORM WATER POLLUTION PREVENTION DETAILS | 1-23-20 | | | |
| C-8.0 - C-8.1 | PROJECT SPECIFICATIONS | 1-23-20 | | | |
| L-1.0 | LANDSCAPE PLAN | 1-23-20 | | | |
| A-01 - A-02 | ARCHITECTURAL PLANS, DETAILS AND SECTIONS | 1-23-20 | | | |
| E1.0 - E2.0 | ELECTRICAL PLAN | 1-23-20 | | | |
| M1.1 | MECHANICAL PLAN | 1-23-20 | | | |
| P1.1 - P2.1 | PLUMBING PLAN | 1-23-20 | | | |
| 1-10 | SPLASH PAD DRAWINGS | 1-20-20 | | | |
| 1-4 | PLAT OF SURVEY (PREPARED BY ENGINEERING RESOURCE ASSOCIATES INC.) | 6-16-09 | | | |

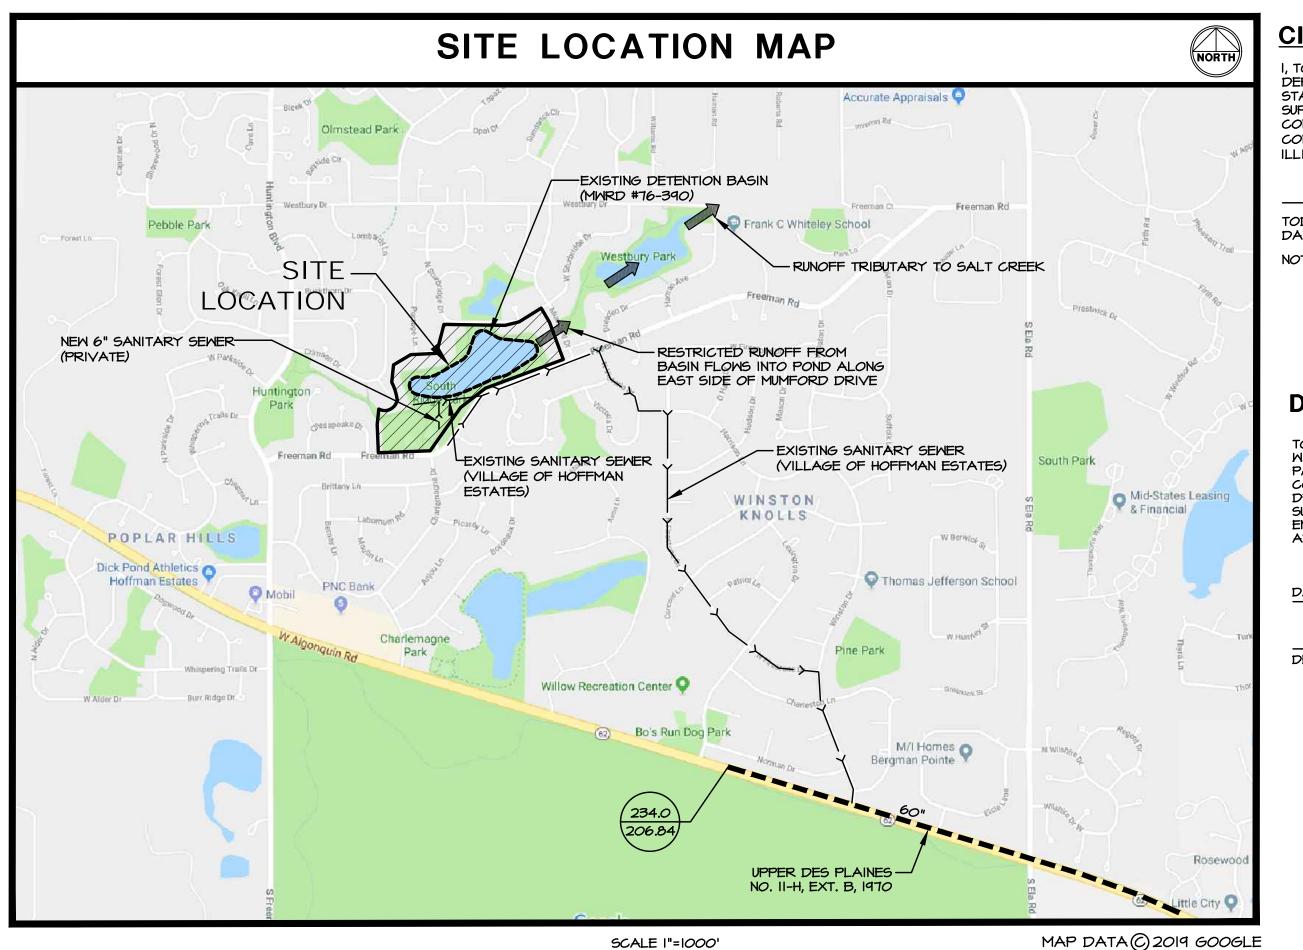

BENCHMARK:

SITE BENCHMARK - MUELLER BOLT, TOP FLANGE OF HYDRANT, IN FRONT OF

1285 FREEMAN ROAD. ELEVATION = 840.10

LEGEND SECTION 19 SANITARY SEWER STORM SEWER **TOWNSHIP 44N** COMBINED SEWER RANGE 10E M.W.R.D. SEWERS

CIVIL ENGINEERING STATEMENT AND SEAL

STATE THAT THIS DOCUMENT WAS PREPARED BY ME OR UNDER MY DIRECT

TODD ABRAMS - ILLINOIS P.E. # 062-061600

DRAINAGE CERTIFICATE:

SURFACE WATERS ARE PLANNED FOR IN ACCORDANCE WITH GENERALLY ACCEPTED ENGINEERING PRACTICES SO AS TO REDUCE THE LIKELIHOOD OF DAMAGES TO

DATED THIS DAY OF 062-061600 EXP. DATE 11/30/21 DESIGN ENGINEER- TODD ABRAMS, P.E.

> CALL JULIE TOLL FREE 1(800)892-0123 OPERATES 24 HOURS A DAY 365 DAYS A YEAR 1(800)892-0123 48 HOURS BEFORE

CONTRACTOR MUST LOCATE PRIVATE UTILITIES IN AREA OF CONSTRUCTION PRIOR TO PROCEEDING WITH WORK

NOTE: BEING THAT THIS PROJECT IS PERMITTED UNDER THE NEW WATERSHED MANAGEMENT ORDINANCE (WMO), THE MWRD REQUIRES 48 HOURS OF ADVANCE NOTIFICATION PRIOR TO ANY GROUND DISTURBANCE. THE MMRD WILL BE INSPECTING FOR APPLICABLE EROSION CONTROL AND SEDIMENT CONTROL MEASURES SUCH AS SILT FENCING, INLET PROTECTION, CONCRETE WASH, ETC., FOLLOWED BY SANITARY SEMER AND VOLUME CONTROL INSTALLATION INSPECTIONS. PLEASE REFER TO THE APPROVED PERMIT/PLANS AND HAVE THESE MEASURES IN PLACE IN ACCORDANCE WITH THE SPECIFICATIONS.


SWCD FOR BID 1/23/20 DRAWN: PS 1911354C

T-1.0

8/23/19

9/17/19

11/25/19

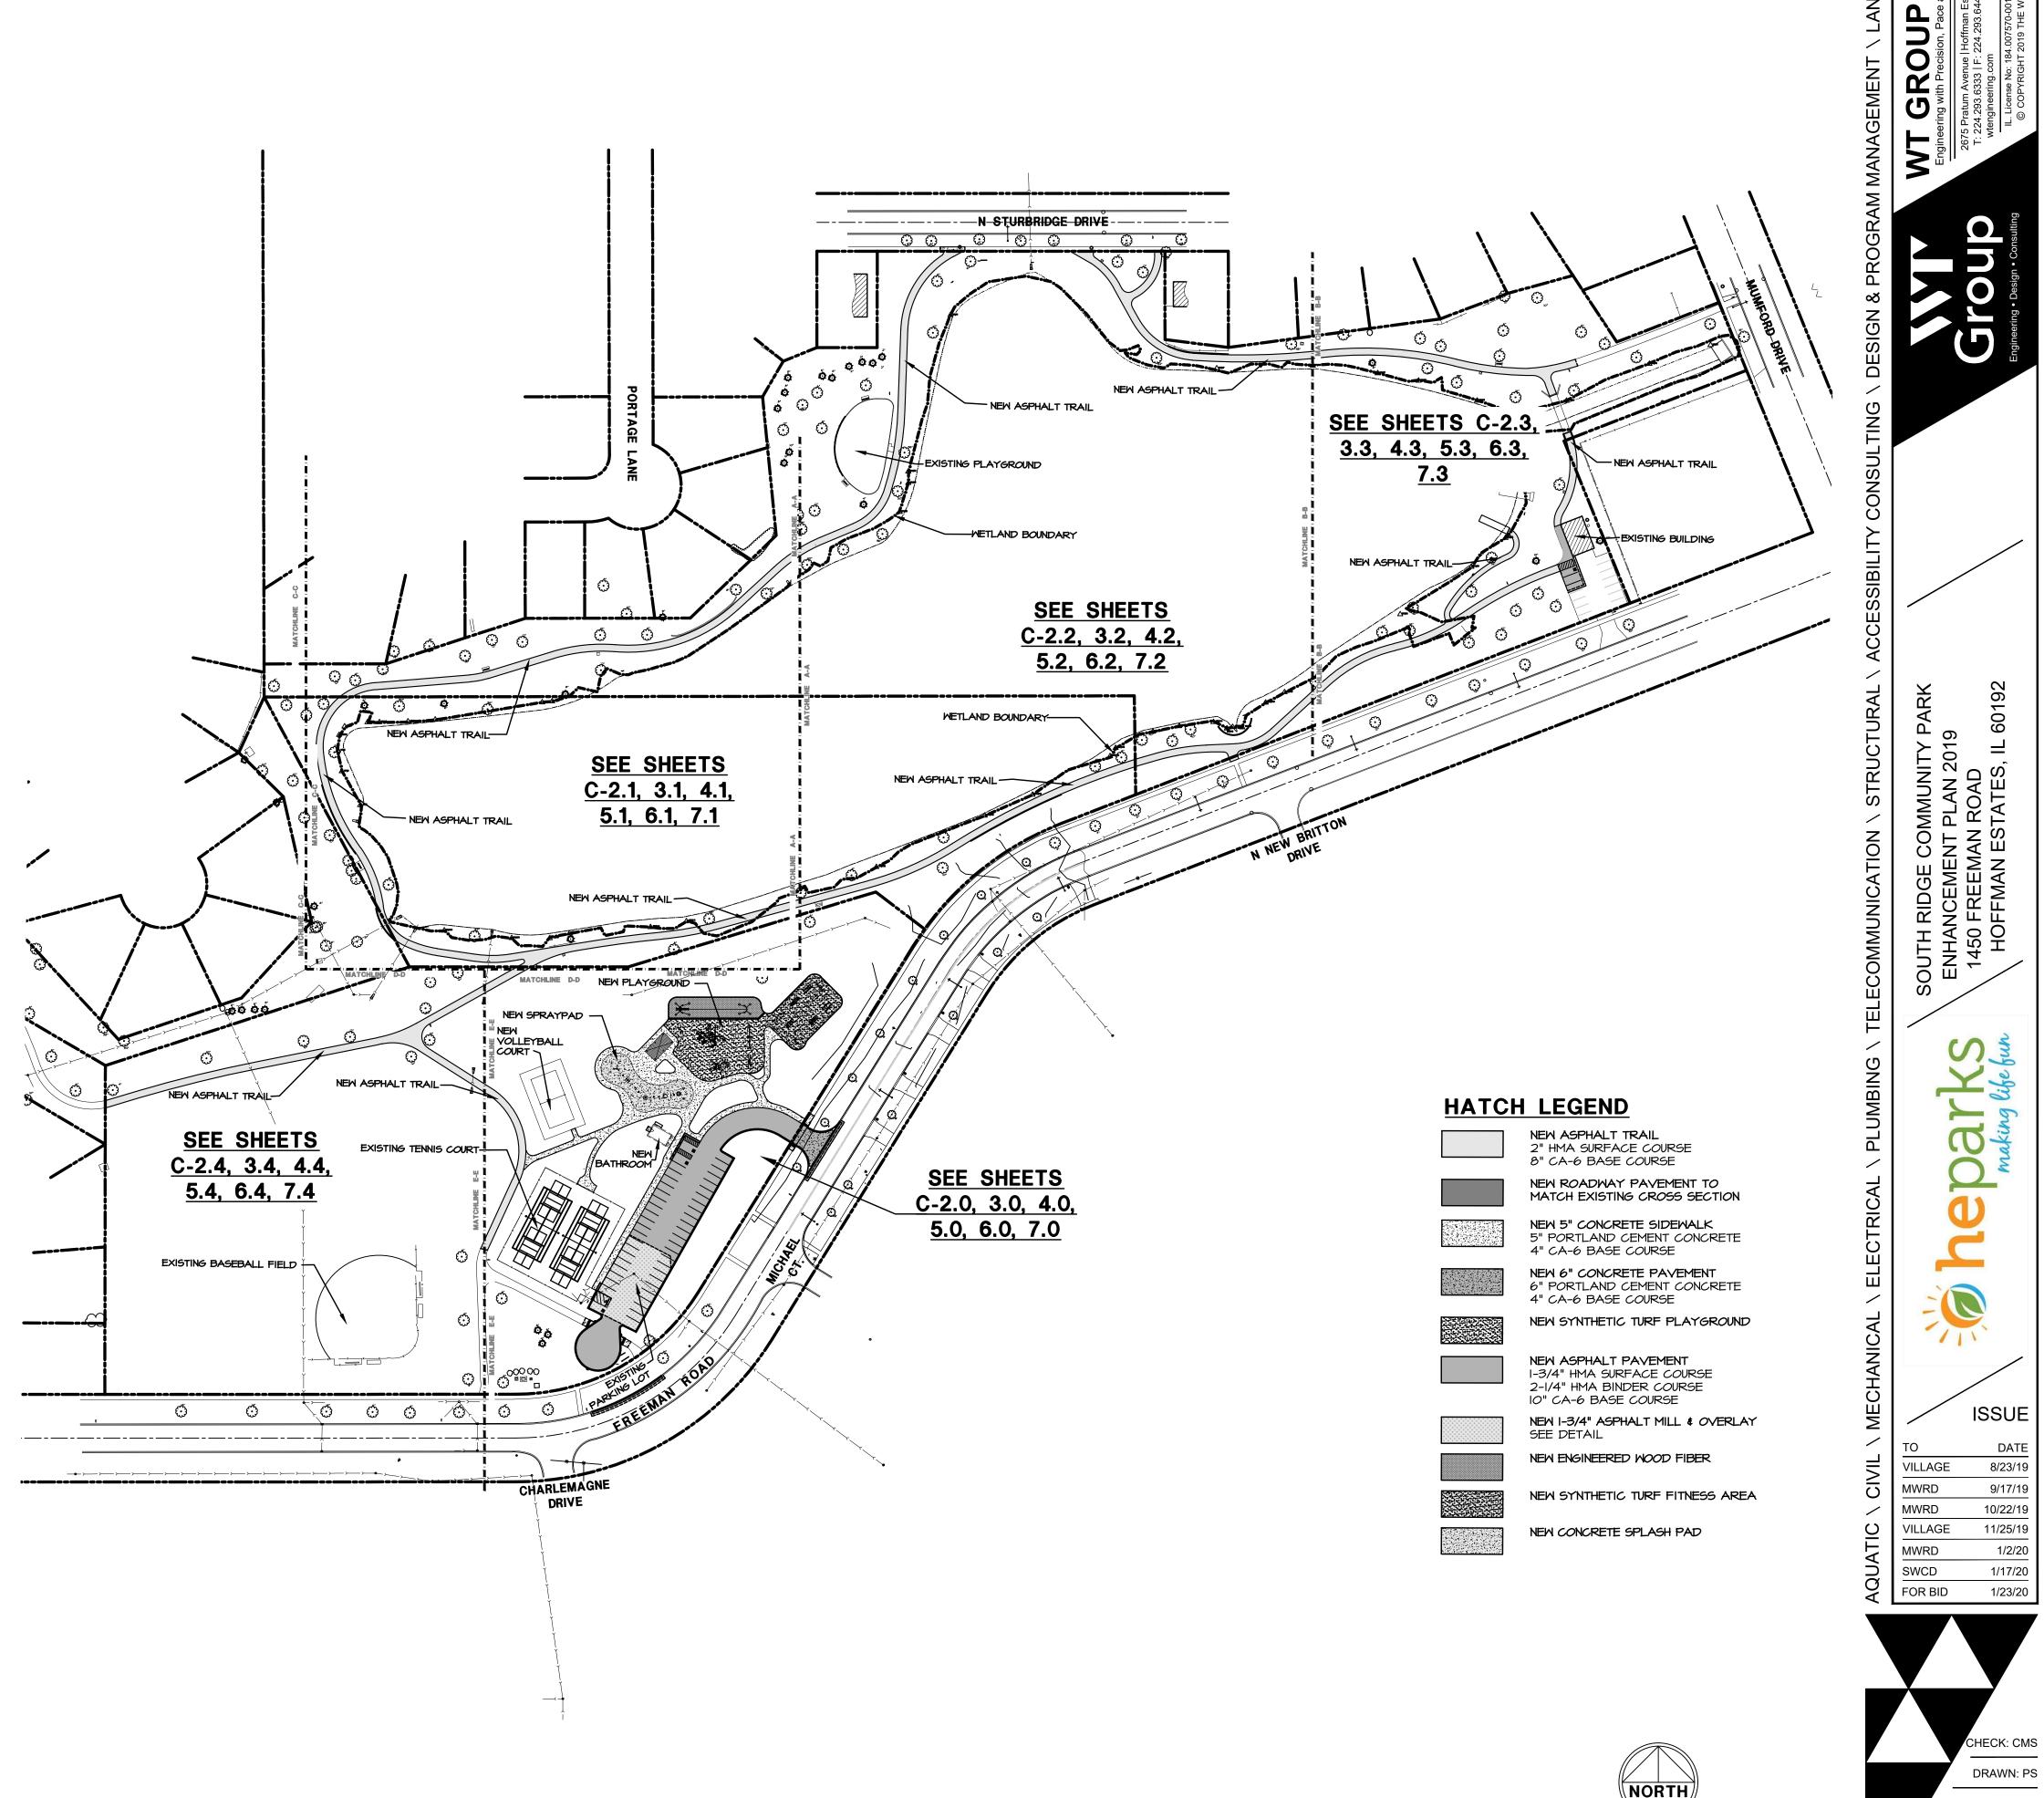


C-1.0
OVERALL SITE PLAN

400

|" = |00'

200

00 50 100

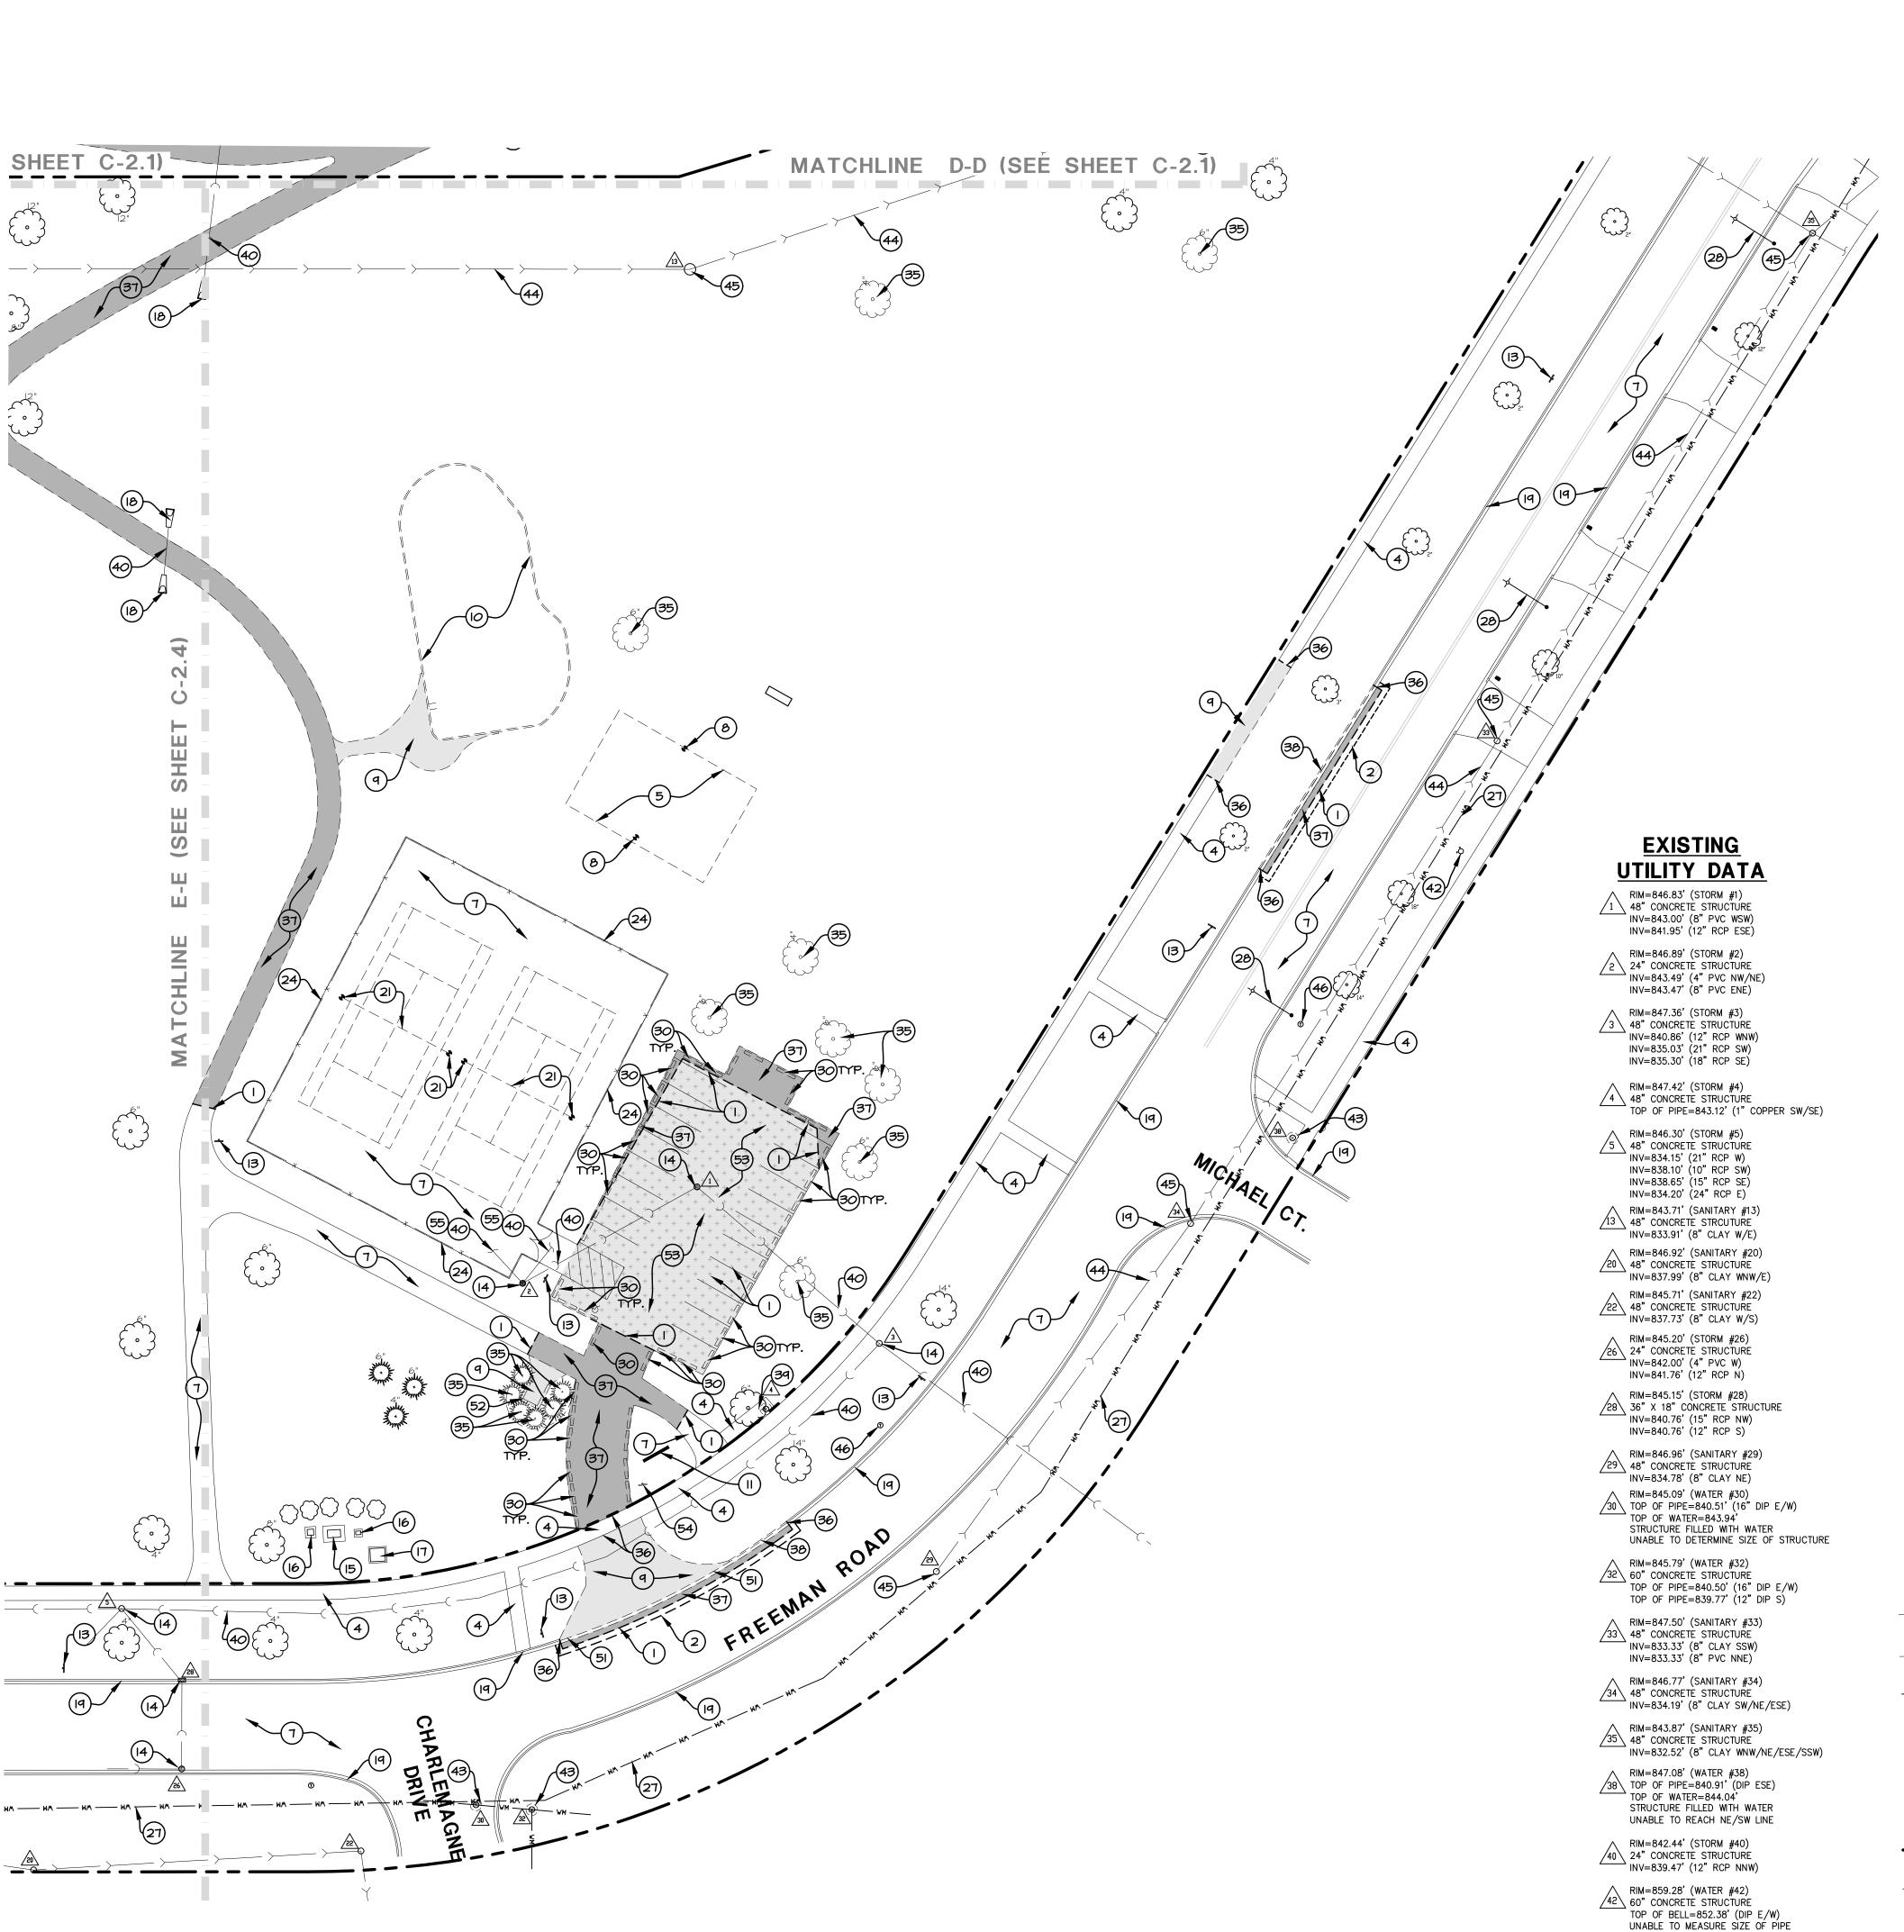

PROJECT NOTES:

- NEW FULL DEPTH SAWCUT OF EXISTING ASPHALT PAVEMENT TO PROVIDE CLEAN CONSTRUCTION BREAK. 2. NEW 2' BUTT JOINT.
- 3. EXISTING PAVEMENT STRIPING TO REMAIN. 4. EXISTING CONCRETE SIDEWALK TO REMAIN.
- 5. EXISTING SAND VOLLEYBALL COURT TO BE REMOVED FULL DEPTH.
- 6. EXISTING CONCRETE PAVEMENT TO REMAIN. . EXISTING ASPHALT PAVEMENT TO REMAIN. 8. EXISTING VOLLEYBALL COURT POST AND NET TO BE
- REMOVED. EXISTING CONCRETE TO BE REMOVED FULL DEPTH TO MEET THE BOTTOM OF THE PROPOSED PAVEMENT CROSS SECTIONS (PROPOSED SUBGRADE ELEVATION). SEE THE SITE DEVELOPMENT PLAN FOR THE PROPOSED PAVEMENT CROSS SECTIONS AND THE SITE GRADING PLAN FOR THE PROPOSED FINISHED
- IO. EXISTING PLAYGROUND TO BE REMOVED.
- EXISTING I.D. SIGN TO BE REMOVED AND SALVAGED. 12. EXISTING CONCRETE WALL TO REMAIN.
- 13. EXISTING SIGN TO REMAIN. 14. EXISTING STORM STRUCTURE TO REMAIN.
- 15. EXISTING GENERATOR TO REMAIN.
- 16. EXISTING ELECTRIC METER TO REMAIN. 17. EXISTING TRANSFORMER TO REMAIN.
- 18. EXISTING FLARED END SECTION TO REMAIN. 19. EXISTING CURB AND GUTTER TO REMAIN. 20. EXISTING DEPRESSED CURB AND GUTTER TO REMAIN.
- 21. EXISTING TENNIS COURT POST AND NET TO REMAIN. 22. NEW FULL DEPTH SAWCUT OF EXISTING CONCRETE TO PROVIDE CLEAN CONSTRUCTION BREAK AT NEAREST
- 23. EXISTING BENCH ON CONCRETE PAD TO REMAIN. 24. EXISTING FENCE TO REMAIN. PROTECT DURING CONSTRUCTION.
- 25. EXISTING ASPHALT TRAIL TO REMAIN. 26. EXISTING BASKETBALL COURT TO REMAIN.
- 27. EXISTING WATERMAIN PER VILLAGE RECORDS TO 28. EXISTING STREET LIGHT TO REMAIN.
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- 31. EXISTING BUILDING TO REMAIN. 32. EXISTING TRASH CAN ON CONCRETE PAD TO REMAIN. 33. EXISTING BRIDGE TO REMAIN.
- 34. EXISTING BLOCK WALL TO REMAIN. 35. EXISTING TREE TO BE REMOVED.
- 36. NEW FULL DEPTH SAWCUT OF EXISTING CONCRETE TO PROVIDE CLEAN CONSTRUCTION BREAK.
- 37. EXISTING ASPHALT PAVEMENT TO BE REMOVED FULL DEPTH TO MEET THE BOTTOM OF THE PROPOSED PAVEMENT CROSS SECTIONS (PROPOSED SUBGRADE ELEVATION). SEE THE SITE DEVELOPMENT PLAN FOR THE PROPOSED PAVEMENT CROSS SECTIONS AND THE SITE GRADING PLAN FOR THE PROPOSED FINISHED GRADES.
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- 43. EXISTING VALVE VAULT TO REMAIN. 44. EXISTING SANITARY SEWER TO REMAIN.
- 45. EXISTING SANITARY STRUCTURE TO REMAIN. 46. EXISTING TELCO PEDISTAL TO REMAIN.
- 47. EXISTING FLARED END SECTION TO BE REMOVED AND SALVAGED.
- 48. EXISTING OUTLET CONTROL STRUCTURE AND OVERFLOW WEIR TO REMAIN. 49. EXISTING WOOD DOCK TO REMAIN.
- 50. EXISTING ADA PARKING STALL TO BE REMOVED AND SALVAGED.
- 51. EXISTING DEPRESSED CURB AND GUTTER TO BE REMOVED.
- 52. EXISTING WOOD FENCE TO BE REMOVED.
- 53. EXISTING ASPHALT PAVEMENT TO BE MILLED TO A DEPTH OF 1.75". 54. EXISTING SIGN TO BE REMOVED.
- 55. CONTRACTOR SHALL TRACE UTILITY ROUTING PRIOR TO CONSTRUCTION. NOTIFY ENGINEER IMMEDIATELY IF CONFLICTS EXIST.

HATCH LEGEND

EXISTING CONCRETE PAVEMENT TO

BE REMOVED FULL DEPTH

EXISTING ASPHALT PAYEMENT TO BE REMOVED FULL DEPTH EXISTING ASPHALT PAVEMENT TO BE

EXISTING MANHOLE

MILLED TO A DEPTH OF 1.75"

DEMOLITION LEGEND

EXISTING WATER STRUCTURE EXISTING B-BOX EXISTING STREET LIGHT

EXISTING FIRE HYDRANT EXISTING UTILITY POLE

EXISTING FLARED END SECTION EXISTING TREE

EXISTING SANITARY SEWER

EXISTING SIGN

EXISTING STORM SEWER

EXISTING WATER MAIN

EXISTING VALVE WITH VAULT

WETLAND BOUNDARY

NORMAL WATER LEVEL

EXISTING TELCO PEDESTAL

EXISTING FIRE HYDRANT



KEYMAP \langle NORTHhoSCALE: N.T.S.

SITE DEMOLITION NOTES:

- A. CONTRACTOR SHALL PERFORM ALL DEMOLITION WORK IN ACCORDANCE WITH ALL APPLICABLE FEDERAL, STATE, AND LOCAL REQUIREMENTS.
- B. THE CONTRACTOR SHALL OBTAIN ALL NECESSARY DEMOLITION PERMITS AND COORDINATE ALL DEMOLITION WITH THE MUNICIPALITY AND OWNERS REPRESENTATIVE TO ENSURE PROTECTION AND MAINTENANCE OF SANITARY AND WATER UTILITIES AS NECESSARY AND TO PROVIDE STORM WATER CONVEYANCE UNTIL NEW FACILITIES ARE CONSTRUCTED, TESTED, AND PLACED IN OPERATION.
- C. CONTRACTOR SHALL DEVELOP AND IMPLEMENT A DAILY PROGRAM OF DUST CONTROL PROCEDURES PRIOR TO DEMOLITION OF ANY STRUCTURES. MODIFICATION OF DUST CONTROL PROCEDURES SHALL BE PERFORMED BY THE CONTRACTOR TO THE SATISFACTION OF THE MUNICIPALITY AND COMPLY WITH THE NPDES II REQUIREMENTS OF THE ILLINOIS ENVIRONMENTAL PROTECTION AGENCY AND THE INDIVIDUAL STORM WATER POLLUTION PREVENTION PLAN FOR THIS PROJECT.
- D. ALL EXISTING TREES, BRUSH AND MISCELLANEOUS VEGETATION TO BE REMOVED OR DEMOLISHED SHALL BE REMOVED FROM THE SITE AND LEGALLY DISPOSED OF BY THE CONTRACTOR. VOIDS LEFT BY ANY ITEM REMOVED UNDER ANY PROPOSED
- BUILDING, PAVEMENT, OR WALK OR WITHIN 24" THEREOF SHALL BE BACKFILLED WITH ENGINEERED FILL ACCORDING TO THE GEOTECHNICAL REPORT. F. ALL EXISTING BUILDINGS, FOUNDATIONS, CONCRETE OR ASPHALT
- PAVEMENT OR WALKS, CURB AND GUTTER AND MISCELLANEOUS STRUCTURES (INCLUDING, BUT NOT LIMITED TO FENCES, POLES, YARD LIGHTS, ELECTRICAL PANELS, AND MISCELLANEOUS DEBRIS) INDICATED TO BE DEMOLISHED SHALL BE REMOVED OR DEMOLISHED AND REMOVED FROM THE SITE AND DISPOSED OF LEGALLY BY THE CONTRACTOR.
- G. CONTACT GAS COMPANY PRIOR TO DEMOLITION. LOCATION OF EXISTING GAS SERVICES ARE UNKNOWN.
- H. ALL EXISTING TREES SHALL REMAIN UNLESS OTHERWISE NOTED. ALL EXISTING UTILITIES SHALL REMAIN UNLESS OTHERWISE NOTED. J. CONTRACTOR SHALL HIRE A PRIVATE UTILITY LOCATOR TO LOCATE UTILITIES PRIOR TO CONSTRUCTION AND SHALL CONTACT THE SITE ENGINEER IF A CONFLICT EXISTS.
- K. CONTRACTOR SHALL PROVIDE REMOVAL AND REPLACEMENT AND SHORING AS NECESSARY TO MEET OSHA AND LOCAL CODE, AS WELL AS MANUFACTURER'S REQUIREMENTS.
- ALL FOUNDATIONS FOR ALL FENCES, SIGNS, ETC. NOTED FOR REMOVAL SHALL BE REMOVED AND LEGALLY DISPOSED OF
- M. PROOF-ROLLING SHALL BE PERFORMED FOR ALL SUBGRADE PRIOR TO CONSTRUCTION OF NEW PAVEMENT. ALL SUBGRADE PROOF-ROLLING SHALL BE WITNESSED AND APPROVED BY A MATERIALS TESTING AGENCY TO BE HIRED BY THE OWNER. CONTRACTOR TO COORDINATE ALL PROOF-ROLLING WITH THE MATERIALS TESTING AGENCY. CONTACT THE ENGINEER AND MATERIAL TESTING AGENCY SO THAT THEY MAY WITNESS THE PROOF ROLL. PROOF ROLL SHALL BE PROVIDED FOR ALL PAVEMENT AREAS SPECIFIED FOR FULL DEPTH REMOVAL AND REPLACEMENT.
- N. EXISTING CONDITIONS AND TOPOGRAPHY SHOWN REPRESENTS SITE CONDITIONS PER THE PLAT OF SURVEY LAST DATED 6-16-2009, PREPARED BY ENGINEERING RESOURCE ASSOCIATES INC. CONTRACTOR SHALL FIELD VERIFY EXISTING ELEVATIONS AND CONDITIONS (INCLUDING BUT NOT LIMITED TO VERIFICATION OF CONTROL AND ALL UTILITIES WHETHER DEPICTED OR NOT) PRIOR TO CONSTRUCTION AND NOTIFY ENGINEER OF ANY
- DISCREPANCIES. N.A. ADDITIONAL EXISTING TOPOGRAPHY AND UTILITY DATA SHOWN REPRESENTS SITE CONDITIONS MEASURED BY WT LAND SURVEYING INC. ON 7-24-19.
- UTILITY DATA. P. CLEAR SITE AS NECESSARY TO CONSTRUCT PROPOSED


O. SEE SHEETS I-4 "PLAT OF SURVEY" FOR ALL EXISTING LOCATED

- IMPROVEMENTS. Q. ALL ITEMS MARK "EXISTING OR EXISTING TO REMAIN" TO BE
- PROTECTED FROM DAMAGE FOR THE DURATION OF CONSTRUCTION. R. CONTRACTOR TO PROVIDE SOIL TESTING SERVICES FOR COMPLETION OF THE ILLINOIS ENVIRONMENTAL PROTECTION AGENCY'S LPC-662 AND/OR LPC-663 FORMS AS PART OF THEIR
- CONTRACT. S. ALL EXISTING UTILITIES TO BE ABANDONED IN PLACE SHALL BE CAPPED WITH 2' LONG (MIN.) NON-SHRINK CONCRETE MORTAR PLUGS AT BOTH ENDS.

I" = 30'


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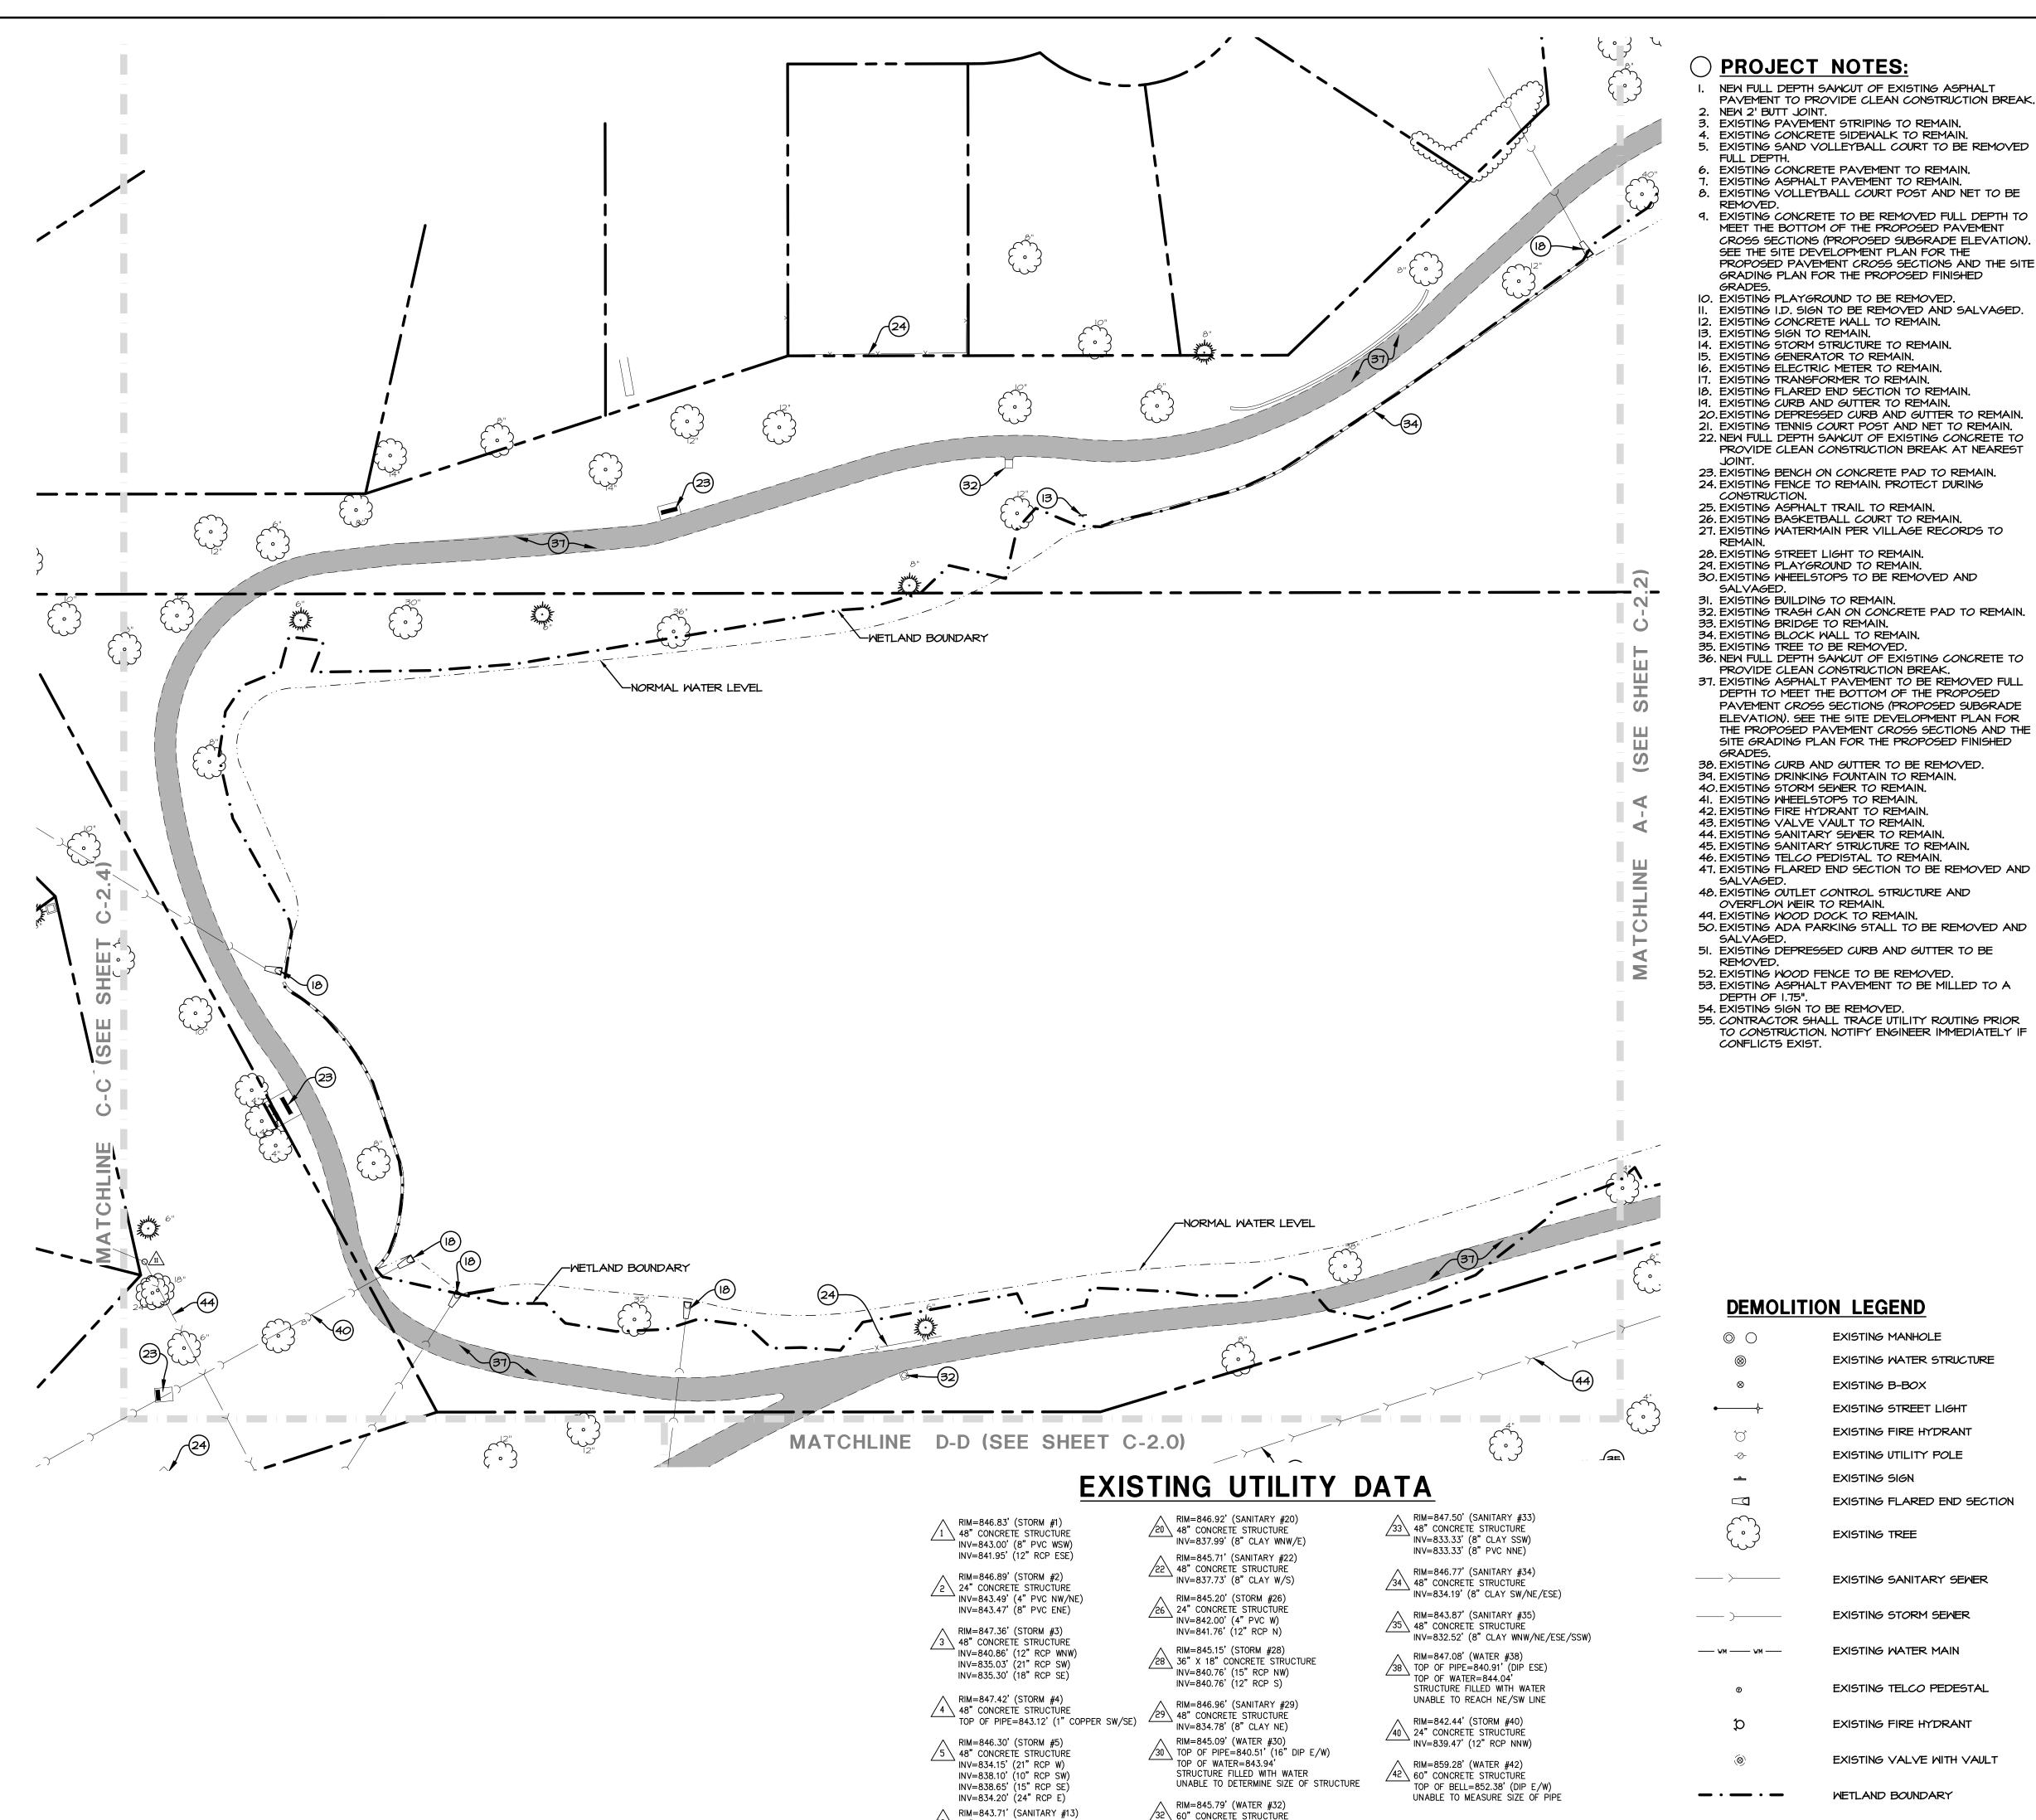
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120 C-2.0 SITE DEMOLITION PLAN

HECK: CMS DRAWN: PS 1911354C

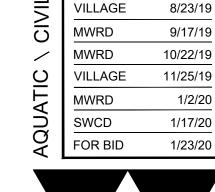

\ 48" CONCRETE STRCUTURE

NV=833.91' (8" CLAY W/E)

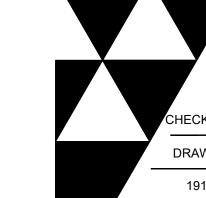TOP OF PIPE=840.50' (16" DIP E/W)

TOP OF PIPE=839.77' (12" DIP S)

) PROJECT NOTES:

- NEW FULL DEPTH SAWCUT OF EXISTING ASPHALT PAVEMENT TO PROVIDE CLEAN CONSTRUCTION BREAK. NEW 2' BUTT JOINT.
- 3. EXISTING PAVEMENT STRIPING TO REMAIN. 4. EXISTING CONCRETE SIDEWALK TO REMAIN. 5. EXISTING SAND VOLLEYBALL COURT TO BE REMOVED
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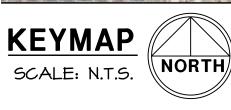
| ⊗ | EXISTING WATER STRUCTURE |
|-------------------------------|-----------------------------|
| 8 | EXISTING B-BOX |
| ← | EXISTING STREET LIGHT |
| $\overleftarrow{\mathcal{O}}$ | EXISTING FIRE HYDRANT |
| -⊘- | EXISTING UTILITY POLE |
| <u> </u> | EXISTING SIGN |
| | EXISTING FLARED END SECTION |
| | EXISTING TREE |
| > | EXISTING SANITARY SEMER |
|) | EXISTING STORM SEWER |
| | EXISTING WATER MAIN |
| Θ | EXISTING TELCO PEDESTAL |
| ¢ | EXISTING FIRE HYDRANT |
| ⊗ | EXISTING VALVE WITH VAULT |
| | WETLAND BOUNDARY |
| | NORMAL WATER LEVEL |

EXISTING MANHOLE



NITY P, 1 2019

ENF 14



SITE DEMOLITION NOTES:

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- AS WELL AS MANUFACTURER'S REQUIREMENTS. ALL FOUNDATIONS FOR ALL FENCES, SIGNS, ETC. NOTED FOR REMOVAL SHALL BE REMOVED AND LEGALLY DISPOSED OF OFFSITE.
- M. PROOF-ROLLING SHALL BE PERFORMED FOR ALL SUBGRADE PRIOR TO CONSTRUCTION OF NEW PAYEMENT, ALL SUBGRADE PROOF-ROLLING SHALL BE WITNESSED AND APPROVED BY A MATERIALS TESTING AGENCY TO BE HIRED BY THE OWNER. CONTRACTOR TO COORDINATE ALL PROOF-ROLLING WITH THE MATERIALS TESTING AGENCY. CONTACT THE ENGINEER AND MATERIAL TESTING AGENCY SO THAT THEY MAY WITNESS THE PROOF ROLL. PROOF ROLL SHALL BE PROVIDED FOR ALL PAVEMENT AREAS SPECIFIED FOR FULL DEPTH REMOVAL AND REPLACEMENT.
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- P. CLEAR SITE AS NECESSARY TO CONSTRUCT PROPOSED IMPROVEMENTS. Q. ALL ITEMS MARK "EXISTING OR EXISTING TO REMAIN" TO BE
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AGENCY'S LPC-662 AND/OR LPC-663 FORMS AS PART OF THEIR

CONTRACT. S. ALL EXISTING UTILITIES TO BE ABANDONED IN PLACE SHALL BE CAPPED WITH 2' LONG (MIN.) NON-SHRINK CONCRETE MORTAR PLUGS AT BOTH ENDS.

HATCH LEGEND

EXISTING CONCRETE PAVEMENT TO BE REMOVED FULL DEPTH EXISTING ASPHALT PAVEMENT TO BE REMOVED FULL DEPTH EXISTING ASPHALT PAVEMENT TO BE MILLED TO A DEPTH OF 1.75"



120




1" = 30' 00 15 30 60

HECK: CMS DRAWN: PS 1911354C

VILLAGE

8/23/19

C-2.1 SITE DEMOLITION PLAN

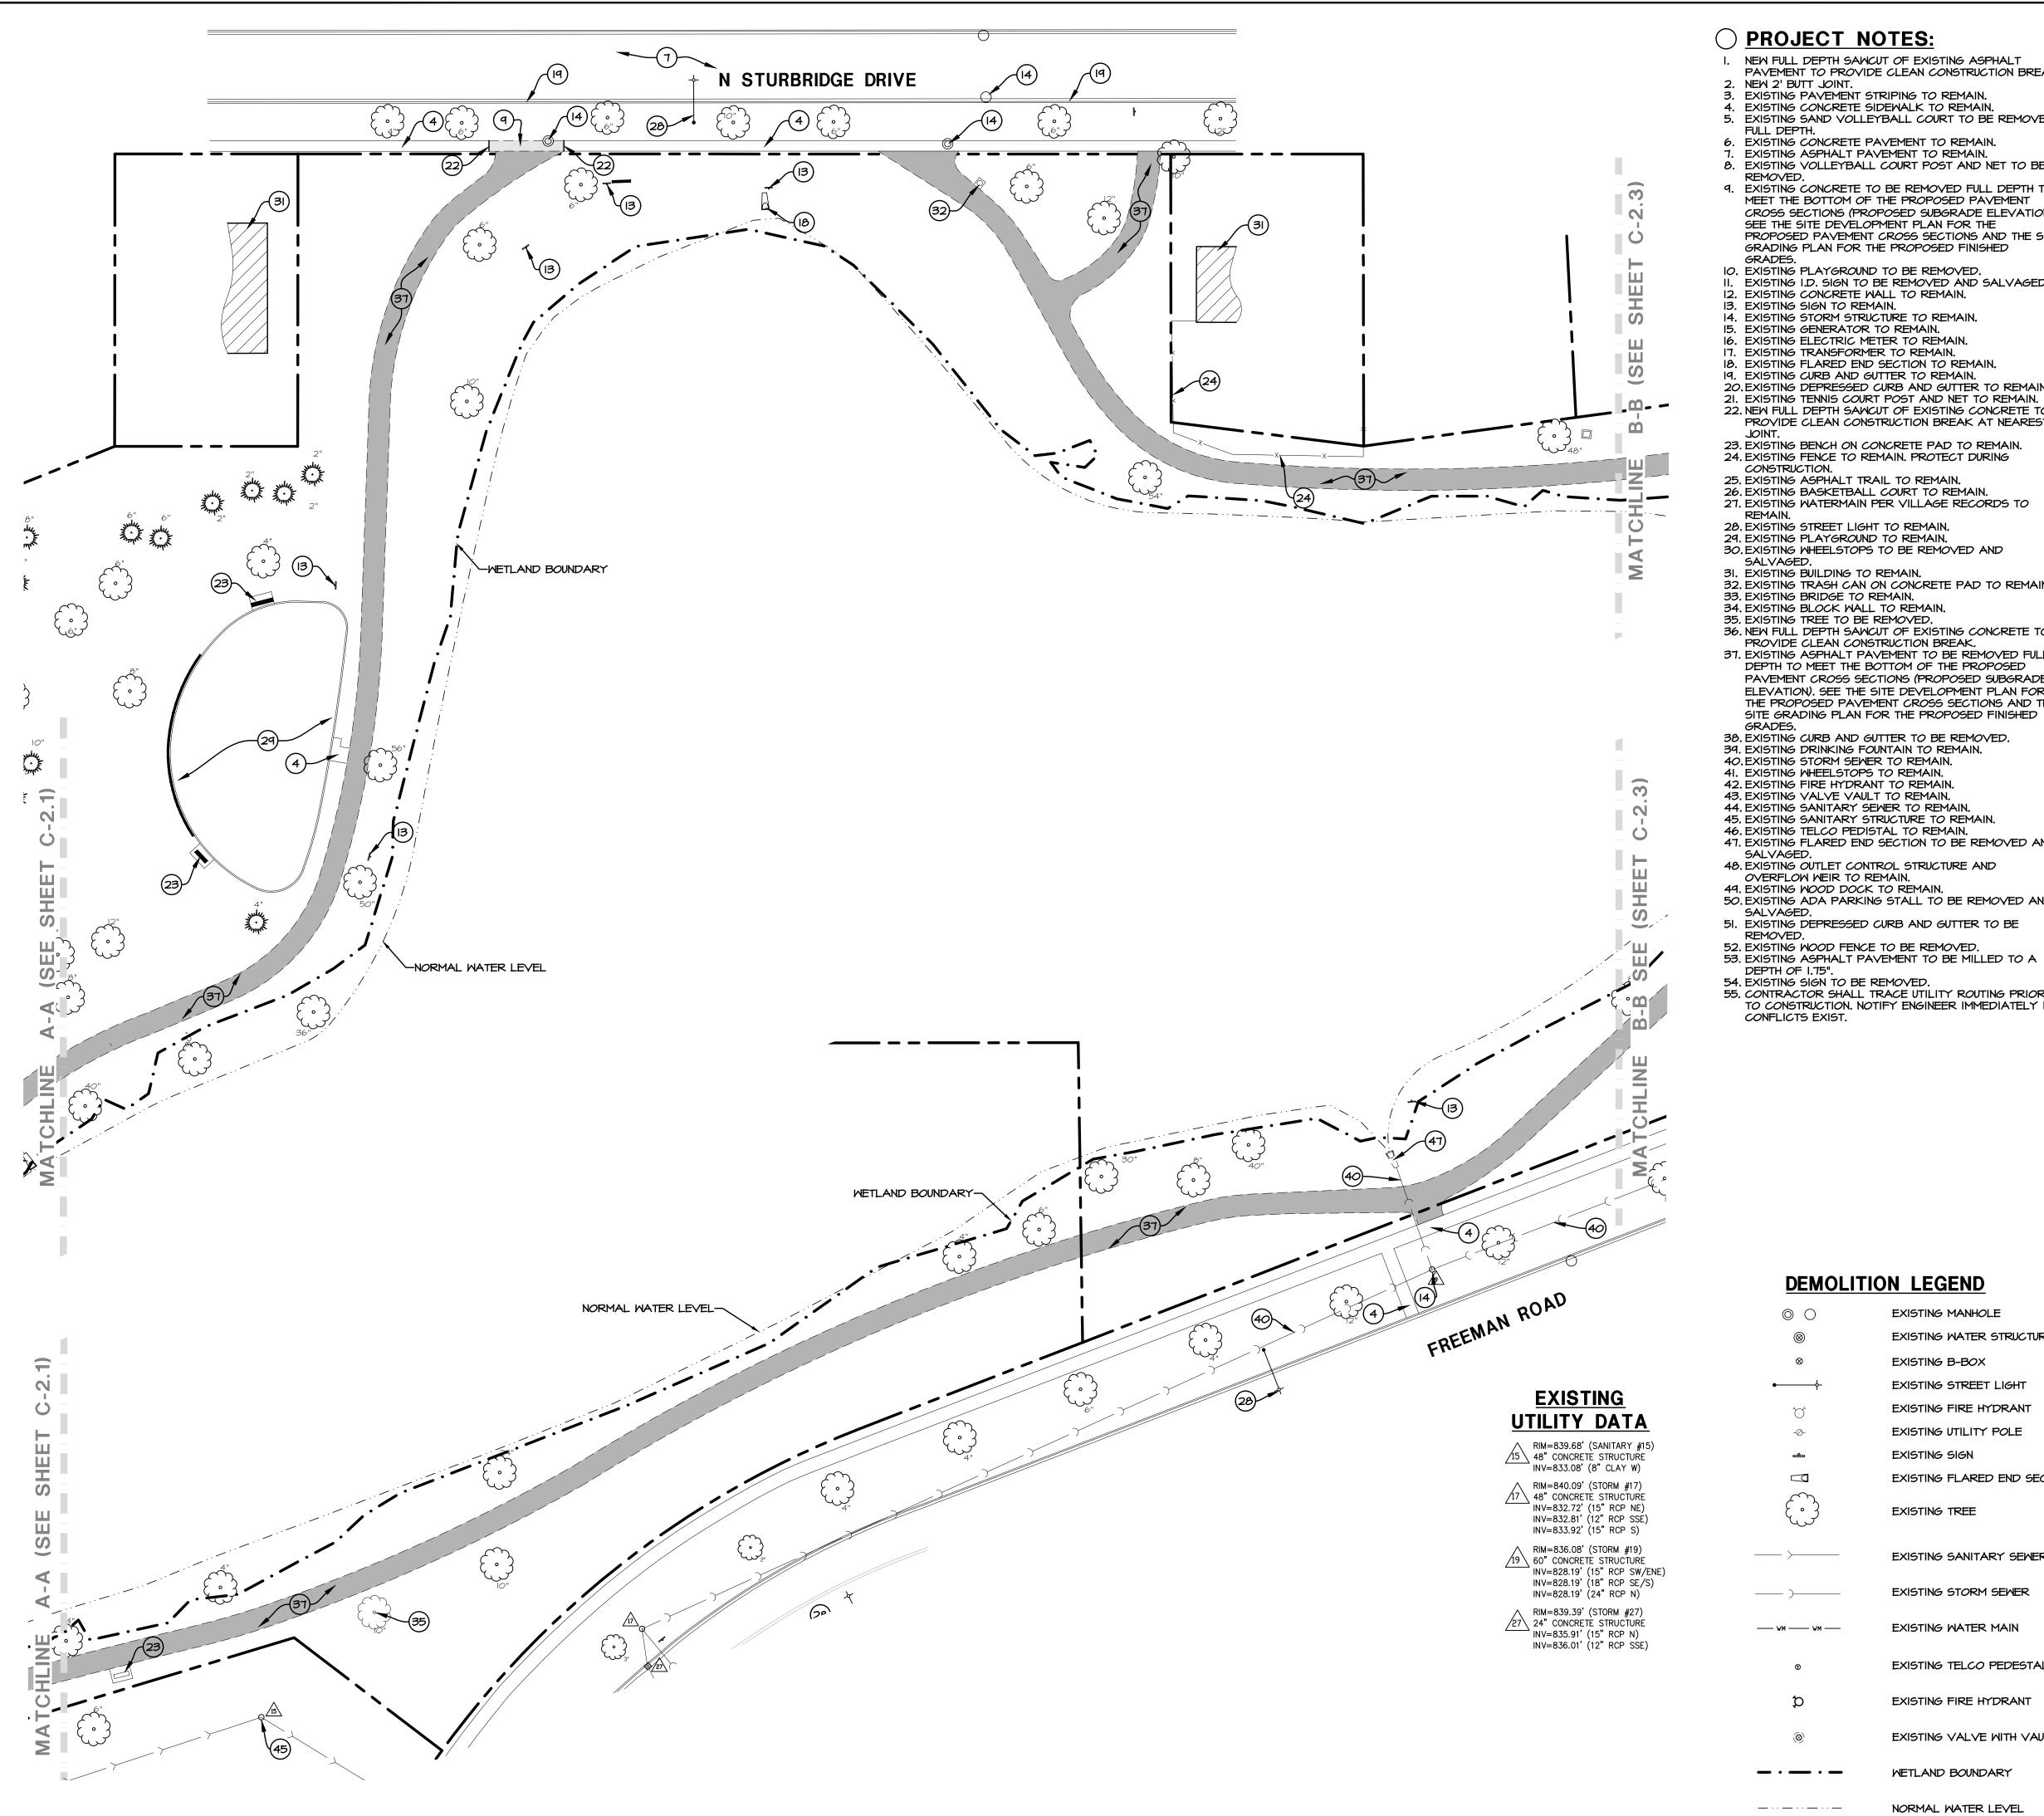

PROJECT NOTES:

- NEW FULL DEPTH SAWCUT OF EXISTING ASPHALT PAVEMENT TO PROVIDE CLEAN CONSTRUCTION BREAK.
- NEW 2' BUTT JOINT. EXISTING PAVEMENT STRIPING TO REMAIN.
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- 35. EXISTING TREE TO BE REMOVED. 36. NEW FULL DEPTH SAWCUT OF EXISTING CONCRETE TO
- 37. EXISTING ASPHALT PAVEMENT TO BE REMOVED FULL DEPTH TO MEET THE BOTTOM OF THE PROPOSED PAVEMENT CROSS SECTIONS (PROPOSED SUBGRADE ELEVATION). SEE THE SITE DEVELOPMENT PLAN FOR THE PROPOSED PAVEMENT CROSS SECTIONS AND THE
- 38. EXISTING CURB AND GUTTER TO BE REMOVED.
- 39. EXISTING DRINKING FOUNTAIN TO REMAIN. 40. EXISTING STORM SEWER TO REMAIN.
- 41. EXISTING WHEELSTOPS TO REMAIN. 42. EXISTING FIRE HYDRANT TO REMAIN.
- 43. EXISTING VALVE VAULT TO REMAIN.
- 44. EXISTING SANITARY SEWER TO REMAIN. 45. EXISTING SANITARY STRUCTURE TO REMAIN.
- 46. EXISTING TELCO PEDISTAL TO REMAIN. 47. EXISTING FLARED END SECTION TO BE REMOVED AND
- SALVAGED. 48. EXISTING OUTLET CONTROL STRUCTURE AND OVERFLOW WEIR TO REMAIN.
- 49. EXISTING WOOD DOCK TO REMAIN. 50. EXISTING ADA PARKING STALL TO BE REMOVED AND
- SALVAGED. 51. EXISTING DEPRESSED CURB AND GUTTER TO BE
- REMOVED. 52. EXISTING WOOD FENCE TO BE REMOVED.
- 53. EXISTING ASPHALT PAVEMENT TO BE MILLED TO A DEPTH OF 1.75".
- 54. EXISTING SIGN TO BE REMOVED. 55. CONTRACTOR SHALL TRACE UTILITY ROUTING PRIOR TO CONSTRUCTION. NOTIFY ENGINEER IMMEDIATELY IF

DEMOLITION LEGEND

 \odot

EXISTING MANHOLE

EXISTING B-BOX

EXISTING SIGN

EXISTING TREE

EXISTING WATER STRUCTURE

EXISTING STREET LIGHT

EXISTING FIRE HYDRANT

EXISTING UTILITY POLE

EXISTING FLARED END SECTION

EXISTING SANITARY SEWER

EXISTING STORM SEWER

EXISTING WATER MAIN

EXISTING TELCO PEDESTAL

EXISTING FIRE HYDRANT

METLAND BOUNDARY

NORMAL WATER LEVEL

EXISTING VALVE WITH VAULT



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ENF 14



SITE DEMOLITION NOTES:

- A. CONTRACTOR SHALL PERFORM ALL DEMOLITION WORK IN ACCORDANCE WITH ALL APPLICABLE FEDERAL, STATE, AND LOCAL REQUIREMENTS.
- B. THE CONTRACTOR SHALL OBTAIN ALL NECESSARY DEMOLITION PERMITS AND COORDINATE ALL DEMOLITION WITH THE MUNICIPALITY AND OWNERS REPRESENTATIVE TO ENSURE PROTECTION AND MAINTENANCE OF SANITARY AND WATER UTILITIES AS NECESSARY AND TO PROVIDE STORM WATER CONVEYANCE UNTIL NEW FACILITIES ARE CONSTRUCTED, TESTED,
- AND PLACED IN OPERATION. C. CONTRACTOR SHALL DEVELOP AND IMPLEMENT A DAILY PROGRAM OF DUST CONTROL PROCEDURES PRIOR TO DEMOLITION OF ANY STRUCTURES. MODIFICATION OF DUST CONTROL PROCEDURES SHALL BE PERFORMED BY THE CONTRACTOR TO THE SATISFACTION OF THE MUNICIPALITY AND COMPLY WITH THE NPDES II REQUIREMENTS OF THE ILLINOIS ENVIRONMENTAL PROTECTION AGENCY AND THE INDIVIDUAL STORM WATER POLLUTION PREVENTION PLAN FOR THIS PROJECT.
- TO BE REMOVED OR DEMOLISHED SHALL BE REMOVED FROM THE SITE AND LEGALLY DISPOSED OF BY THE CONTRACTOR. E. VOIDS LEFT BY ANY ITEM REMOVED UNDER ANY PROPOSED BUILDING, PAVEMENT, OR WALK OR WITHIN 24" THEREOF SHALL BE BACKFILLED WITH ENGINEERED FILL ACCORDING TO THE

D. ALL EXISTING TREES, BRUSH AND MISCELLANEOUS VEGETATION

- GEOTECHNICAL REPORT. F. ALL EXISTING BUILDINGS, FOUNDATIONS, CONCRETE OR ASPHALT PAVEMENT OR WALKS, CURB AND GUTTER AND MISCELLANEOUS STRUCTURES (INCLUDING, BUT NOT LIMITED TO FENCES, POLES, YARD LIGHTS, ELECTRICAL PANELS, AND MISCELLANEOUS DEBRIS) INDICATED TO BE DEMOLISHED SHALL BE REMOVED OR DEMOLISHED AND REMOVED FROM THE SITE AND DISPOSED OF
- LEGALLY BY THE CONTRACTOR. G. CONTACT GAS COMPANY PRIOR TO DEMOLITION. LOCATION OF
- EXISTING GAS SERVICES ARE UNKNOWN. H. ALL EXISTING TREES SHALL REMAIN UNLESS OTHERWISE NOTED. ALL EXISTING UTILITIES SHALL REMAIN UNLESS OTHERWISE NOTED. J. CONTRACTOR SHALL HIRE A PRIVATE UTILITY LOCATOR TO

LOCATE UTILITIES PRIOR TO CONSTRUCTION AND SHALL CONTACT

- THE SITE ENGINEER IF A CONFLICT EXISTS. K. CONTRACTOR SHALL PROVIDE REMOVAL AND REPLACEMENT AND SHORING AS NECESSARY TO MEET OSHA AND LOCAL CODE,
- AS WELL AS MANUFACTURER'S REQUIREMENTS. ALL FOUNDATIONS FOR ALL FENCES, SIGNS, ETC. NOTED FOR REMOVAL SHALL BE REMOVED AND LEGALLY DISPOSED OF
- OFFSITE. PROOF-ROLLING SHALL BE PERFORMED FOR ALL SUBGRADE PRIOR TO CONSTRUCTION OF NEW PAVEMENT. ALL SUBGRADE PROOF-ROLLING SHALL BE WITNESSED AND APPROVED BY A MATERIALS TESTING AGENCY TO BE HIRED BY THE OWNER. CONTRACTOR TO COORDINATE ALL PROOF-ROLLING WITH THE MATERIALS TESTING AGENCY. CONTACT THE ENGINEER AND MATERIAL TESTING AGENCY SO THAT THEY MAY WITNESS THE PROOF ROLL. PROOF ROLL SHALL BE PROVIDED FOR ALL PAVEMENT AREAS SPECIFIED FOR FULL DEPTH REMOVAL AND
- N. EXISTING CONDITIONS AND TOPOGRAPHY SHOWN REPRESENTS SITE CONDITIONS PER THE PLAT OF SURVEY LAST DATED 6-16-2009, PREPARED BY ENGINEERING RESOURCE ASSOCIATES INC. CONTRACTOR SHALL FIELD VERIFY EXISTING ELEVATIONS AND CONDITIONS (INCLUDING BUT NOT LIMITED TO VERIFICATION OF CONTROL AND ALL UTILITIES WHETHER DEPICTED OR NOT) PRIOR TO CONSTRUCTION AND NOTIFY ENGINEER OF ANY DISCREPANCIES.
- N.A. ADDITIONAL EXISTING TOPOGRAPHY AND UTILITY DATA SHOWN REPRESENTS SITE CONDITIONS MEASURED BY WT LAND SURVEYING INC. ON 7-24-19.
- O. SEE SHEETS 1-4 "PLAT OF SURVEY" FOR ALL EXISTING LOCATED UTILITY DATA.
- P. CLEAR SITE AS NECESSARY TO CONSTRUCT PROPOSED IMPROVEMENTS.
- Q. ALL ITEMS MARK "EXISTING OR EXISTING TO REMAIN" TO BE PROTECTED FROM DAMAGE FOR THE DURATION OF CONSTRUCTION. R. CONTRACTOR TO PROVIDE SOIL TESTING SERVICES FOR

COMPLETION OF THE ILLINOIS ENVIRONMENTAL PROTECTION

AGENCY'S LPC-662 AND/OR LPC-663 FORMS AS PART OF THEIR CONTRACT. S. ALL EXISTING UTILITIES TO BE ABANDONED IN PLACE SHALL BE CAPPED WITH 2' LONG (MIN.) NON-SHRINK CONCRETE MORTAR PLUGS AT BOTH ENDS.

HATCH LEGEND

00 15 30

REPLACEMENT.



EXISTING ASPHALT PAVEMENT TO BE MILLED TO A DEPTH OF 1.75"



60 120

C-2.2 SITE DEMOLITION PLAN

DRAWN: PS

VILLAGE

MWRD

MWRD

MWRD

SWCD

VILLAGE

FOR BID


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11/25/19

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PROJECT NOTES:

- NEW FULL DEPTH SAWCUT OF EXISTING ASPHALT PAVEMENT TO PROVIDE CLEAN CONSTRUCTION BREAK.
- NEW 2' BUTT JOINT 3. EXISTING PAVEMENT STRIPING TO REMAIN.
- EXISTING CONCRETE SIDEWALK TO REMAIN. 5. EXISTING SAND VOLLEYBALL COURT TO BE REMOVED
- 6. EXISTING CONCRETE PAVEMENT TO REMAIN.
- EXISTING ASPHALT PAVEMENT TO REMAIN. 8. EXISTING VOLLEYBALL COURT POST AND NET TO BE
- 9. EXISTING CONCRETE TO BE REMOVED FULL DEPTH TO MEET THE BOTTOM OF THE PROPOSED PAVEMENT CROSS SECTIONS (PROPOSED SUBGRADE ELEVATION). SEE THE SITE DEVELOPMENT PLAN FOR THE PROPOSED PAYEMENT CROSS SECTIONS AND THE SITE
- IO. EXISTING PLAYGROUND TO BE REMOVED. II. EXISTING I.D. SIGN TO BE REMOVED AND SALVAGED.
- 12. EXISTING CONCRETE WALL TO REMAIN.
- 14. EXISTING STORM STRUCTURE TO REMAIN. 15. EXISTING GENERATOR TO REMAIN.
- 16. EXISTING ELECTRIC METER TO REMAIN.
- 17. EXISTING TRANSFORMER TO REMAIN. 18. EXISTING FLARED END SECTION TO REMAIN.
- 19. EXISTING CURB AND GUTTER TO REMAIN. 20. EXISTING DEPRESSED CURB AND GUTTER TO REMAIN.
- 21. EXISTING TENNIS COURT POST AND NET TO REMAIN. 22. NEW FULL DEPTH SAWCUT OF EXISTING CONCRETE TO PROVIDE CLEAN CONSTRUCTION BREAK AT NEAREST
- 23. EXISTING BENCH ON CONCRETE PAD TO REMAIN. 24. EXISTING FENCE TO REMAIN. PROTECT DURING
- CONSTRUCTION. 25. EXISTING ASPHALT TRAIL TO REMAIN. 26. EXISTING BASKETBALL COURT TO REMAIN.
- 27. EXISTING WATERMAIN PER VILLAGE RECORDS TO
- 28. EXISTING STREET LIGHT TO REMAIN. 29. EXISTING PLAYGROUND TO REMAIN. 30. EXISTING WHEELSTOPS TO BE REMOVED AND
- 31. EXISTING BUILDING TO REMAIN. 32. EXISTING TRASH CAN ON CONCRETE PAD TO REMAIN.
- 33. EXISTING BRIDGE TO REMAIN. 34. EXISTING BLOCK WALL TO REMAIN.
- 35. EXISTING TREE TO BE REMOVED. 36. NEW FULL DEPTH SAWCUT OF EXISTING CONCRETE TO
- 37. EXISTING ASPHALT PAVEMENT TO BE REMOVED FULL DEPTH TO MEET THE BOTTOM OF THE PROPOSED PAVEMENT CROSS SECTIONS (PROPOSED SUBGRADE ELEVATION). SEE THE SITE DEVELOPMENT PLAN FOR THE PROPOSED PAVEMENT CROSS SECTIONS AND THE SITE GRADING PLAN FOR THE PROPOSED FINISHED
- 38. EXISTING CURB AND GUTTER TO BE REMOVED. 39. EXISTING DRINKING FOUNTAIN TO REMAIN.
- 40. EXISTING STORM SEWER TO REMAIN.
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- 50. EXISTING ADA PARKING STALL TO BE REMOVED AND SALVAGED. 51. EXISTING DEPRESSED CURB AND GUTTER TO BE
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- 55. CONTRACTOR SHALL TRACE UTILITY ROUTING PRIOR TO CONSTRUCTION. NOTIFY ENGINEER IMMEDIATELY IF CONFLICTS EXIST.

EXISTING MANHOLE

EXISTING B-BOX

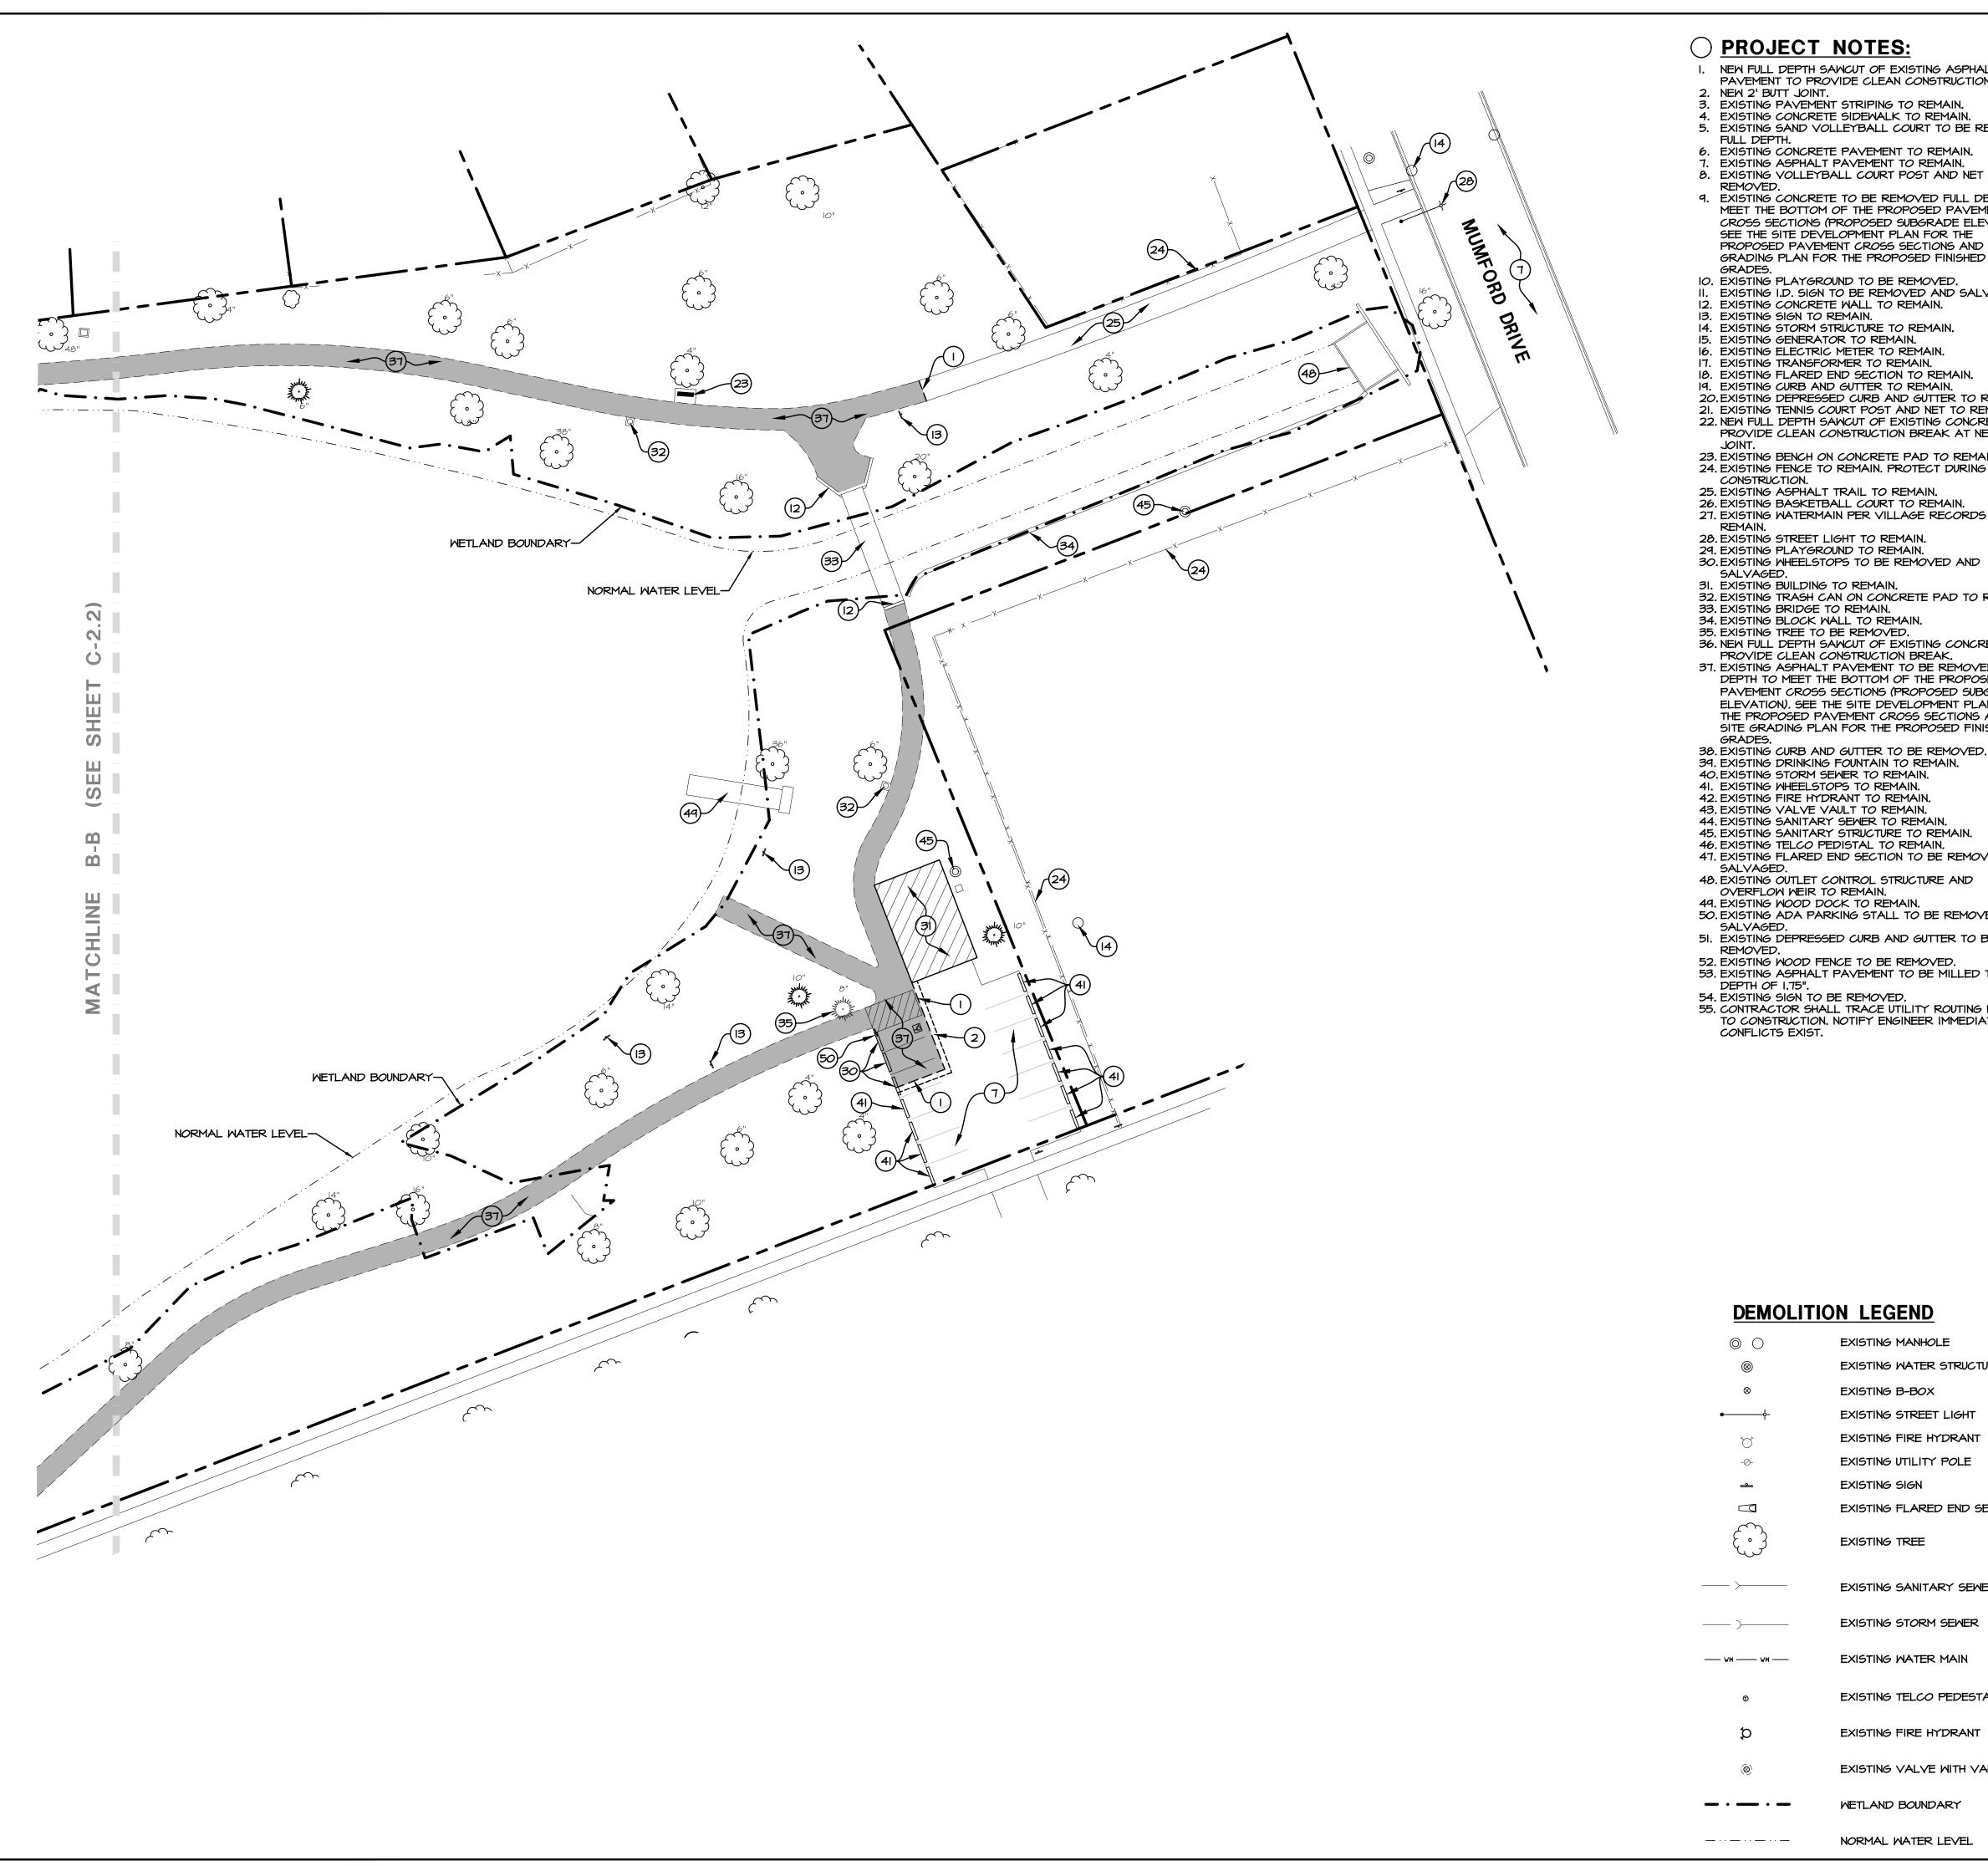EXISTING SIGN

EXISTING TREE

EXISTING STREET LIGHT

EXISTING FIRE HYDRANT

EXISTING UTILITY POLE

EXISTING FLARED END SECTION

EXISTING SANITARY SEWER

EXISTING STORM SEWER

EXISTING WATER MAIN

EXISTING TELCO PEDESTAL

EXISTING FIRE HYDRANT

WETLAND BOUNDARY

NORMAL WATER LEVEL

EXISTING VALVE WITH VAULT

EXISTING WATER STRUCTURE

LOCATION



SITE DEMOLITION NOTES:

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- G. CONTACT GAS COMPANY PRIOR TO DEMOLITION. LOCATION OF EXISTING GAS SERVICES ARE UNKNOWN.
- H. ALL EXISTING TREES SHALL REMAIN UNLESS OTHERWISE NOTED. ALL EXISTING UTILITIES SHALL REMAIN UNLESS OTHERWISE NOTED. J. CONTRACTOR SHALL HIRE A PRIVATE UTILITY LOCATOR TO
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- O. SEE SHEETS 1-4 "PLAT OF SURVEY" FOR ALL EXISTING LOCATED UTILITY DATA.
- P. CLEAR SITE AS NECESSARY TO CONSTRUCT PROPOSED IMPROVEMENTS. Q. ALL ITEMS MARK "EXISTING OR EXISTING TO REMAIN" TO BE
- PROTECTED FROM DAMAGE FOR THE DURATION OF CONSTRUCTION. R. CONTRACTOR TO PROVIDE SOIL TESTING SERVICES FOR COMPLETION OF THE ILLINOIS ENVIRONMENTAL PROTECTION
- AGENCY'S LPC-662 AND/OR LPC-663 FORMS AS PART OF THEIR CONTRACT. S. ALL EXISTING UTILITIES TO BE ABANDONED IN PLACE SHALL BE CAPPED WITH 2' LONG (MIN.) NON-SHRINK CONCRETE MORTAR PLUGS AT BOTH ENDS.


HATCH LEGEND

EXISTING CONCRETE PAVEMENT TO BE REMOVED FULL DEPTH

EXISTING ASPHALT PAVEMENT TO BE REMOVED FULL DEPTH

MILLED TO A DEPTH OF 1.75"

EXISTING ASPHALT PAVEMENT TO BE

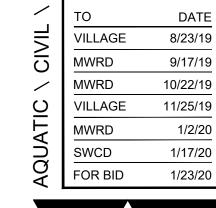


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C-2.3 SITE DEMOLITION PLAN



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55. CONTRACTOR SHALL TRACE UTILITY ROUTING PRIOR

CONFLICTS EXIST.


NORMAL WATER LEVEL

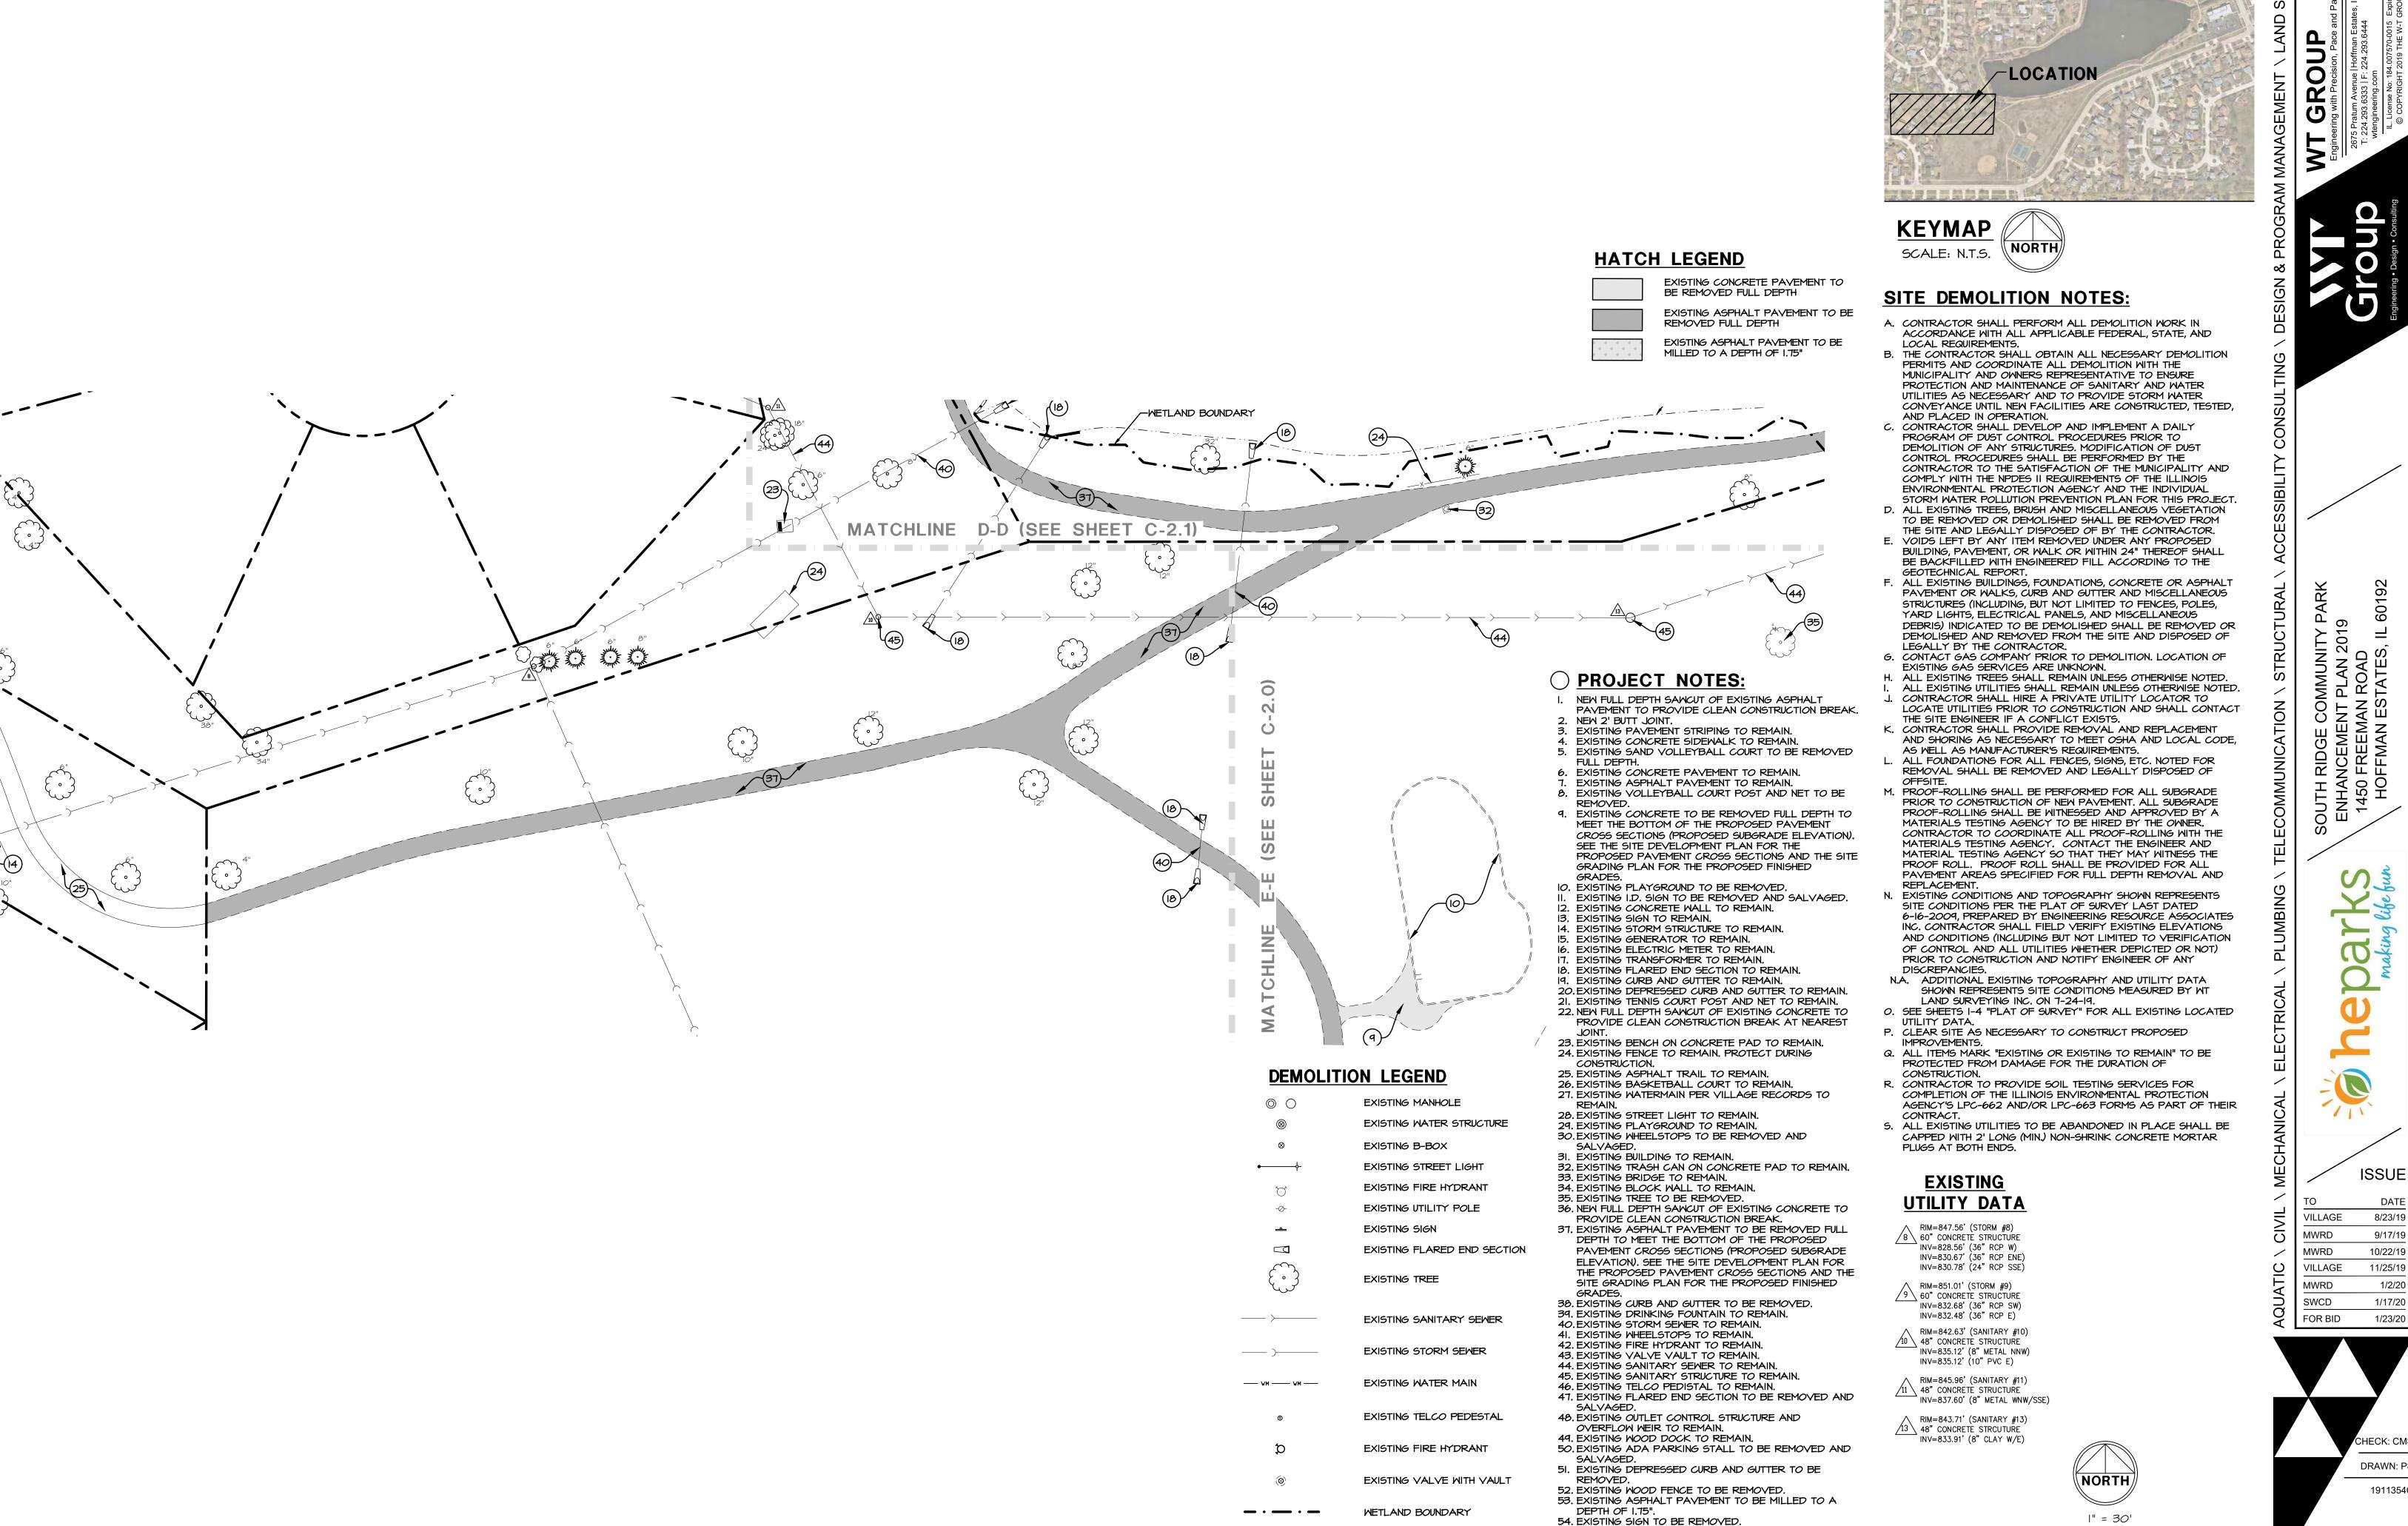TO CONSTRUCTION. NOTIFY ENGINEER IMMEDIATELY IF

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> C-2.4 SITE DEMOLITION PLAN

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& PROGRAM MANAGEMENT \ LAND SUF

WT GROUP

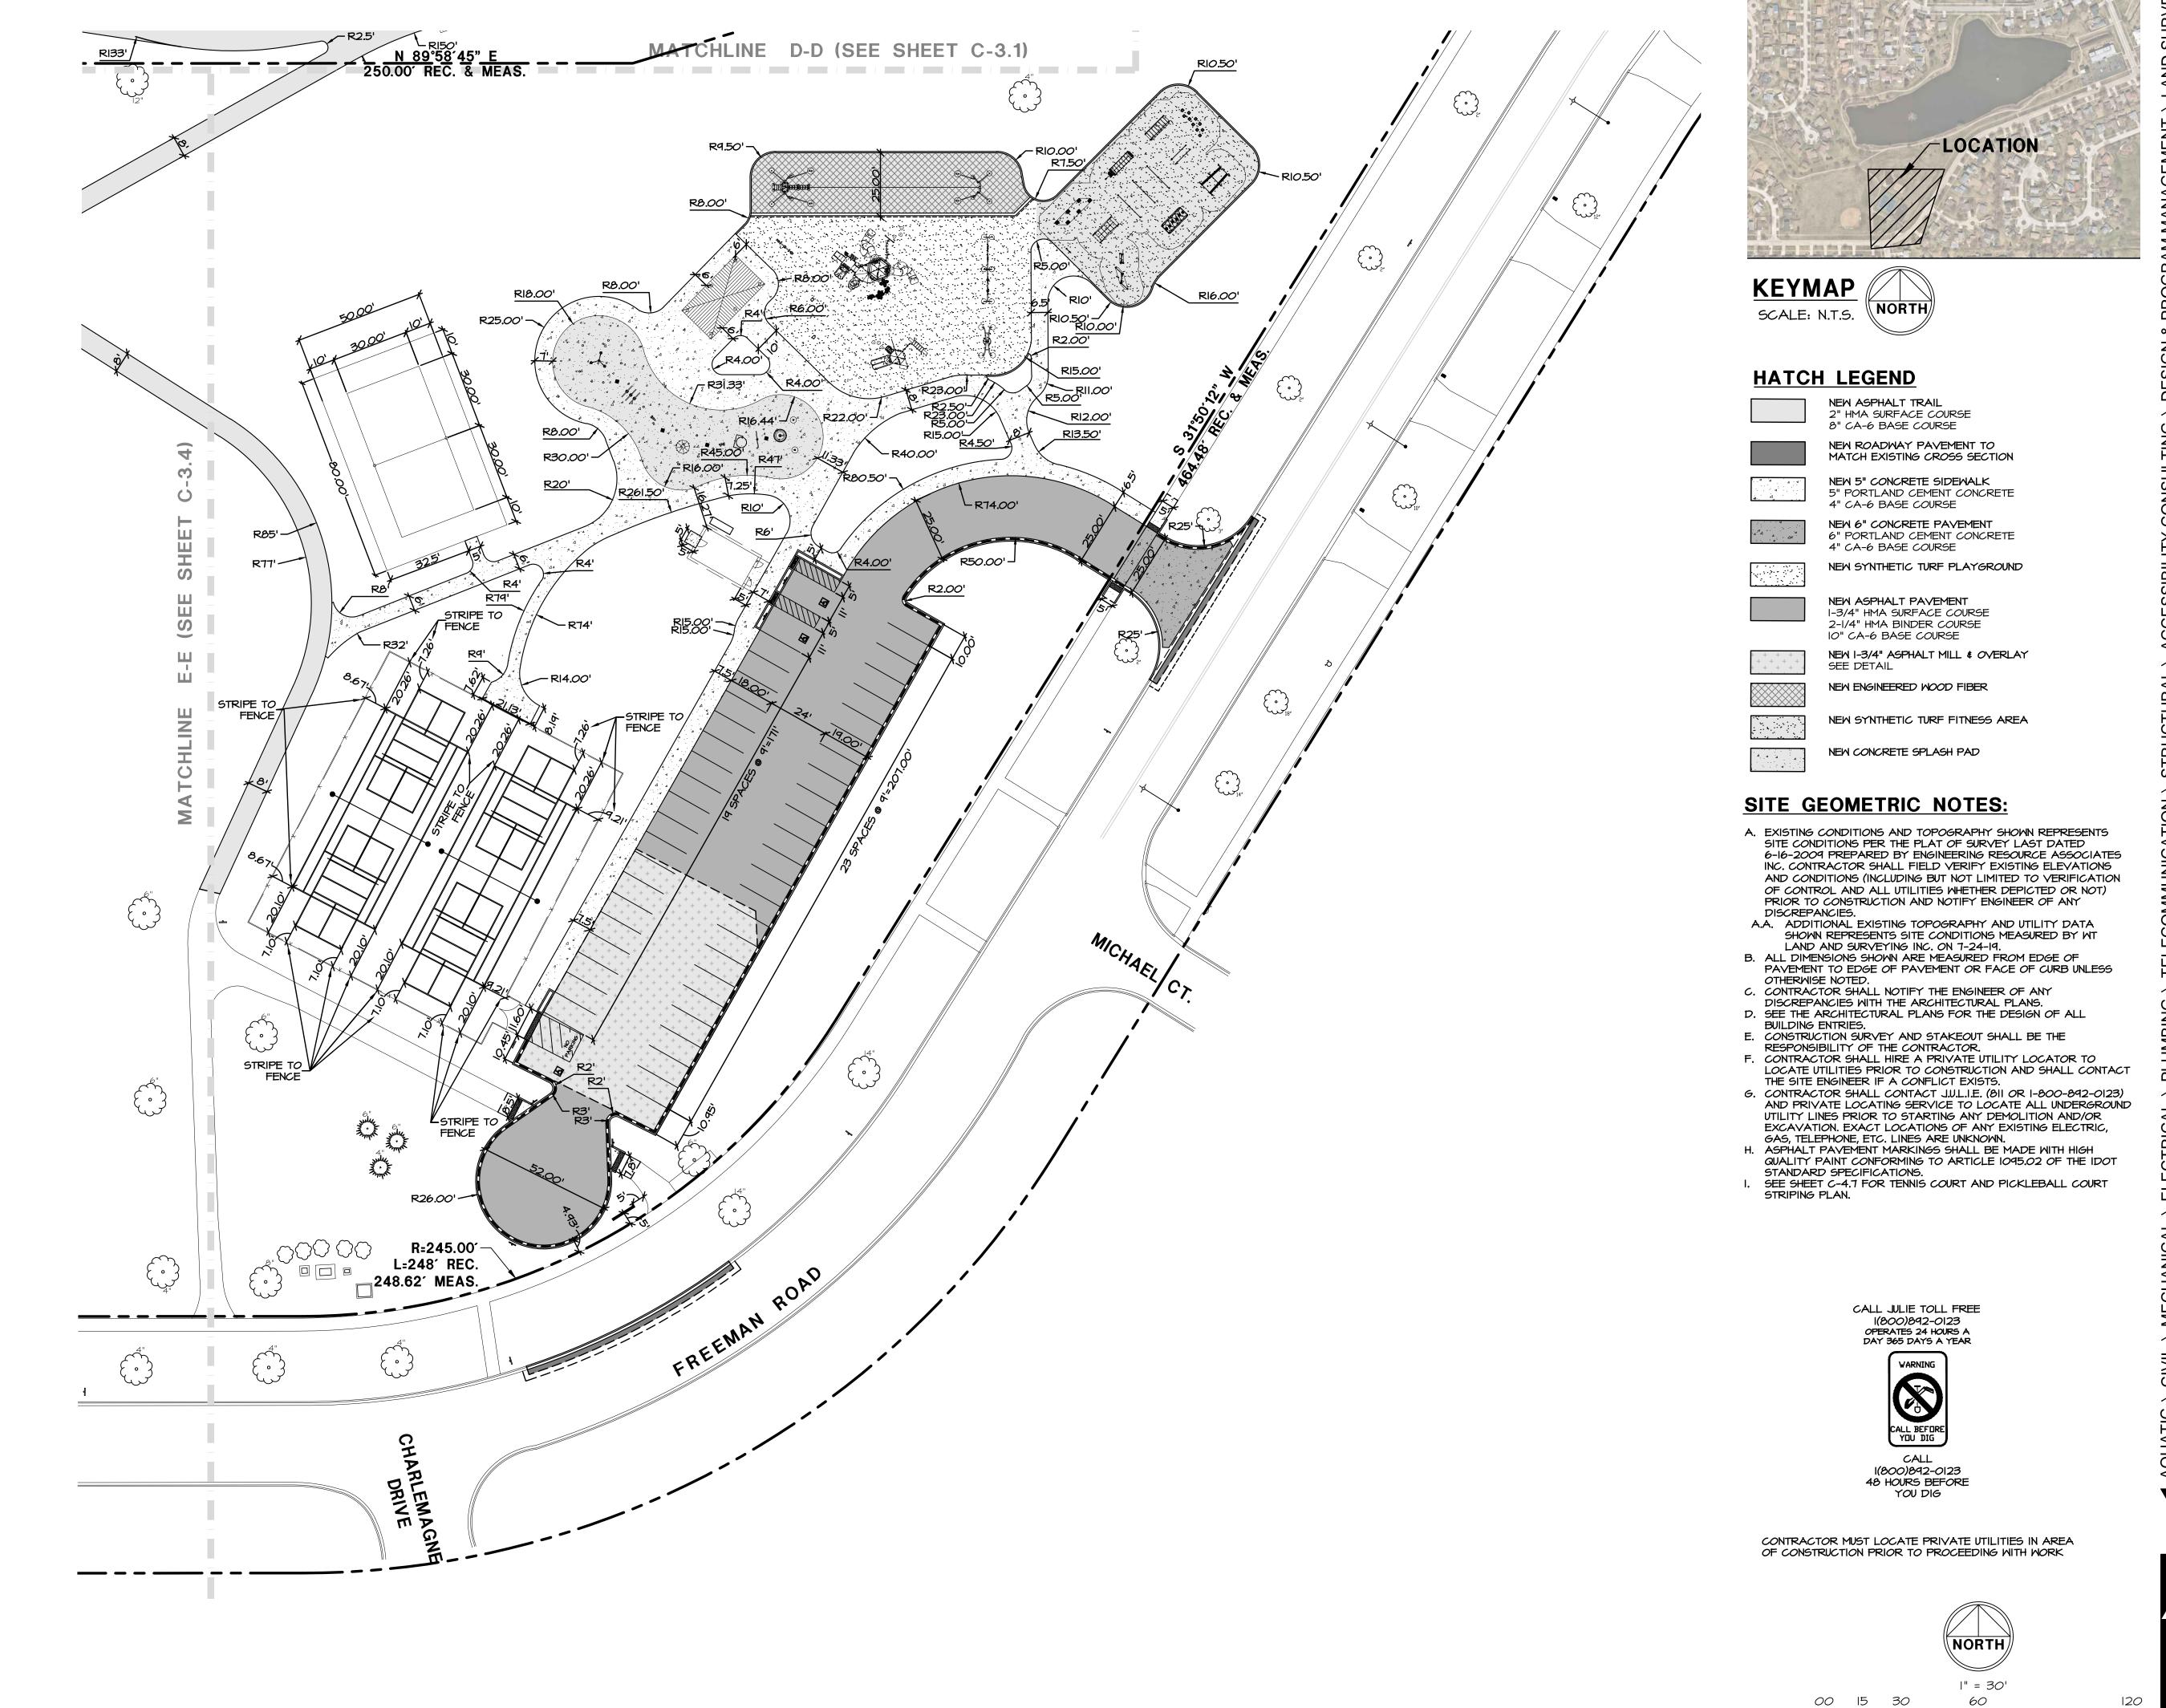Engineering with Precision, Pace and Passic

2675 Pratum Avenue | Hoffman Estates, IL 60

T: 224,293,6333 | F: 224.293.6444

wtengineering.com

CEMENT PLAN 2019
REEMAN ROAD

ENF 14,

heparks making life fun

DATE
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9/17/19
10/22/19

 VILLAGE
 8/23/19

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 VILLAGE
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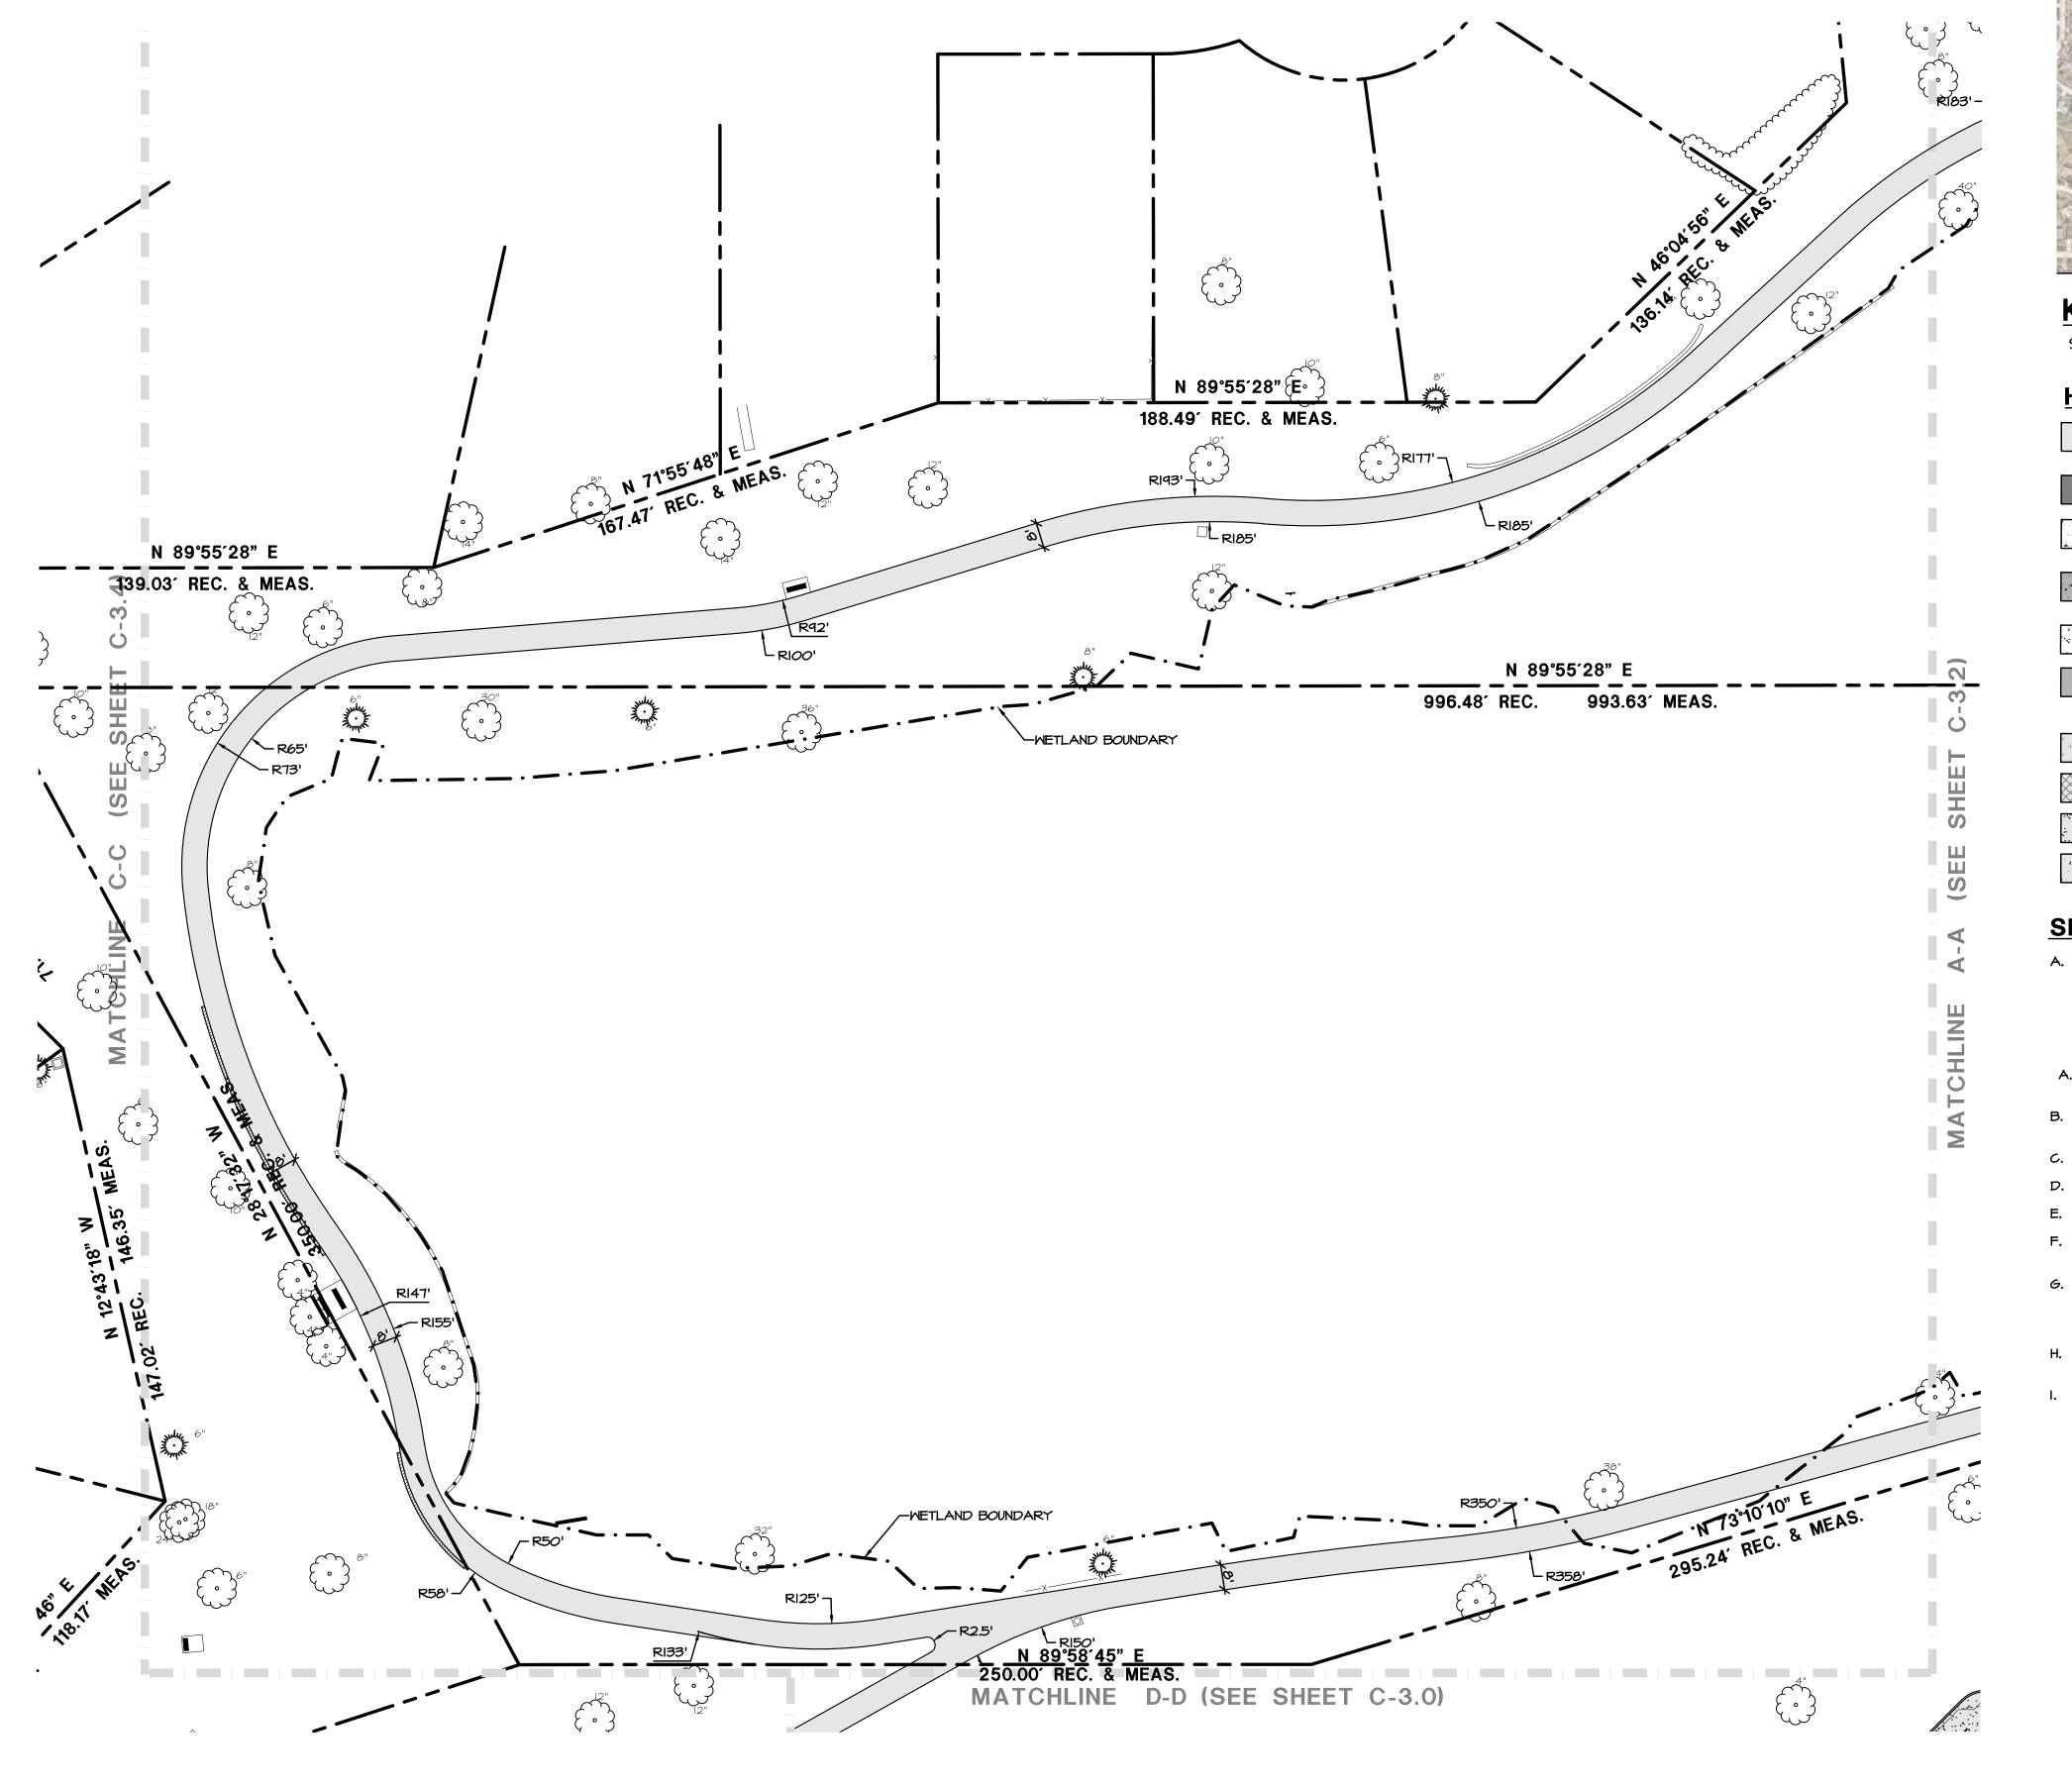
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C-3.0
SITE GEOMETRIC PLAN





KEYMAP \backslash NORTH $_{\prime}$ SCALE: N.T.S.

HATCH LEGEND

NEW ASPHALT TRAIL 2" HMA SURFACE C*O*URSE 8" CA-6 BASE COURSE NEW ROADWAY PAVEMENT TO MATCH EXISTING CROSS SECTION

NEW 5" CONCRETE SIDEWALK 5" PORTLAND CEMENT CONCRETE 4" CA-6 BASE COURSE NEW 6" CONCRETE PAVEMENT 6" PORTLAND CEMENT CONCRETE

4" CA-6 BASE COURSE NEW SYNTHETIC TURF PLAYGROUND

NEW ASPHALT PAVEMENT 1-3/4" HMA SURFACE COURSE 2-1/4" HMA BINDER COURSE IO" CA-6 BASE COURSE NEW I-3/4" ASPHALT MILL & OVERLAY

SEE DETAIL NEW ENGINEERED WOOD FIBER

NEW SYNTHETIC TURF FITNESS AREA

NEW CONCRETE SPLASH PAD

SITE GEOMETRIC NOTES:

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A.A. ADDITIONAL EXISTING TOPOGRAPHY AND UTILITY DATA SHOWN REPRESENTS SITE CONDITIONS MEASURED BY WI

LAND AND SURVEYING INC. ON 7-24-19. B. ALL DIMENSIONS SHOWN ARE MEASURED FROM EDGE OF PAVEMENT TO EDGE OF PAVEMENT OR FACE OF CURB UNLESS

OTHERWISE NOTED. C. CONTRACTOR SHALL NOTIFY THE ENGINEER OF ANY

DISCREPANCIES WITH THE ARCHITECTURAL PLANS. D. SEE THE ARCHITECTURAL PLANS FOR THE DESIGN OF ALL

BUILDING ENTRIES. E. CONSTRUCTION SURVEY AND STAKEOUT SHALL BE THE

RESPONSIBILITY OF THE CONTRACTOR.

F. CONTRACTOR SHALL HIRE A PRIVATE UTILITY LOCATOR TO

LOCATE UTILITIES PRIOR TO CONSTRUCTION AND SHALL CONTACT THE SITE ENGINEER IF A CONFLICT EXISTS.

G. CONTRACTOR SHALL CONTACT J.U.L.I.E. (811 OR 1-800-892-0123) AND PRIVATE LOCATING SERVICE TO LOCATE ALL UNDERGROUND UTILITY LINES PRIOR TO STARTING ANY DEMOLITION AND/OR EXCAVATION. EXACT LOCATIONS OF ANY EXISTING ELECTRIC,

GAS, TELEPHONE, ETC. LINES ARE UNKNOWN. H. ASPHALT PAVEMENT MARKINGS SHALL BE MADE WITH HIGH QUALITY PAINT CONFORMING TO ARTICLE 1095.02 OF THE IDOT STANDARD SPECIFICATIONS.


SEE SHEET C-4.7 FOR TENNIS COURT AND PICKLEBALL COURT STRIPING PLAN.

> CALL JULIE TOLL FREE 1(800)892-0123 OPERATES 24 HOURS A DAY 365 DAYS A YEAR



CALL 1*(800)8*92-0123 48 HOURS BEFORE YOU DIG

CONTRACTOR MUST LOCATE PRIVATE UTILITIES IN AREA OF CONSTRUCTION PRIOR TO PROCEEDING WITH WORK

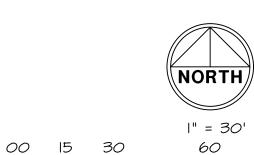

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VILLAGE

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8/23/19

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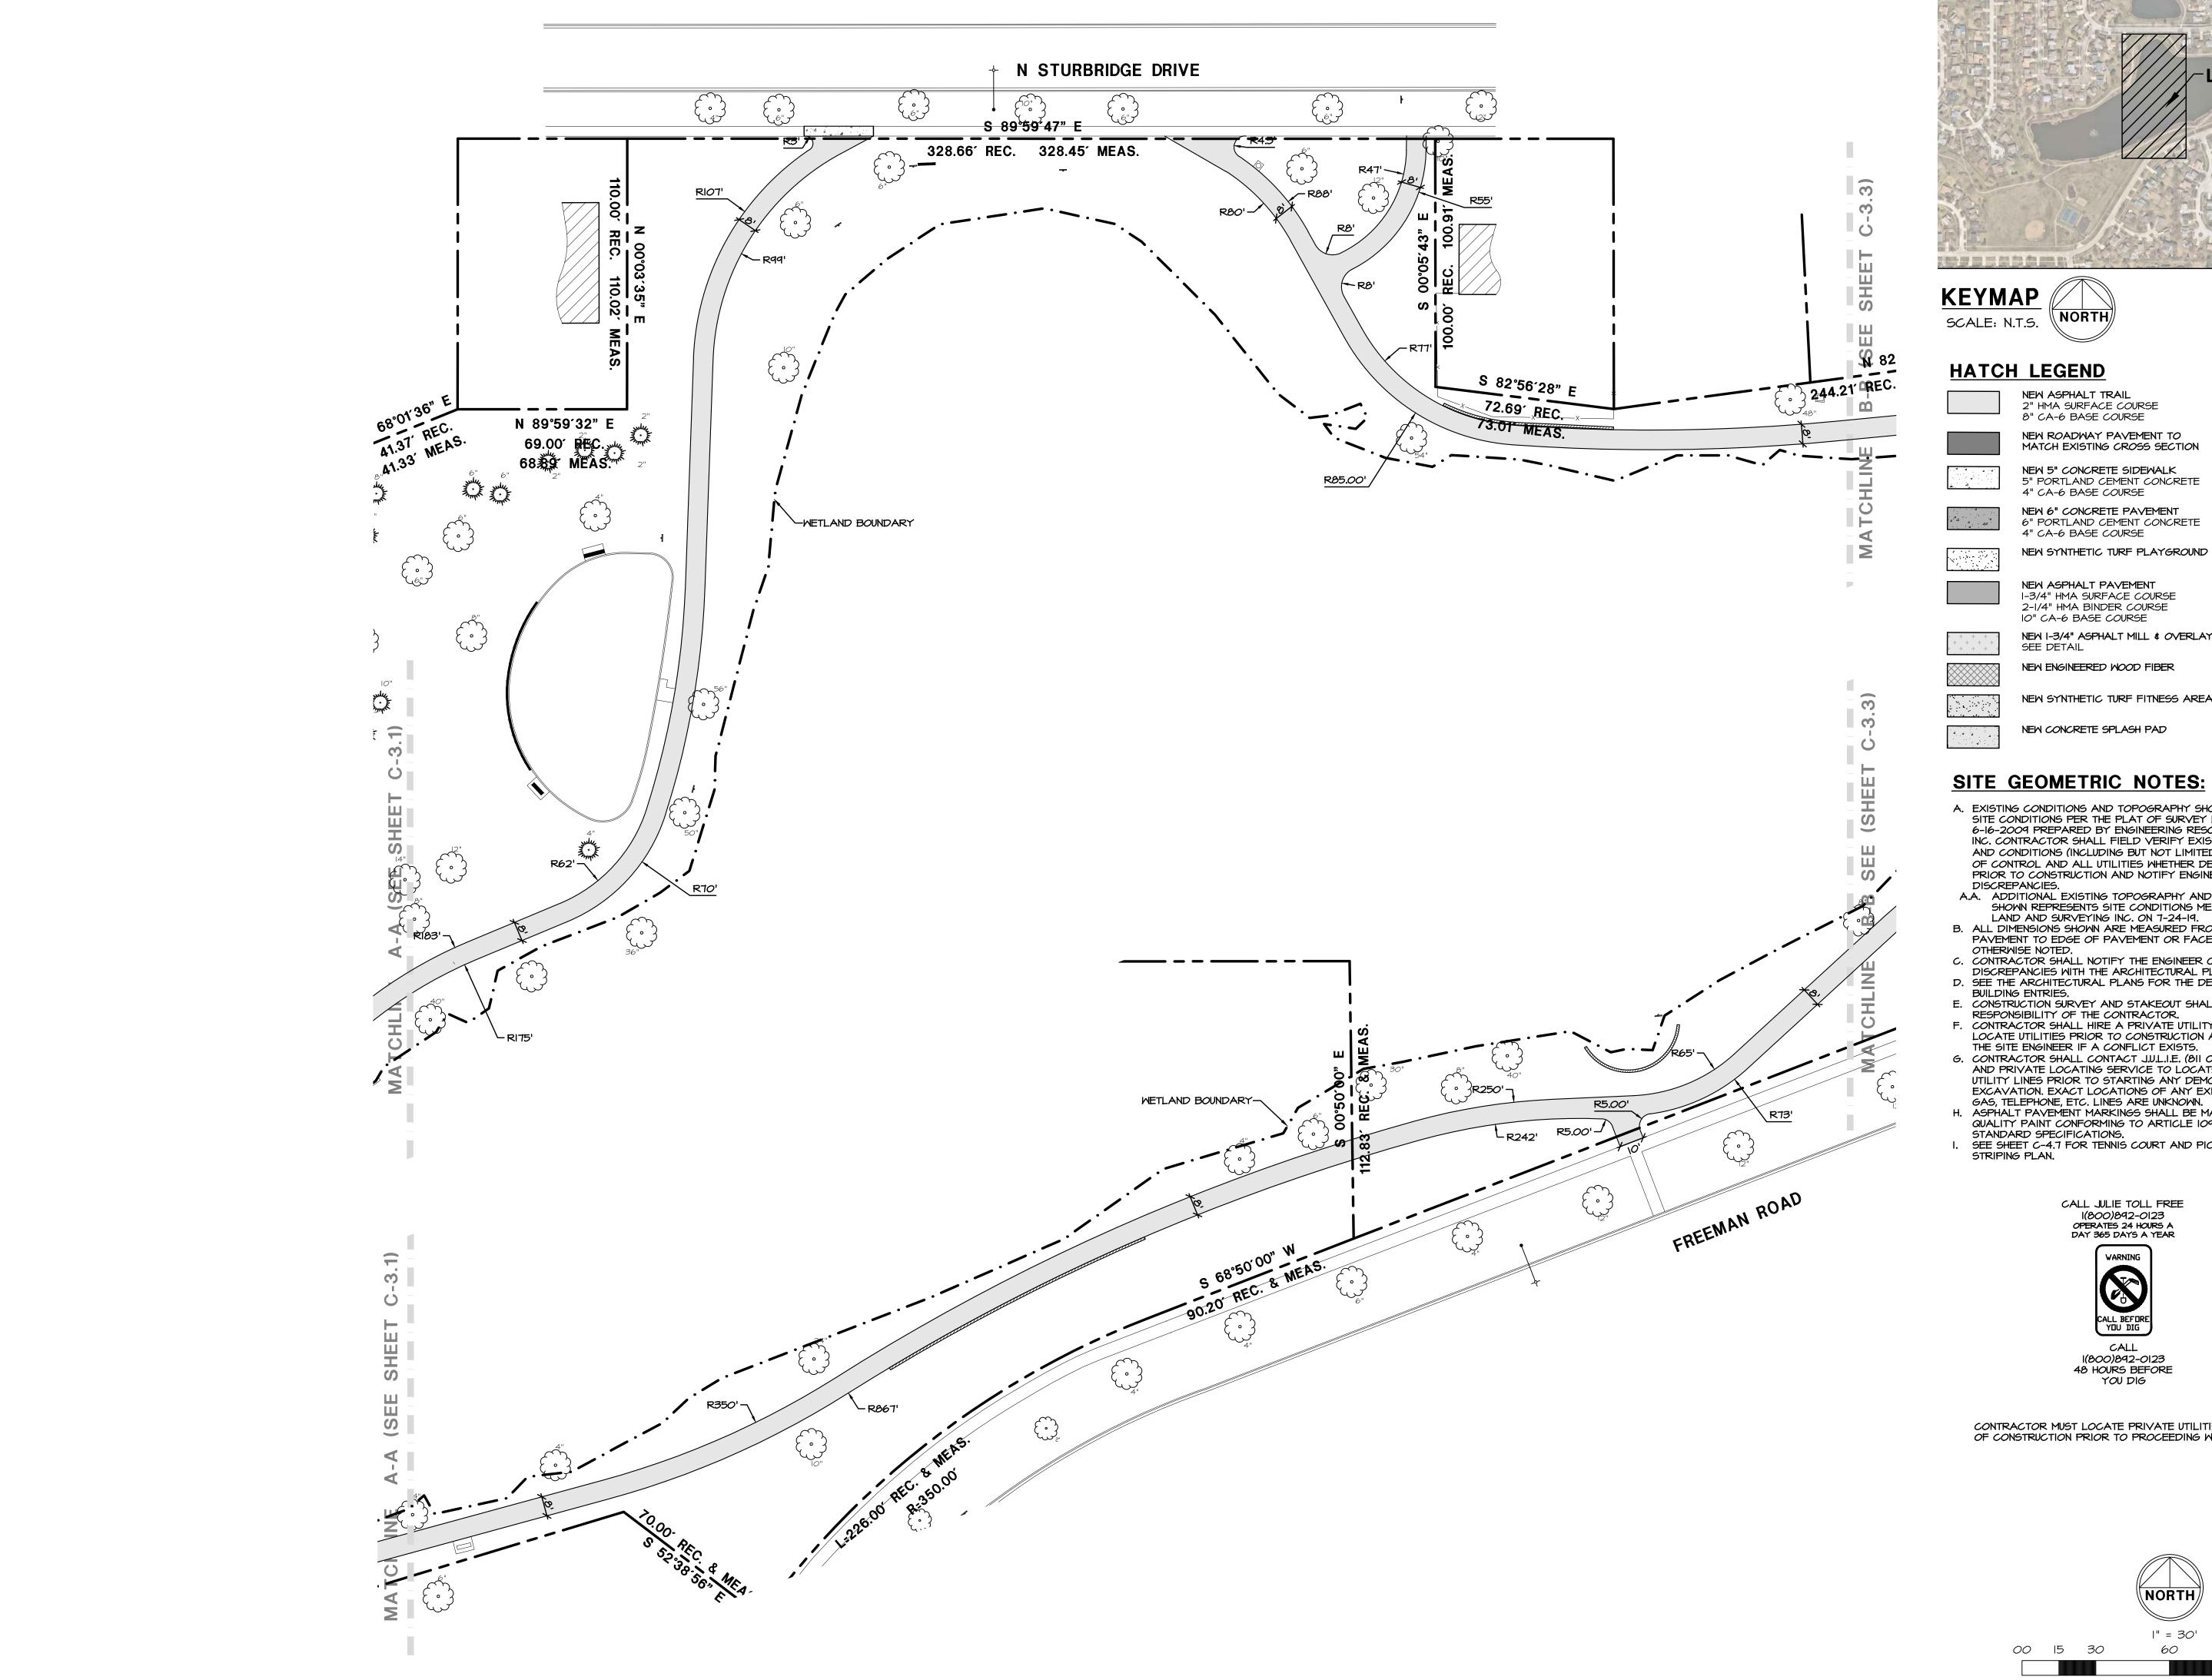
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C-3.1

SITE GEOMETRIC PLAN

ENF 14,





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2" HMA SURFACE COURSE 8" CA-6 BASE COURSE

NEW 5" CONCRETE SIDEWALK 5" PORTLAND CEMENT CONCRETE

NEW 6" CONCRETE PAVEMENT 6" PORTLAND CEMENT CONCRETE 4" CA-6 BASE COURSE

NEW ASPHALT PAVEMENT 1-3/4" HMA SURFACE COURSE 2-1/4" HMA BINDER COURSE

NEW 1-3/4" ASPHALT MILL & OVERLAY

NEW SYNTHETIC TURF FITNESS AREA

NEW CONCRETE SPLASH PAD

SITE GEOMETRIC NOTES:


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- G. CONTRACTOR SHALL CONTACT J.U.L.I.E. (811 OR 1-800-892-0123) AND PRIVATE LOCATING SERVICE TO LOCATE ALL UNDERGROUND UTILITY LINES PRIOR TO STARTING ANY DEMOLITION AND/OR EXCAVATION. EXACT LOCATIONS OF ANY EXISTING ELECTRIC, GAS, TELEPHONE, ETC. LINES ARE UNKNOWN.
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- SEE SHEET C-4.7 FOR TENNIS COURT AND PICKLEBALL COURT

CALL JULIE TOLL FREE 1(800)892-0123 OPERATES 24 HOURS A DAY 365 DAYS A YEAR



1(800)892-0123 48 HOURS BEFORE YOU DIG

CONTRACTOR MUST LOCATE PRIVATE UTILITIES IN AREA OF CONSTRUCTION PRIOR TO PROCEEDING WITH WORK

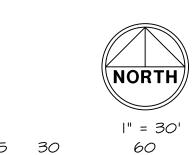

CHECK: CMS DRAWN: PS 1911354C

C-3.2
SITE GEOMETRIC PLAN

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8/23/19

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OUT ENH 145





NEW ASPHALT TRAIL 2" HMA SURFACE COURSE 8" CA-6 BASE COURSE

4" CA-6 BASE COURSE NEW 6" CONCRETE PAYEMENT

NEW SYNTHETIC TURF PLAYGROUND

2-1/4" HMA BINDER COURSE 10" CA-6 BASE COURSE NEW I-3/4" ASPHALT MILL & OVERLAY

NEW ENGINEERED WOOD FIBER

NEW SYNTHETIC TURF FITNESS AREA

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- I. SEE SHEET C-4.7 FOR TENNIS COURT AND PICKLEBALL COURT



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VILLAGE

8/23/19


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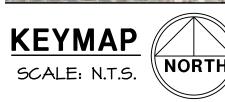
11/25/19

C-3.3

SITE GEOMETRIC PLAN





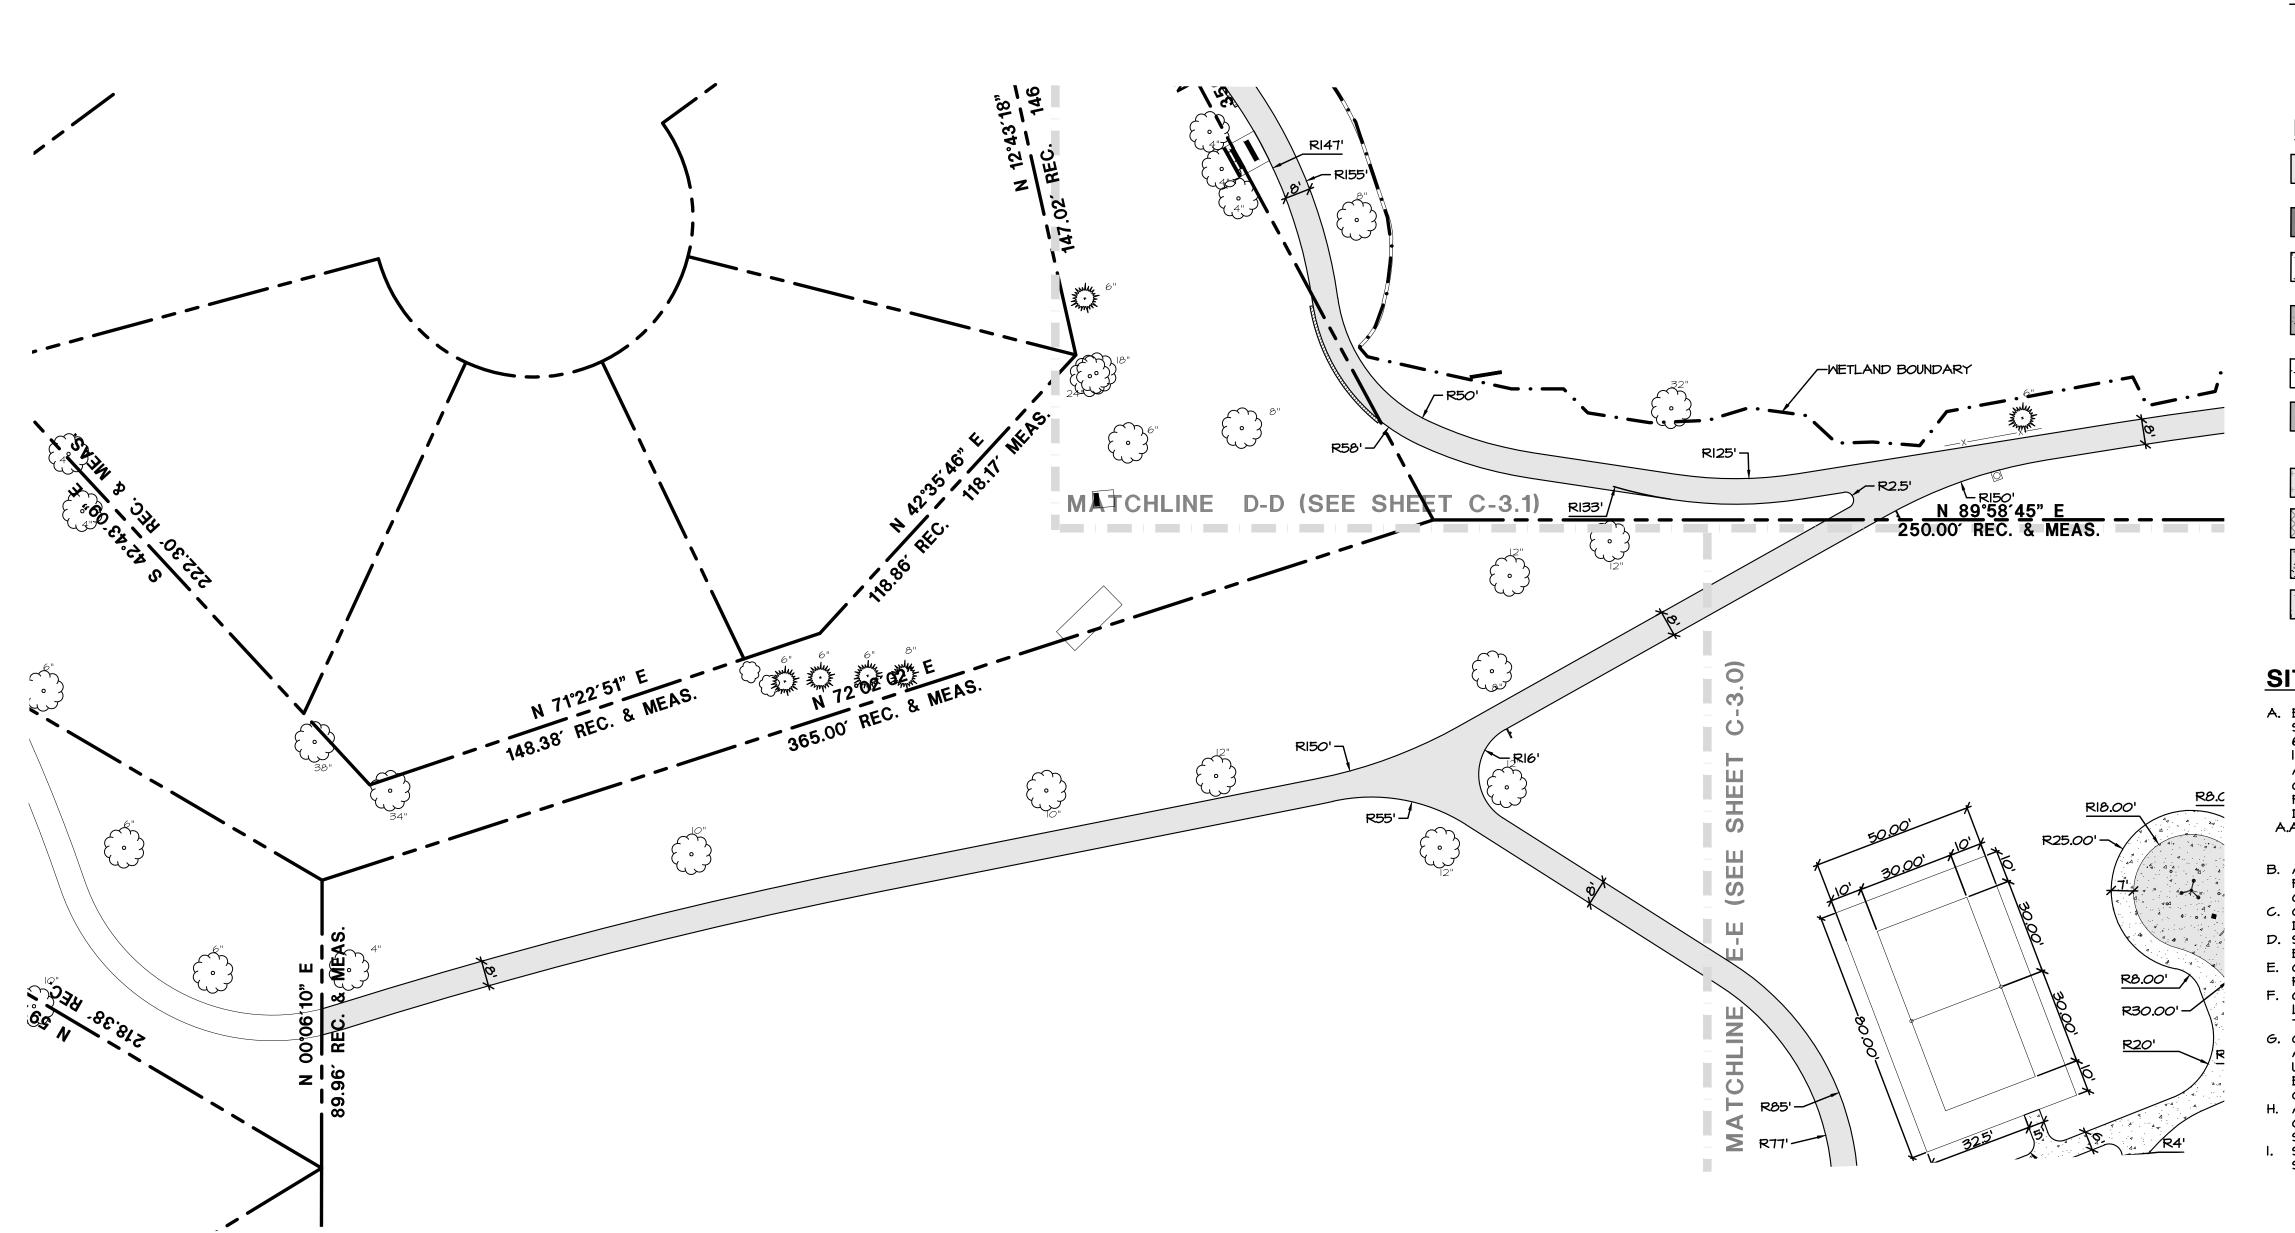

HATCH LEGEND

NEW ASPHALT TRAIL 2" HMA SURFACE COURSE 8" CA-6 BASE COURSE NEW ROADWAY PAVEMENT TO MATCH EXISTING CROSS SECTION NEW 5" CONCRETE SIDEWALK 5" PORTLAND CEMENT CONCRETE 4" CA-6 BASE COURSE NEW 6" CONCRETE PAVEMENT 6" PORTLAND CEMENT CONCRETE 4" CA-6 BASE COURSE NEW SYNTHETIC TURF PLAYGROUND NEW ASPHALT PAVEMENT I-3/4" HMA SURFACE COURSE 2-1/4" HMA BINDER COURSE IO" CA-6 BASE COURSE NEW I-3/4" ASPHALT MILL & OVERLAY SEE DETAIL

NEW ENGINEERED WOOD FIBER

NEW SYNTHETIC TURF FITNESS AREA

NEW CONCRETE SPLASH PAD

SITE GEOMETRIC NOTES:

- A. EXISTING CONDITIONS AND TOPOGRAPHY SHOWN REPRESENTS SITE CONDITIONS PER THE PLAT OF SURVEY LAST DATED 6-16-2004 PREPARED BY ENGINEERING RESOURCE ASSOCIATES INC. CONTRACTOR SHALL FIELD VERIFY EXISTING ELEVATIONS AND CONDITIONS (INCLUDING BUT NOT LIMITED TO VERIFICATION OF CONTROL AND ALL UTILITIES WHETHER DEPICTED OR NOT) PRIOR TO CONSTRUCTION AND NOTIFY ENGINEER OF ANY DISCREPANCIES.
- A.A. ADDITIONAL EXISTING TOPOGRAPHY AND UTILITY DATA SHOWN REPRESENTS SITE CONDITIONS MEASURED BY WT
- LAND AND SURVEYING INC. ON 7-24-19. B. ALL DIMENSIONS SHOWN ARE MEASURED FROM EDGE OF PAVEMENT TO EDGE OF PAVEMENT OR FACE OF CURB UNLESS
- OTHERWISE NOTED. C. CONTRACTOR SHALL NOTIFY THE ENGINEER OF ANY DISCREPANCIES WITH THE ARCHITECTURAL PLANS.
- D. SEE THE ARCHITECTURAL PLANS FOR THE DESIGN OF ALL
- BUILDING ENTRIES. E. CONSTRUCTION SURVEY AND STAKEOUT SHALL BE THE RESPONSIBILITY OF THE CONTRACTOR.
- F. CONTRACTOR SHALL HIRE A PRIVATE UTILITY LOCATOR TO LOCATE UTILITIES PRIOR TO CONSTRUCTION AND SHALL CONTACT THE SITE ENGINEER IF A CONFLICT EXISTS. G. CONTRACTOR SHALL CONTACT J.U.L.I.E. (811 OR 1-800-892-0123)
- AND PRIVATE LOCATING SERVICE TO LOCATE ALL UNDERGROUND UTILITY LINES PRIOR TO STARTING ANY DEMOLITION AND/OR EXCAVATION. EXACT LOCATIONS OF ANY EXISTING ELECTRIC, GAS, TELEPHONE, ETC. LINES ARE UNKNOWN.
- ASPHALT PAVEMENT MARKINGS SHALL BE MADE WITH HIGH QUALITY PAINT CONFORMING TO ARTICLE 1095.02 OF THE IDOT STANDARD SPECIFICATIONS.


SEE SHEET C-4.7 FOR TENNIS COURT AND PICKLEBALL COURT STRIPING PLAN.



CALL JULIE TOLL FREE 1(800)892-0123

1(800)892-0123 48 HOURS BEFORE YOU DIG

CONTRACTOR MUST LOCATE PRIVATE UTILITIES IN AREA OF CONSTRUCTION PRIOR TO PROCEEDING WITH WORK

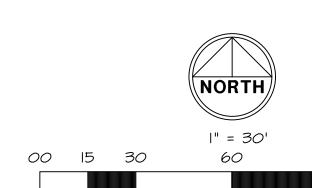


8/23/19 VILLAGE MWRD 9/17/19 MWRD 10/22/19 VILLAGE 11/25/19 MWRD SWCD FOR BID 1/23/20

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CHECK: CMS DRAWN: PS 1911354C

> C-3.4 SITE GEOMETRIC PLAN

120

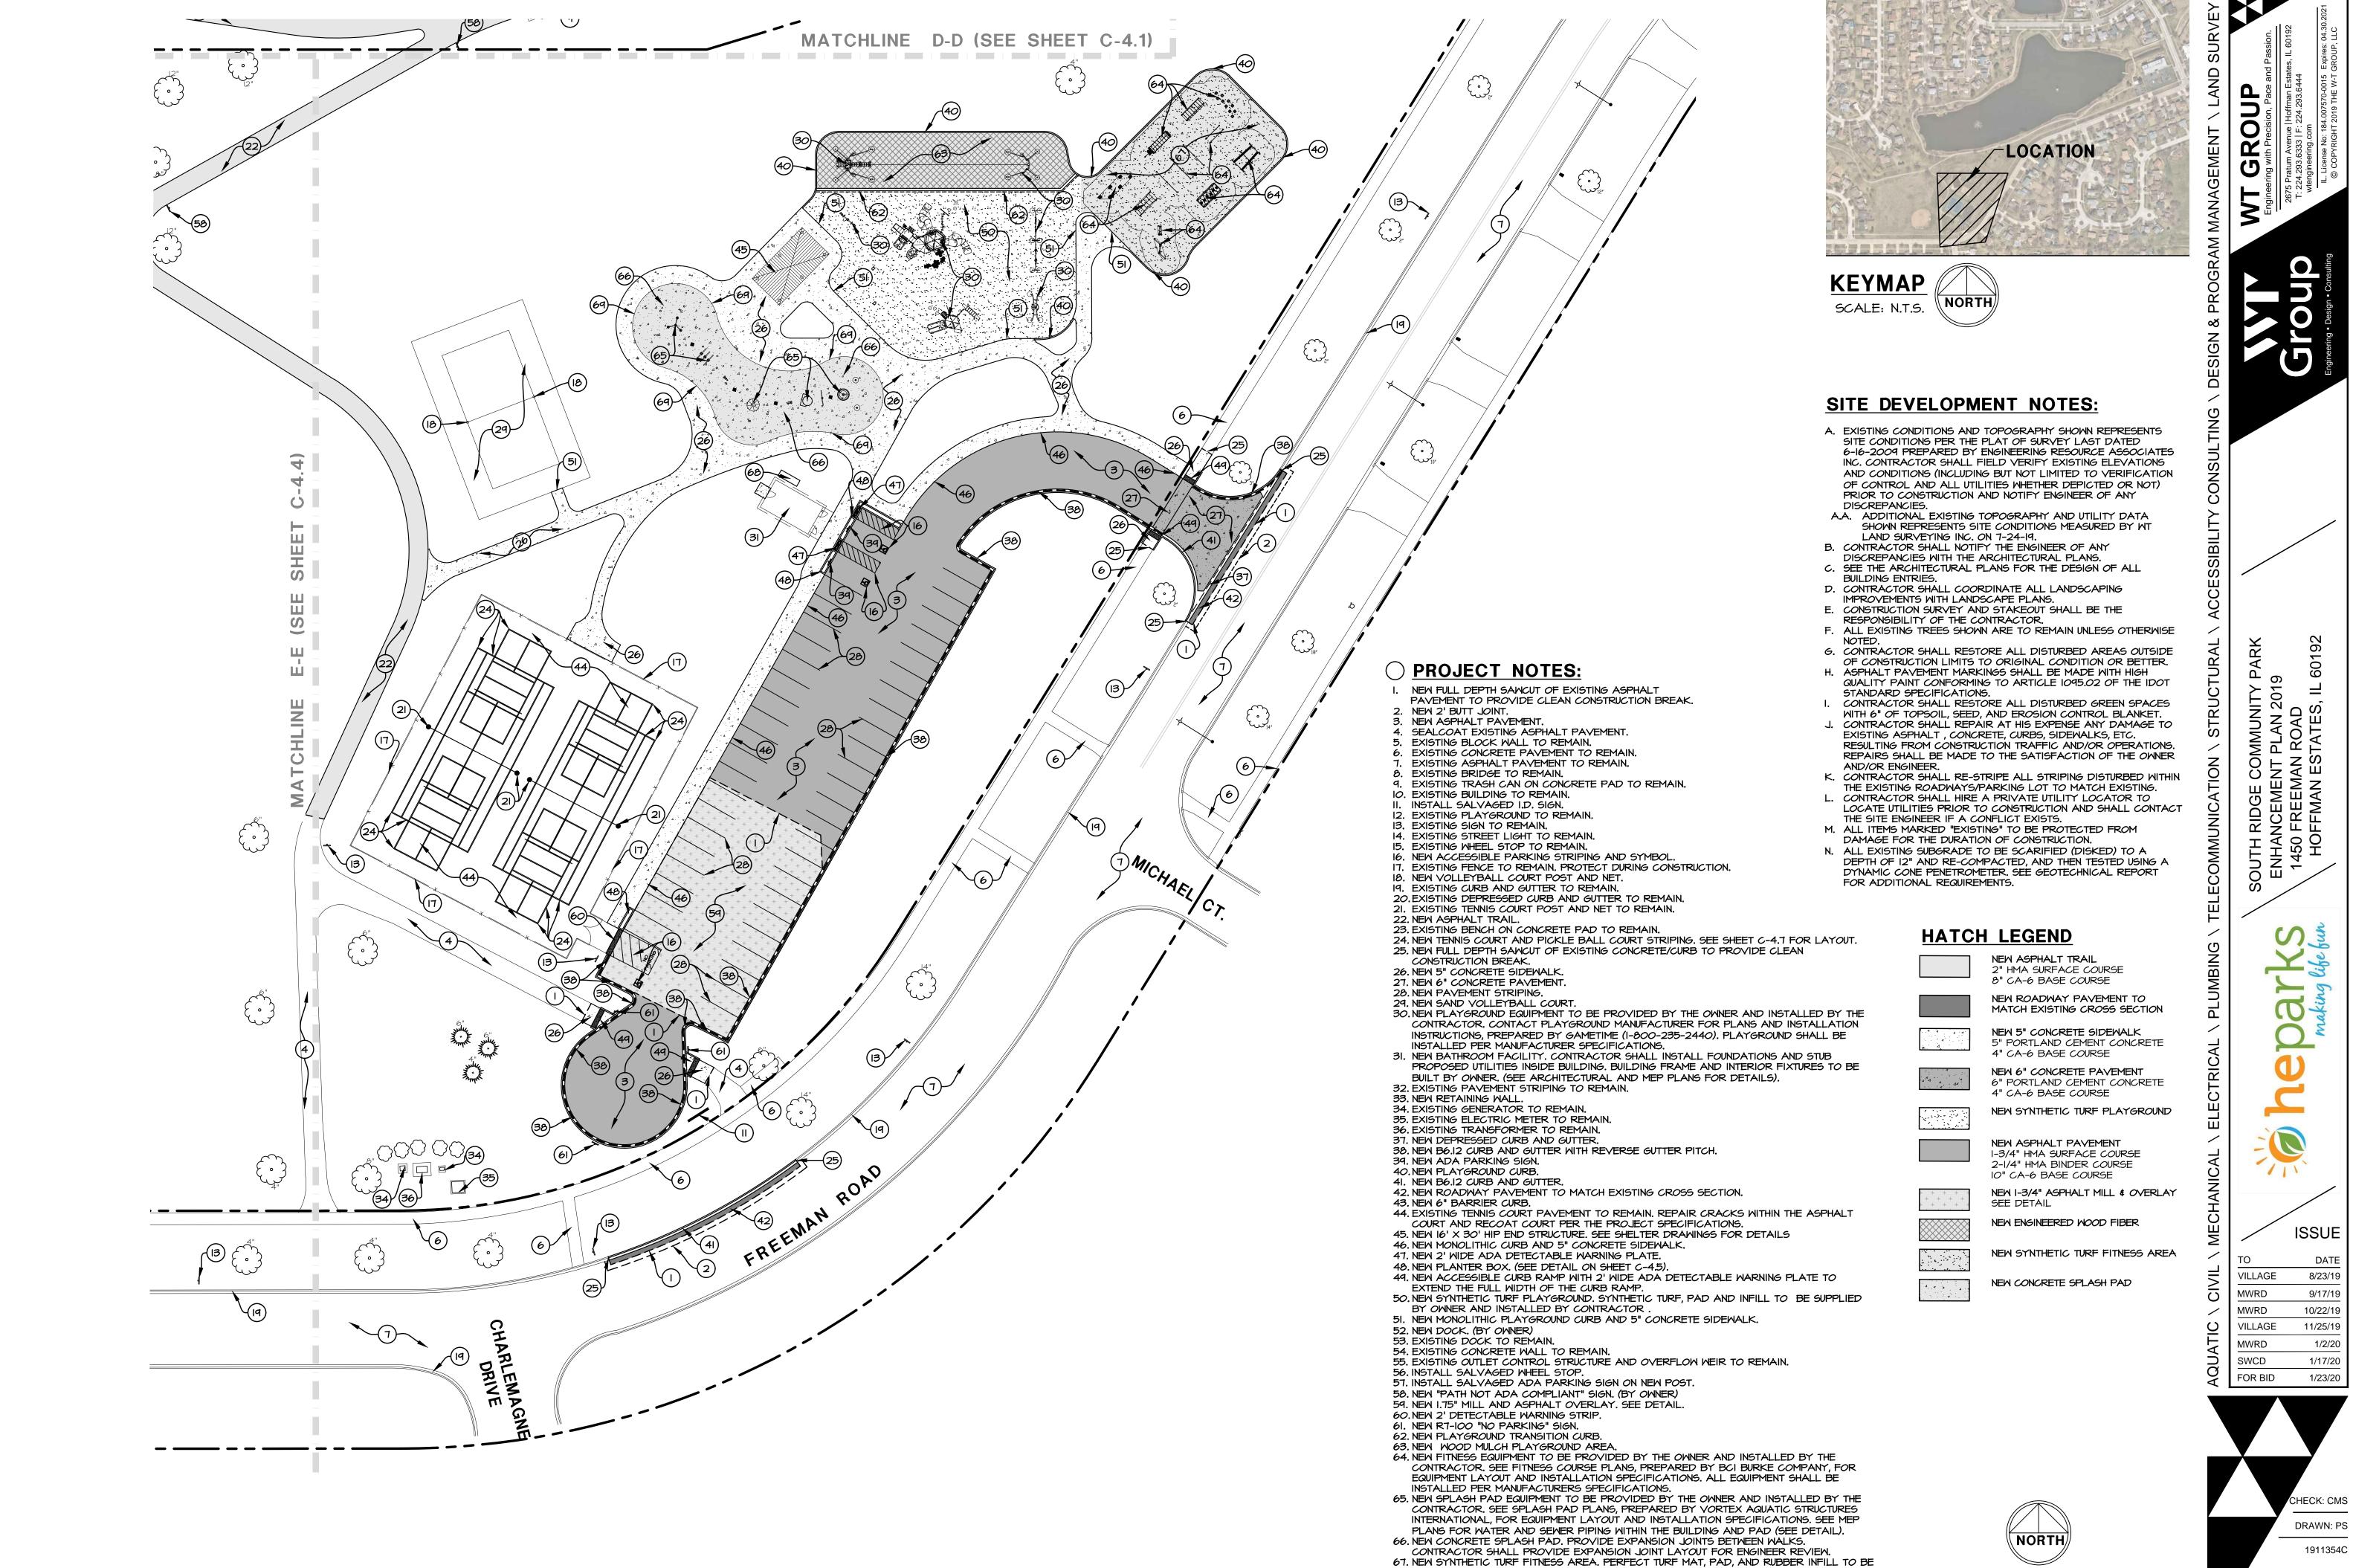

PROVIDED BY OWNER.

PROVIDE SUFFICIENT SLOPE FOR PIPING.

69. EXPANSION JOINT WITH WATER STOP.

68. NEW WINTERIZING PIT FOR WINTER SHUT DOWN. WALLS OF THE PIT SHALL BE 5" THICK

CONCRETE. PROVIDE WATER TIGHT ACCESS GATE. BOTTOM OF THE PIT SHALL BE SET TO 00 15 30

8/23/19 9/17/19 10/22/19 11/25/19


C-4.0

SITE DEVELOPMENT PLAN

120

I" = 30'

60

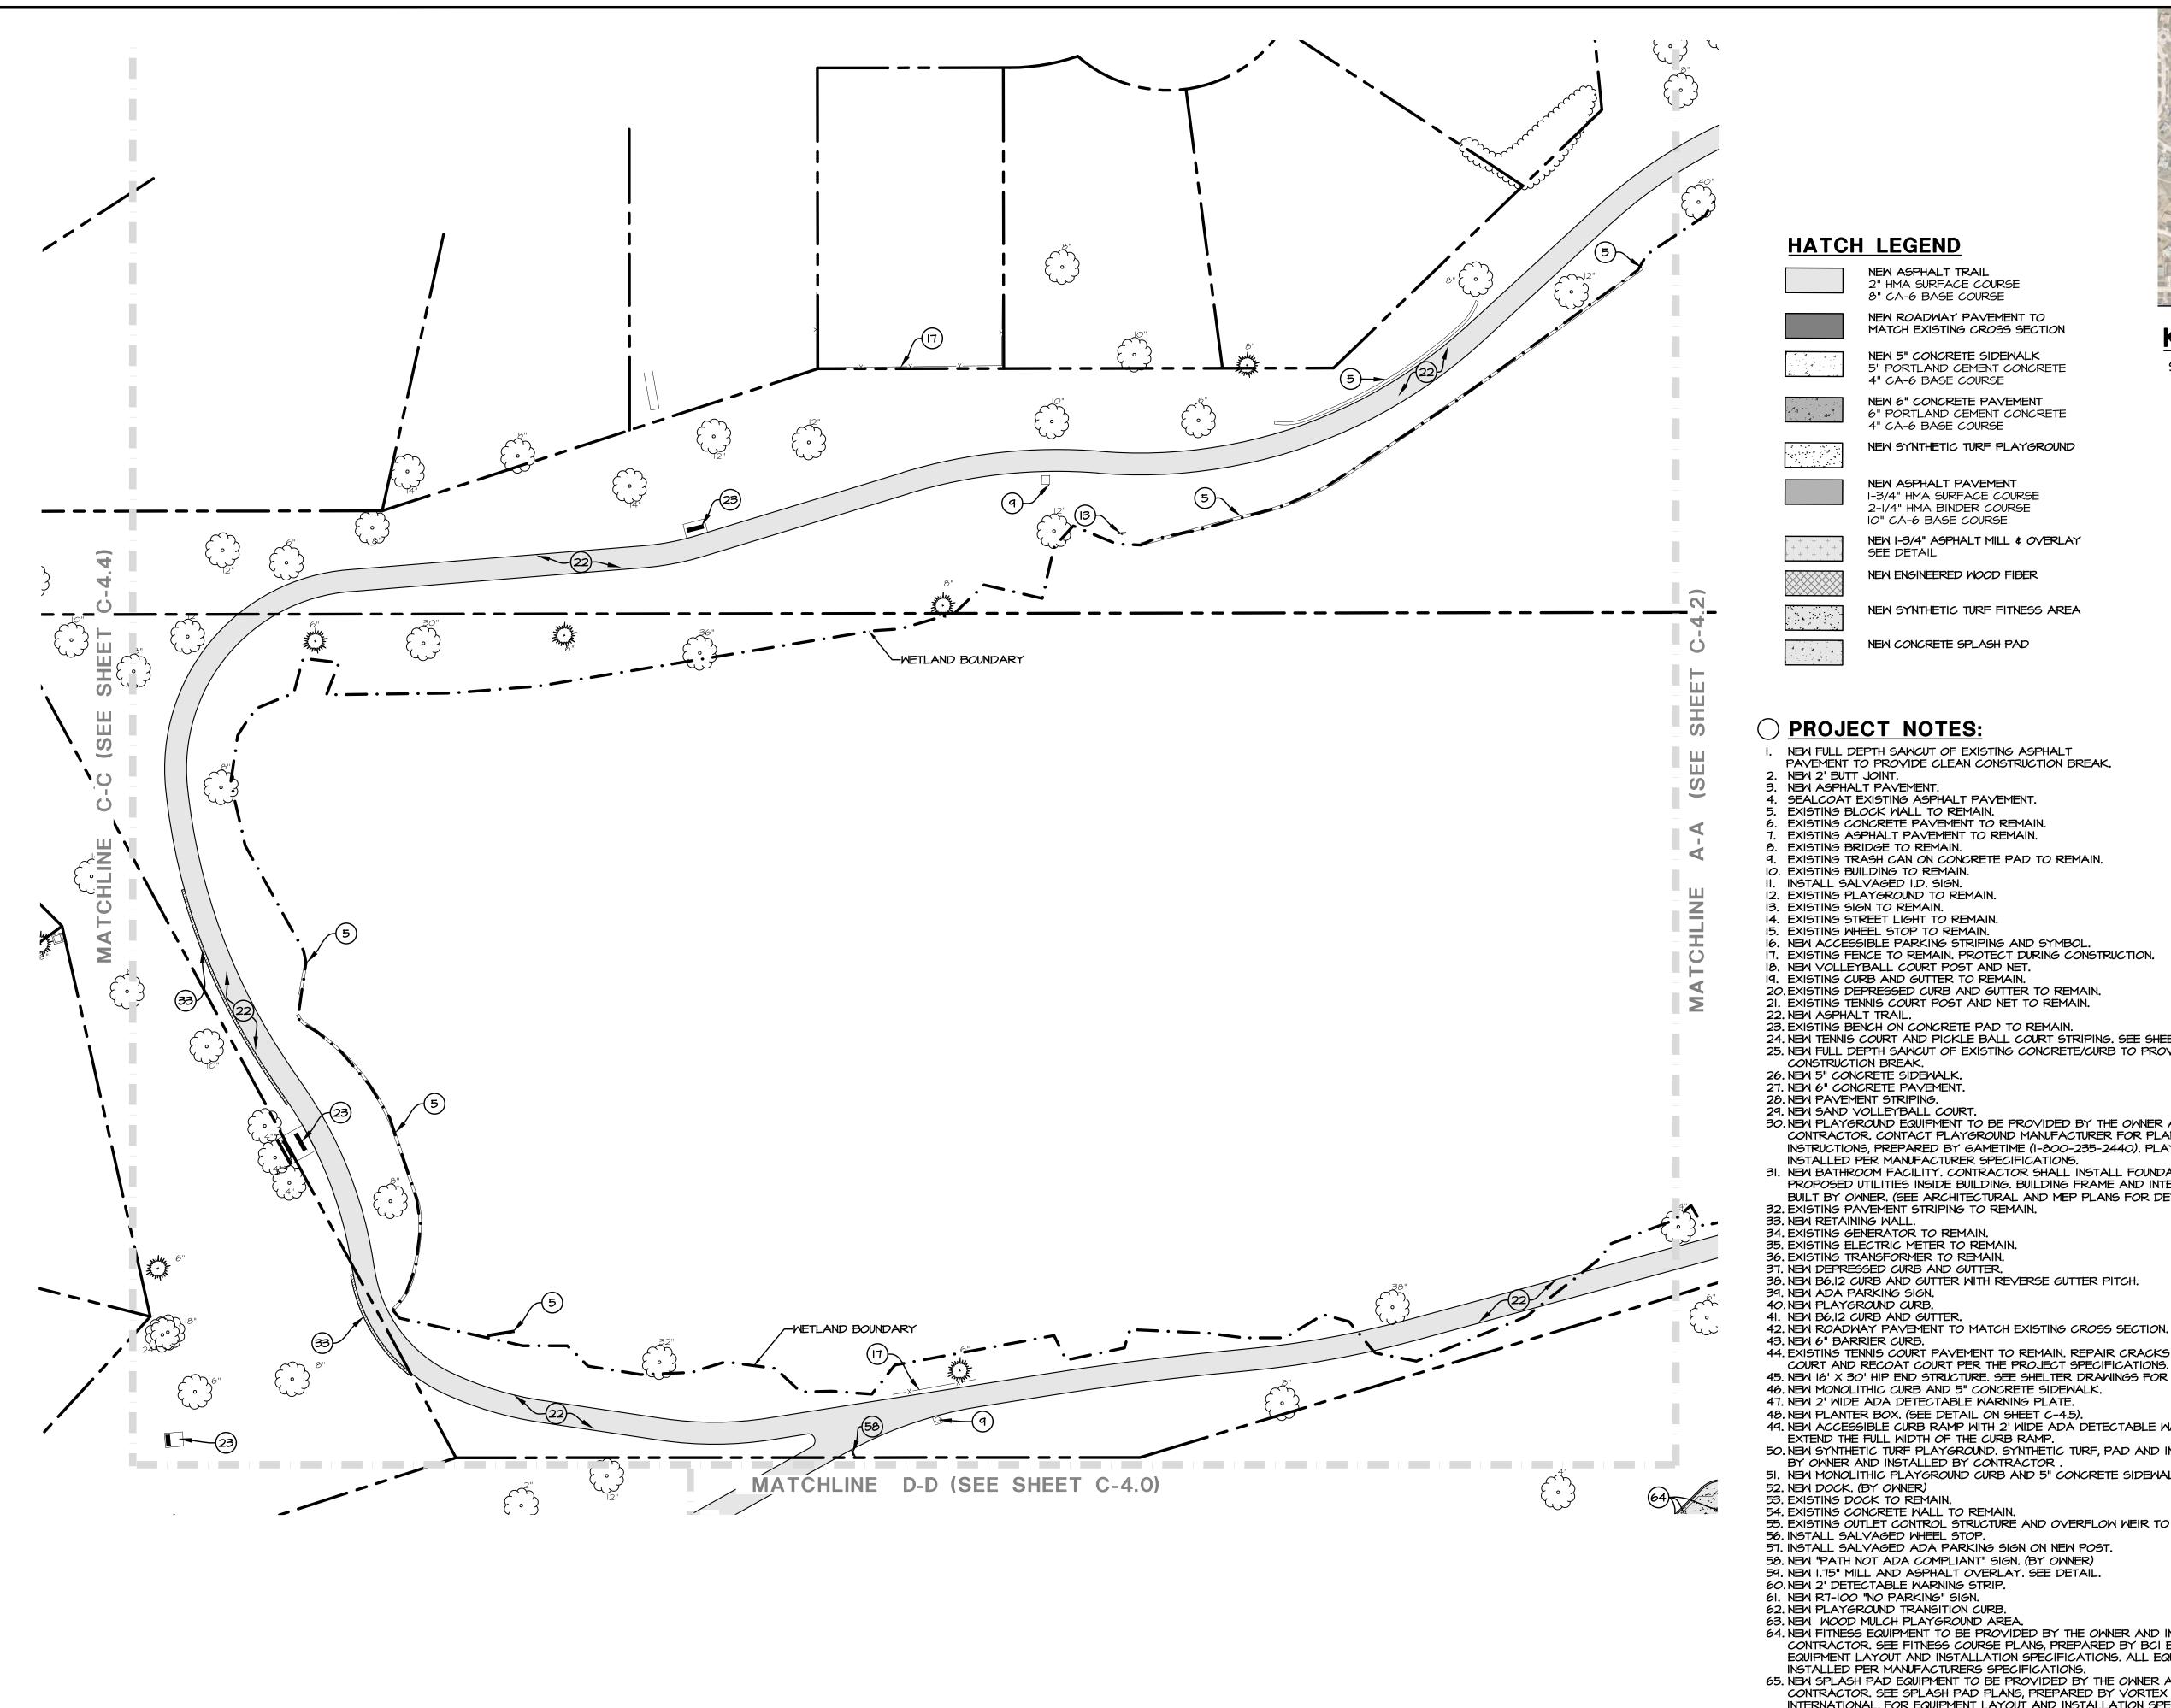



NEW ASPHALT TRAIL 2" HMA SURFACE COURSE 8" CA-6 BASE COURSE NEW ROADWAY PAVEMENT TO MATCH EXISTING CROSS SECTION

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NEW 6" CONCRETE PAYEMENT 6" PORTLAND CEMENT CONCRETE 4" CA-6 BASE COURSE

NEW SYNTHETIC TURF PLAYGROUND

NEW ASPHALT PAVEMENT 1-3/4" HMA SURFACE COURSE 2-1/4" HMA BINDER COURSE

IO" CA-6 BASE COURSE NEW I-3/4" ASPHALT MILL & OVERLAY SEE DETAIL

NEW SYNTHETIC TURF FITNESS AREA

NEW ENGINEERED WOOD FIBER

NEW CONCRETE SPLASH PAD

PROJECT NOTES:

NEW FULL DEPTH SAMOUT OF EXISTING ASPHALT PAVEMENT TO PROVIDE CLEAN CONSTRUCTION BREAK. 2. NEW 2' BUTT JOINT.

NEW ASPHALT PAVEMENT. 4. SEALCOAT EXISTING ASPHALT PAVEMENT. 5. EXISTING BLOCK WALL TO REMAIN.

EXISTING CONCRETE PAVEMENT TO REMAIN. EXISTING ASPHALT PAVEMENT TO REMAIN. EXISTING BRIDGE TO REMAIN. 9. EXISTING TRASH CAN ON CONCRETE PAD TO REMAIN.

INSTALL SALVAGED I.D. SIGN. 12. EXISTING PLAYGROUND TO REMAIN

14. EXISTING STREET LIGHT TO REMAIN. 15. EXISTING WHEEL STOP TO REMAIN. 16. NEW ACCESSIBLE PARKING STRIPING AND SYMBOL.

17. EXISTING FENCE TO REMAIN. PROTECT DURING CONSTRUCTION. 18. NEW VOLLEYBALL COURT POST AND NET. 19. EXISTING CURB AND GUTTER TO REMAIN.

20. EXISTING DEPRESSED CURB AND GUTTER TO REMAIN. 21. EXISTING TENNIS COURT POST AND NET TO REMAIN. 22. NEW ASPHALT TRAIL.

23. EXISTING BENCH ON CONCRETE PAD TO REMAIN. 24. NEW TENNIS COURT AND PICKLE BALL COURT STRIPING. SEE SHEET C-4.7 FOR LAYOUT. 25. NEW FULL DEPTH SAWCUT OF EXISTING CONCRETE/CURB TO PROVIDE CLEAN

CONSTRUCTION BREAK. 26. NEW 5" CONCRETE SIDEWALK. 27. NEW 6" CONCRETE PAVEMENT.

28. NEW PAYEMENT STRIPING. 29. NEW SAND VOLLEYBALL COURT. 30. NEW PLAYGROUND EQUIPMENT TO BE PROVIDED BY THE OWNER AND INSTALLED BY THE

CONTRACTOR. CONTACT PLAYGROUND MANUFACTURER FOR PLANS AND INSTALLATION INSTRUCTIONS, PREPARED BY GAMETIME (I-800-235-2440). PLAYGROUND SHALL BE INSTALLED PER MANUFACTURER SPECIFICATIONS. 31. NEW BATHROOM FACILITY. CONTRACTOR SHALL INSTALL FOUNDATIONS AND STUB

PROPOSED UTILITIES INSIDE BUILDING. BUILDING FRAME AND INTERIOR FIXTURES TO BE BUILT BY OWNER. (SEE ARCHITECTURAL AND MEP PLANS FOR DETAILS). 32. EXISTING PAVEMENT STRIPING TO REMAIN.

33. NEW RETAINING WALL. 34. EXISTING GENERATOR TO REMAIN. 35. EXISTING ELECTRIC METER TO REMAIN.

36. EXISTING TRANSFORMER TO REMAIN. 37. NEW DEPRESSED CURB AND GUTTER. 38. NEW B6.12 CURB AND GUTTER WITH REVERSE GUTTER PITCH.

39. NEW ADA PARKING SIGN. 40. NEW PLAYGROUND CURB. 41. NEW B6.12 CURB AND GUTTER.

43. NEW 6" BARRIER CURB. 44. EXISTING TENNIS COURT PAVEMENT TO REMAIN. REPAIR CRACKS WITHIN THE ASPHALT COURT AND RECOAT COURT PER THE PROJECT SPECIFICATIONS.

45. NEW 16' X 30' HIP END STRUCTURE. SEE SHELTER DRAWINGS FOR DETAILS 46. NEW MONOLITHIC CURB AND 5" CONCRETE SIDEWALK. 47. NEW 2' WIDE ADA DETECTABLE WARNING PLATE. 48. NEW PLANTER BOX. (SEE DETAIL ON SHEET C-4.5).

49. NEW ACCESSIBLE CURB RAMP WITH 2' WIDE ADA DETECTABLE WARNING PLATE TO EXTEND THE FULL WIDTH OF THE CURB RAMP. 50. NEW SYNTHETIC TURF PLAYGROUND. SYNTHETIC TURF, PAD AND INFILL TO BE SUPPLIED BY OWNER AND INSTALLED BY CONTRACTOR

51. NEW MONOLITHIC PLAYGROUND CURB AND 5" CONCRETE SIDEWALK. 52. NEW DOCK. (BY OWNER) 53. EXISTING DOCK TO REMAIN.

55. EXISTING OUTLET CONTROL STRUCTURE AND OVERFLOW WEIR TO REMAIN. 56. INSTALL SALVAGED WHEEL STOP. 57. INSTALL SALVAGED ADA PARKING SIGN ON NEW POST.

56. NEW "PATH NOT ADA COMPLIANT" SIGN. (BY OWNER) 59. NEW 1.75" MILL AND ASPHALT OVERLAY. SEE DETAIL. 60. NEW 2' DETECTABLE WARNING STRIP.

61. NEW R7-100 "NO PARKING" SIGN. 62. NEW PLAYGROUND TRANSITION CURB. 63. NEW WOOD MULCH PLAYGROUND AREA.

64. NEW FITNESS EQUIPMENT TO BE PROVIDED BY THE OWNER AND INSTALLED BY THE CONTRACTOR. SEE FITNESS COURSE PLANS, PREPARED BY BCI BURKE COMPANY, FOR EQUIPMENT LAYOUT AND INSTALLATION SPECIFICATIONS. ALL EQUIPMENT SHALL BE INSTALLED PER MANUFACTURERS SPECIFICATIONS.

65. NEW SPLASH PAD EQUIPMENT TO BE PROVIDED BY THE OWNER AND INSTALLED BY THE CONTRACTOR. SEE SPLASH PAD PLANS, PREPARED BY VORTEX AQUATIC STRUCTURES INTERNATIONAL, FOR EQUIPMENT LAYOUT AND INSTALLATION SPECIFICATIONS. SEE MEP PLANS FOR WATER AND SEWER PIPING WITHIN THE BUILDING AND PAD (SEE DETAIL).

66. NEW CONCRETE SPLASH PAD. PROVIDE EXPANSION JOINTS BETWEEN WALKS. CONTRACTOR SHALL PROVIDE EXPANSION JOINT LAYOUT FOR ENGINEER REVIEW. 67. NEW SYNTHETIC TURF FITNESS AREA. PERFECT TURF MAT, PAD, AND RUBBER INFILL TO BE PROVIDED BY OWNER.

68. NEW WINTERIZING PIT FOR WINTER SHUT DOWN. WALLS OF THE PIT SHALL BE 5" THICK CONCRETE. PROVIDE WATER TIGHT ACCESS GATE. BOTTOM OF THE PIT SHALL BE SET TO PROVIDE SUFFICIENT SLOPE FOR PIPING. 69. EXPANSION JOINT WITH WATER STOP.





SITE DEVELOPMENT NOTES:

A. EXISTING CONDITIONS AND TOPOGRAPHY SHOWN REPRESENTS SITE CONDITIONS PER THE PLAT OF SURVEY LAST DATED 6-16-2009 PREPARED BY ENGINEERING RESOURCE ASSOCIATES INC. CONTRACTOR SHALL FIELD VERIFY EXISTING ELEVATIONS AND CONDITIONS (INCLUDING BUT NOT LIMITED TO VERIFICATION OF CONTROL AND ALL UTILITIES WHETHER DEPICTED OR NOT) PRIOR TO CONSTRUCTION AND NOTIFY ENGINEER OF ANY DISCREPANCIES.

A.A. ADDITIONAL EXISTING TOPOGRAPHY AND UTILITY DATA SHOWN REPRESENTS SITE CONDITIONS MEASURED BY WIT LAND SURVEYING INC. ON 7-24-19.

B. CONTRACTOR SHALL NOTIFY THE ENGINEER OF ANY DISCREPANCIES WITH THE ARCHITECTURAL PLANS. C. SEE THE ARCHITECTURAL PLANS FOR THE DESIGN OF ALL

BUILDING ENTRIES. D. CONTRACTOR SHALL COORDINATE ALL LANDSCAPING

IMPROVEMENTS WITH LANDSCAPE PLANS. E. CONSTRUCTION SURVEY AND STAKEOUT SHALL BE THE RESPONSIBILITY OF THE CONTRACTOR.

F. ALL EXISTING TREES SHOWN ARE TO REMAIN UNLESS OTHERWISE

G. CONTRACTOR SHALL RESTORE ALL DISTURBED AREAS OUTSIDE OF CONSTRUCTION LIMITS TO ORIGINAL CONDITION OR BETTER. H. ASPHALT PAVEMENT MARKINGS SHALL BE MADE WITH HIGH

QUALITY PAINT CONFORMING TO ARTICLE 1095.02 OF THE IDOT STANDARD SPECIFICATIONS. CONTRACTOR SHALL RESTORE ALL DISTURBED GREEN SPACES WITH 6" OF TOPSOIL, SEED, AND EROSION CONTROL BLANKET.

J. CONTRACTOR SHALL REPAIR AT HIS EXPENSE ANY DAMAGE TO EXISTING ASPHALT, CONCRETE, CURBS, SIDEWALKS, ETC. RESULTING FROM CONSTRUCTION TRAFFIC AND/OR OPERATIONS. REPAIRS SHALL BE MADE TO THE SATISFACTION OF THE OWNER AND/OR ENGINEER

K. CONTRACTOR SHALL RE-STRIPE ALL STRIPING DISTURBED WITHIN THE EXISTING ROADWAYS/PARKING LOT TO MATCH EXISTING. L. CONTRACTOR SHALL HIRE A PRIVATE UTILITY LOCATOR TO LOCATE UTILITIES PRIOR TO CONSTRUCTION AND SHALL CONTACT

THE SITE ENGINEER IF A CONFLICT EXISTS. M. ALL ITEMS MARKED "EXISTING" TO BE PROTECTED FROM DAMAGE FOR THE DURATION OF CONSTRUCTION.

N. ALL EXISTING SUBGRADE TO BE SCARIFIED (DISKED) TO A DEPTH OF 12" AND RE-COMPACTED, AND THEN TESTED USING A DYNAMIC CONE PENETROMETER. SEE GEOTECHNICAL REPORT FOR ADDITIONAL REQUIREMENTS.

I" = 30'

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VILLAGE 8/23/19 MWRD 9/17/19 MWRD 10/22/19 11/25/19 VILLAGE




MWRD

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HECK: CMS DRAWN: PS 1911354C

SITE DEVELOPMENT PLAN

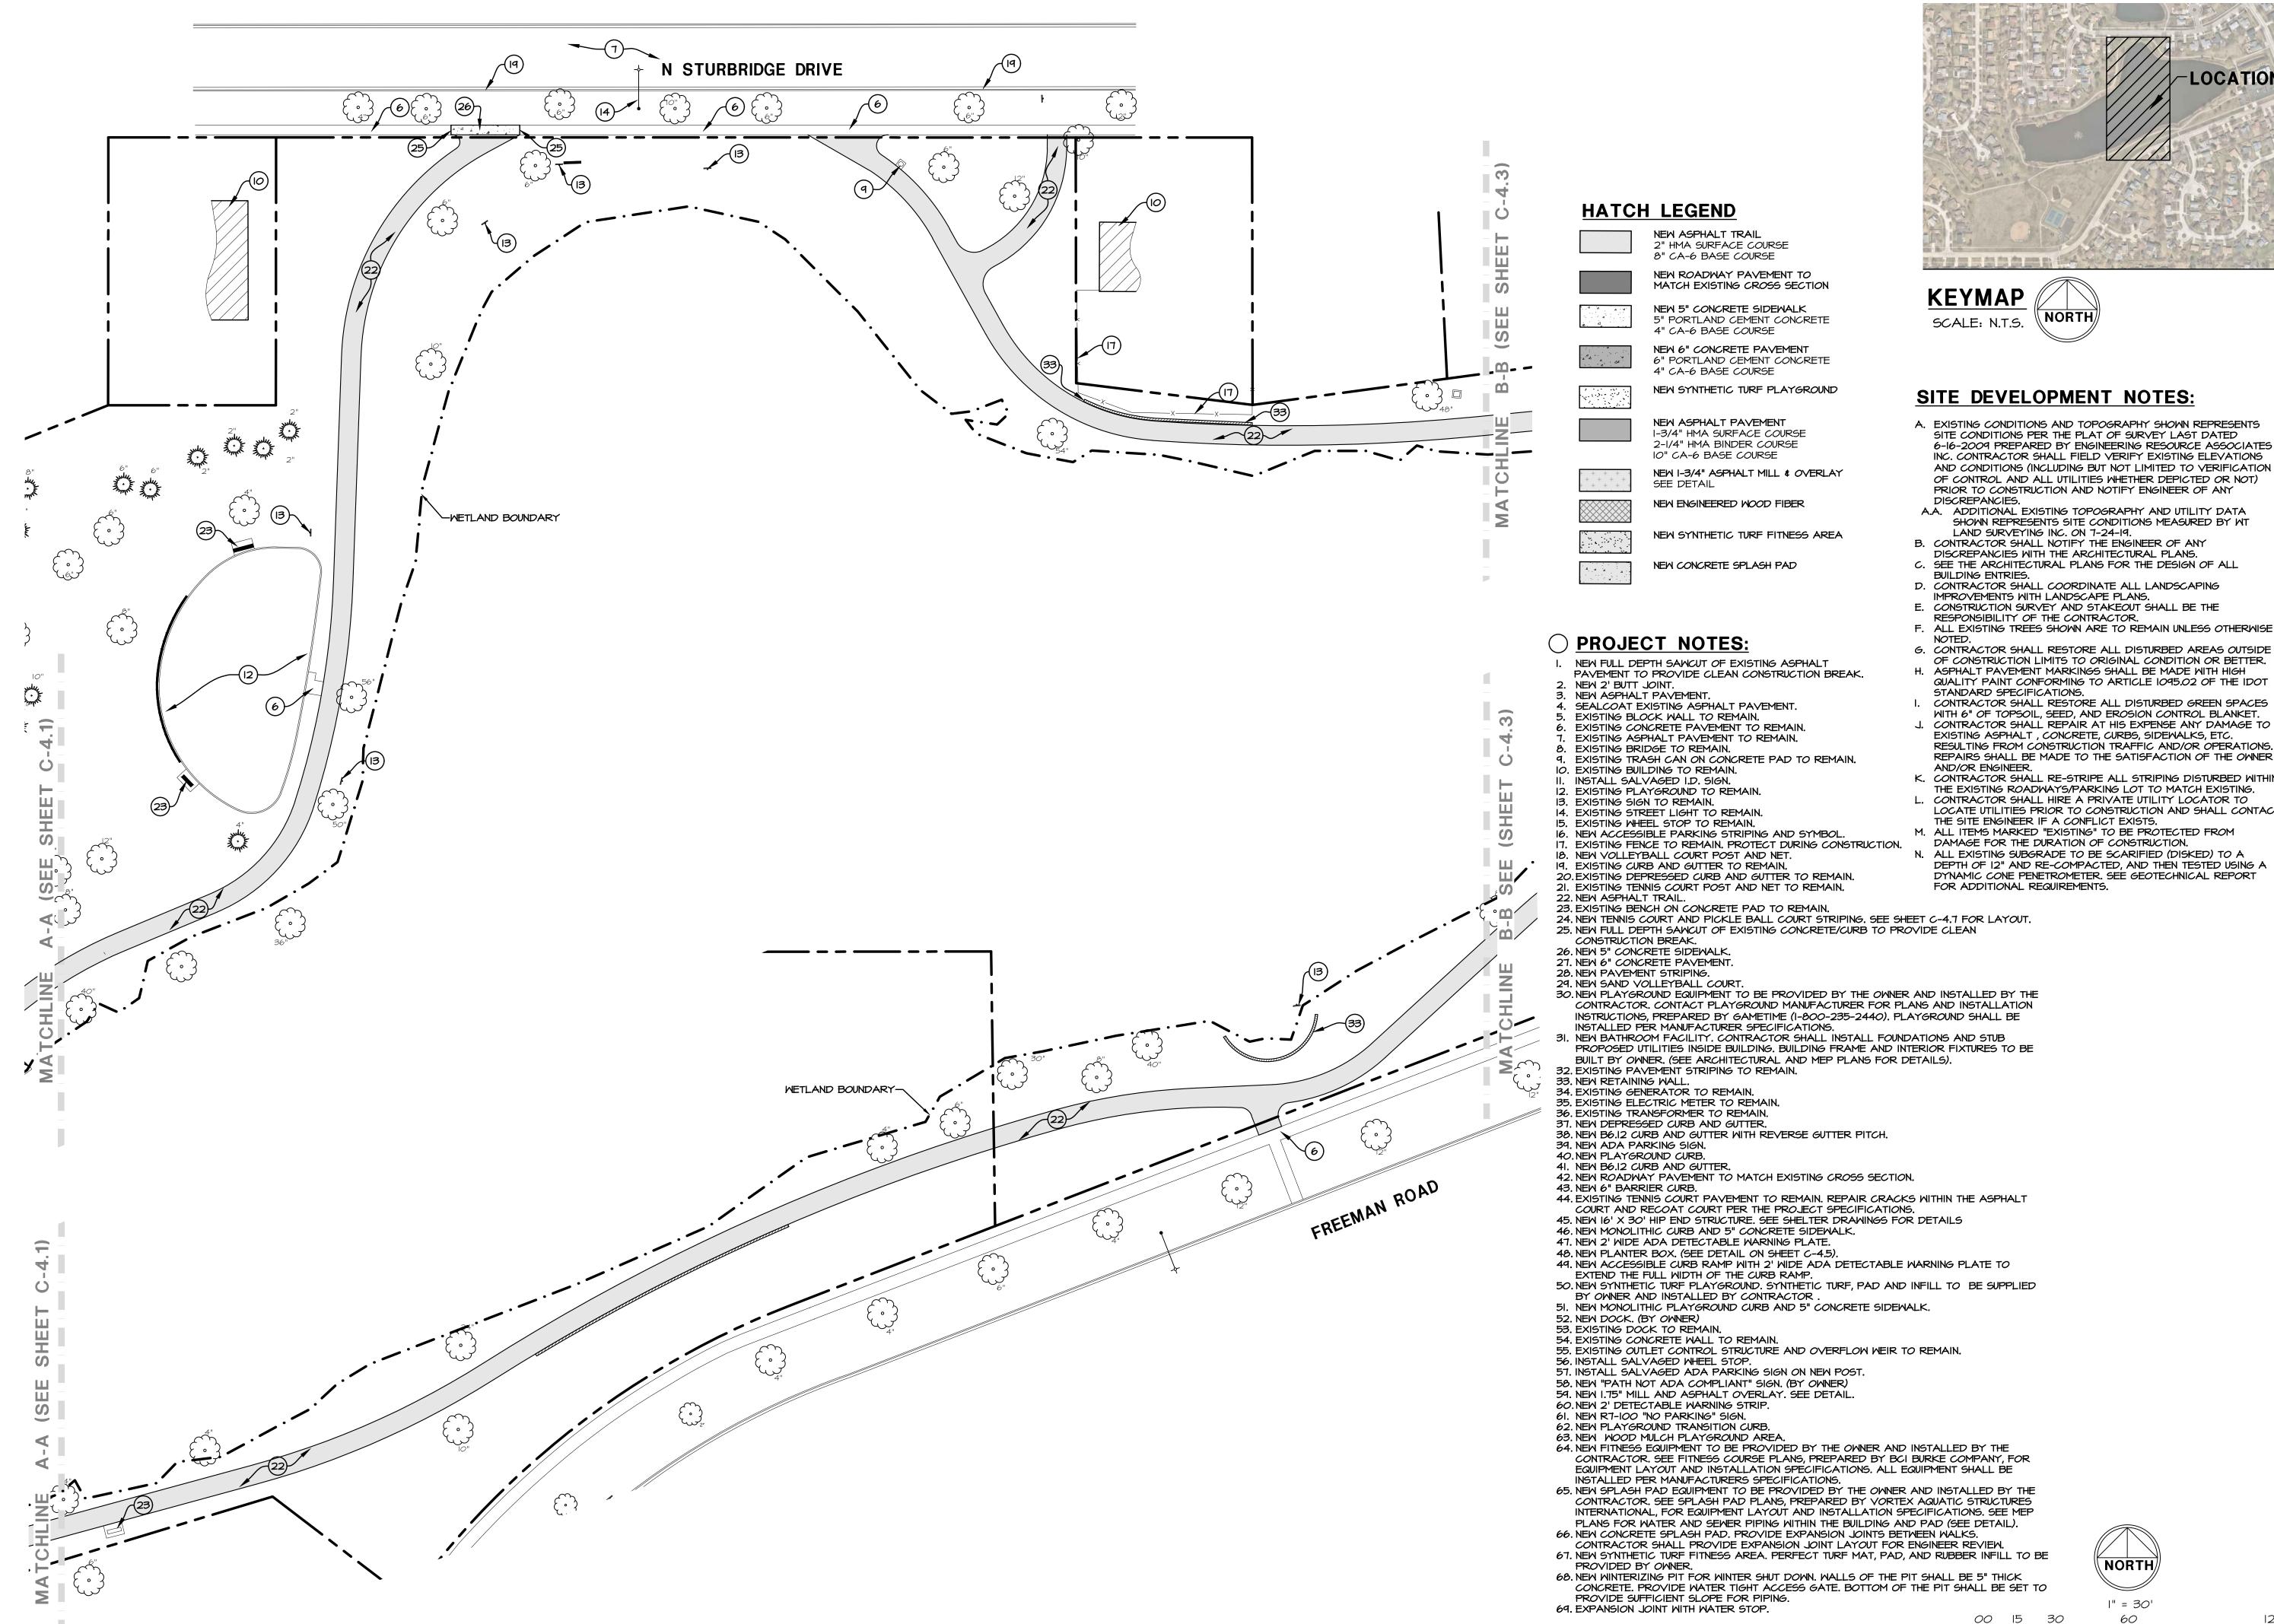

LOCATION

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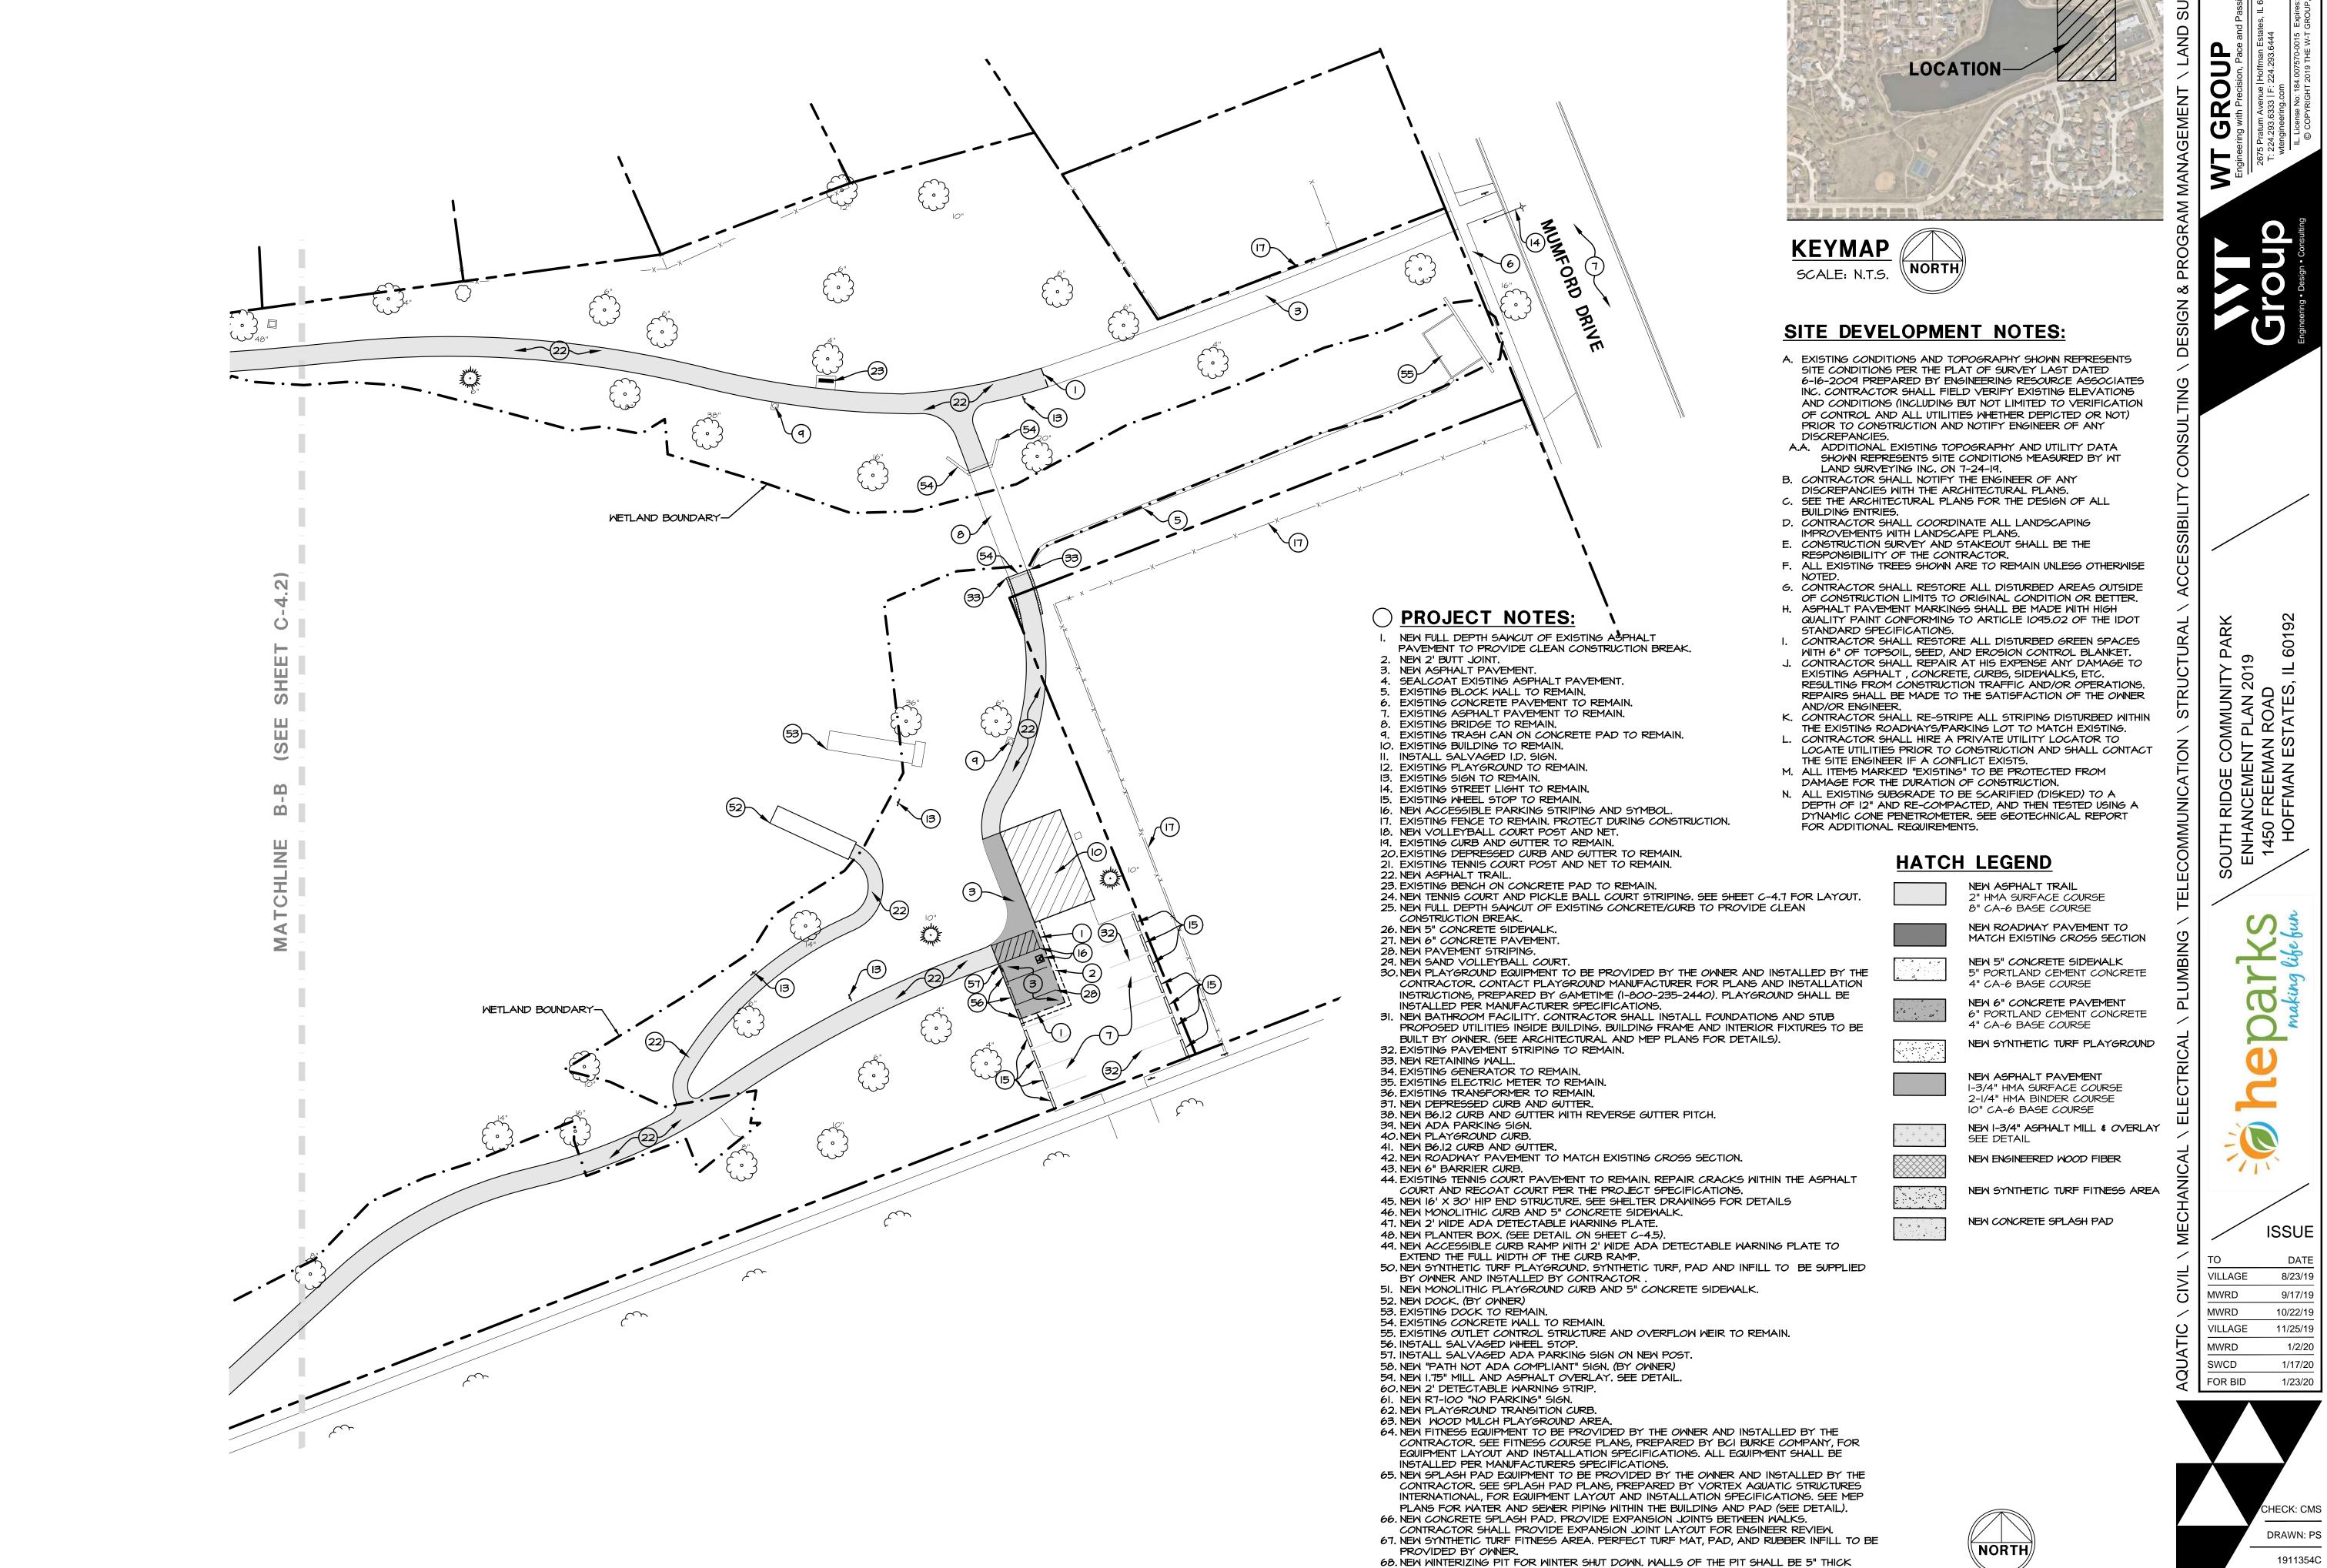
VILLAGE 8/23/19 MWRD VILLAGE SWCD

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DRAWN: PS 1911354C

SITE DEVELOPMENT PLAN



CONCRETE. PROVIDE WATER TIGHT ACCESS GATE. BOTTOM OF THE PIT SHALL BE SET TO

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69. EXPANSION JOINT WITH WATER STOP.

8/23/19 9/17/19 10/22/19 11/25/19


SITE DEVELOPMENT PLAN

120

I" = 30'


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- NEW FULL DEPTH SAWCUT OF EXISTING ASPHALT PAVEMENT TO PROVIDE CLEAN CONSTRUCTION BREAK.
- 2. NEW 2' BUTT JOINT.
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SITE DEVELOPMENT NOTES:

SCALE: N.T.S.

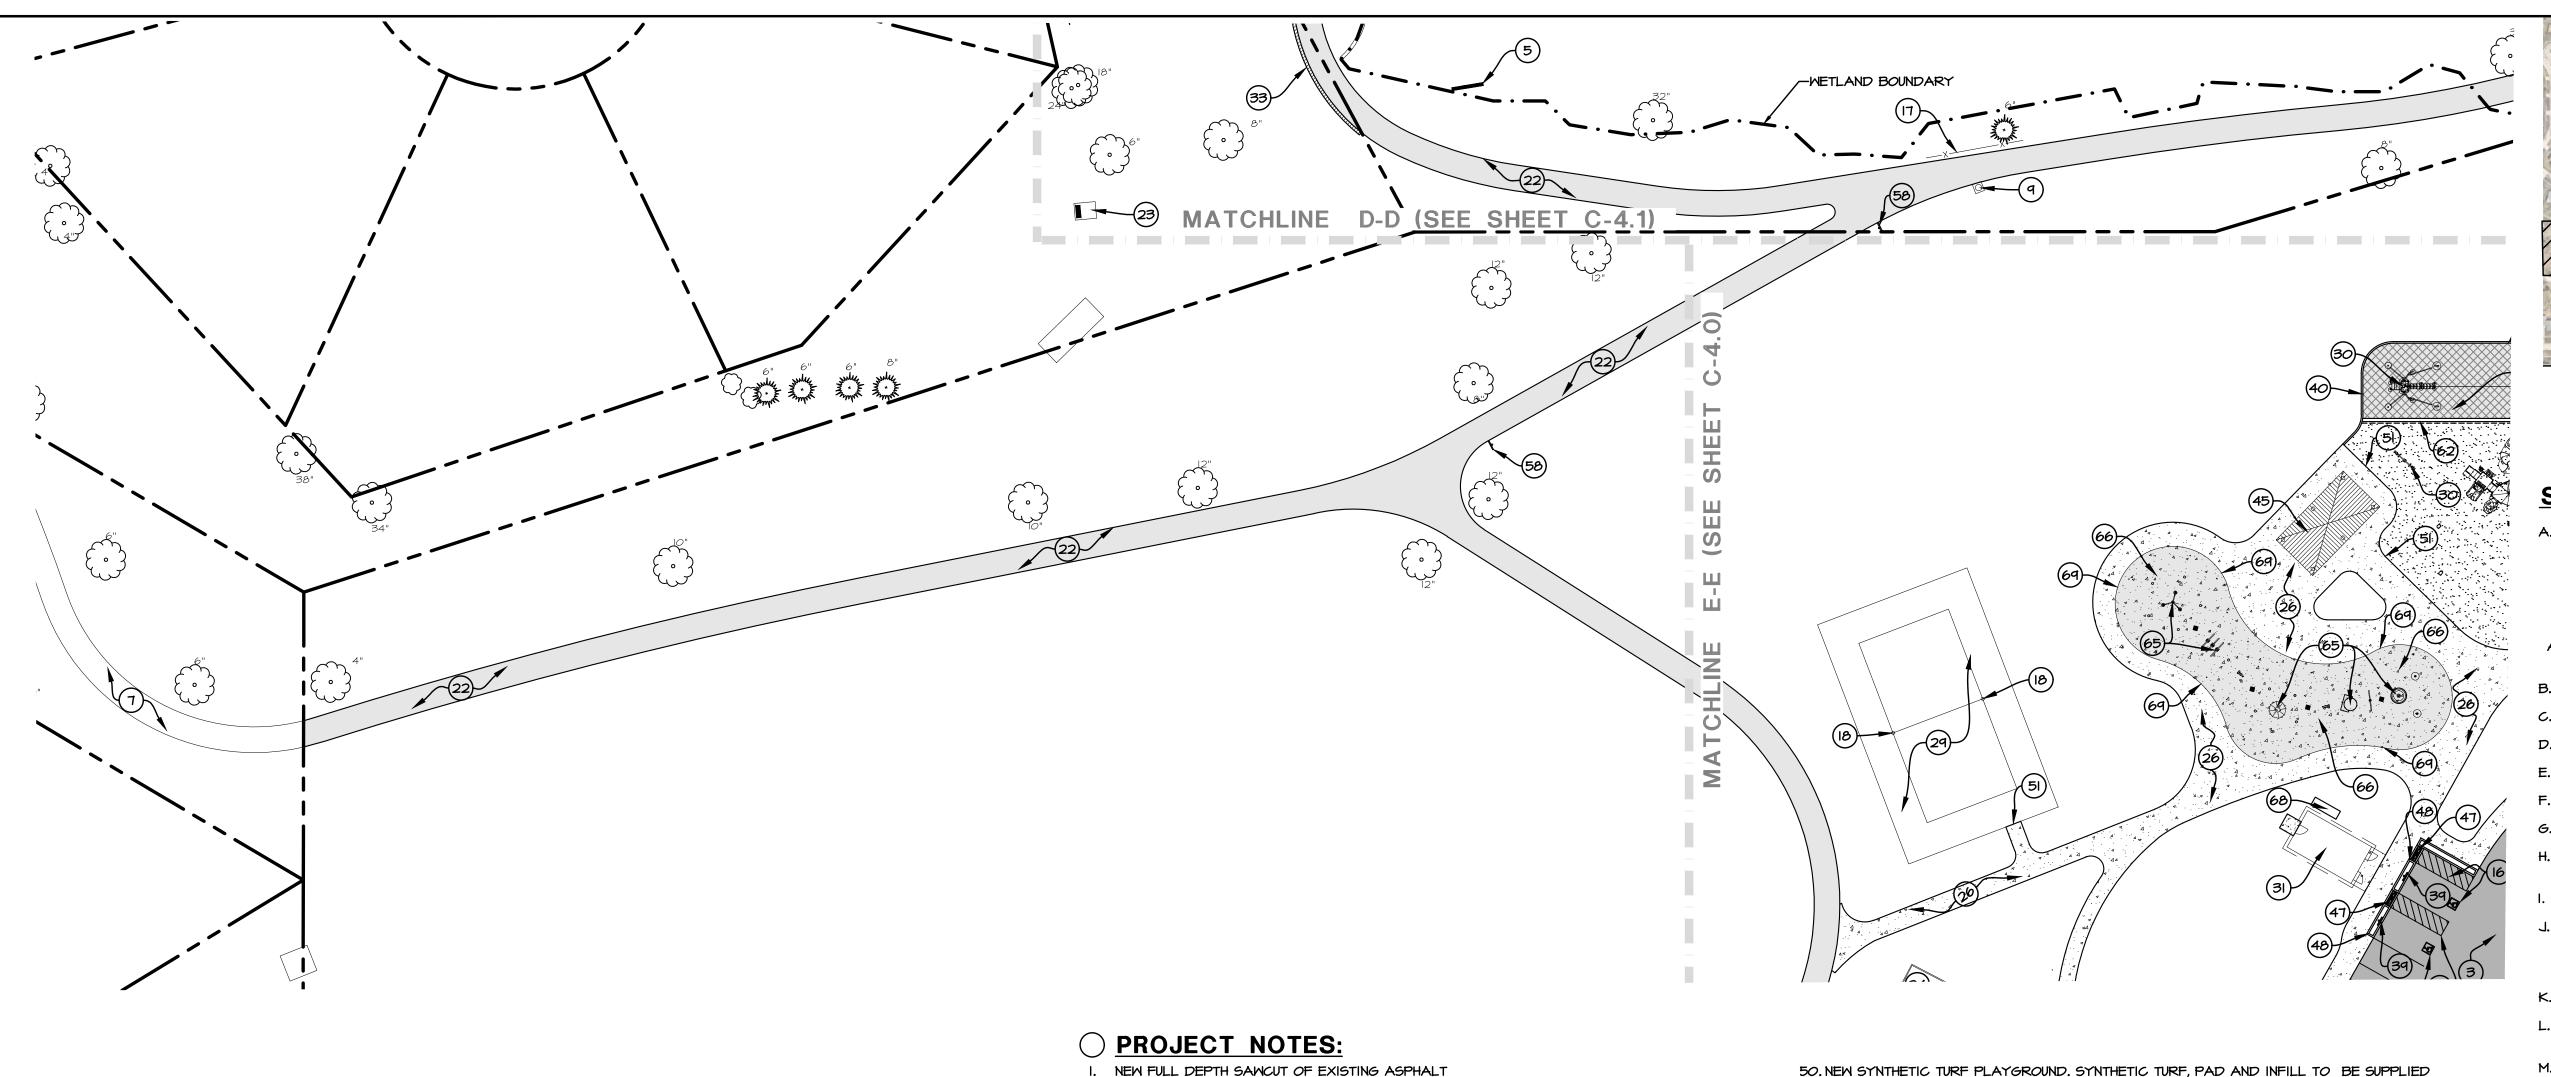NORTH

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NEW SYNTHETIC TURF PLAYGROUND

NEW ASPHALT PAYEMENT 1-3/4" HMA SURFACE COURSE 2-1/4" HMA BINDER COURSE IO" CA-6 BASE COURSE

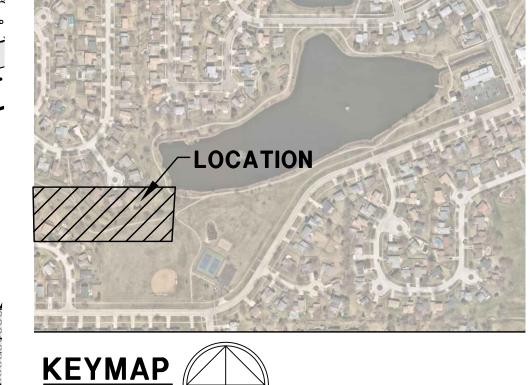NEW I-3/4" ASPHALT MILL & OVERLAY SEE DETAIL

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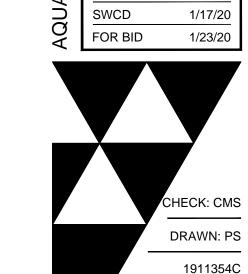
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VILLAGE 8/23/19 MWRD 9/17/19 MWRD 10/22/19 VILLAGE 11/25/19


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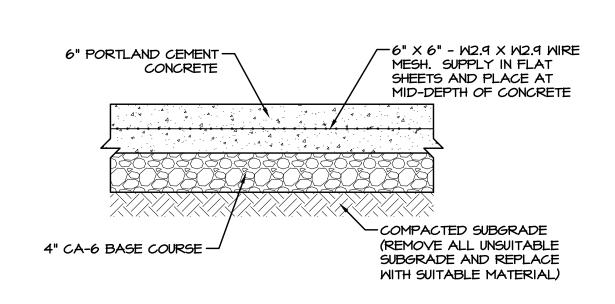


MWRD

SITE DEVELOPMENT PLAN


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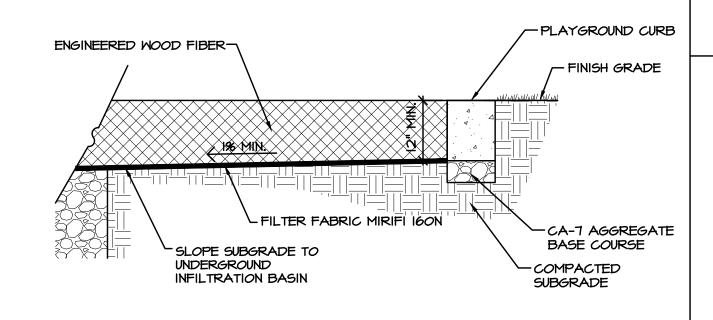


DETAIL - 6" CONCRETE SIDEWALK

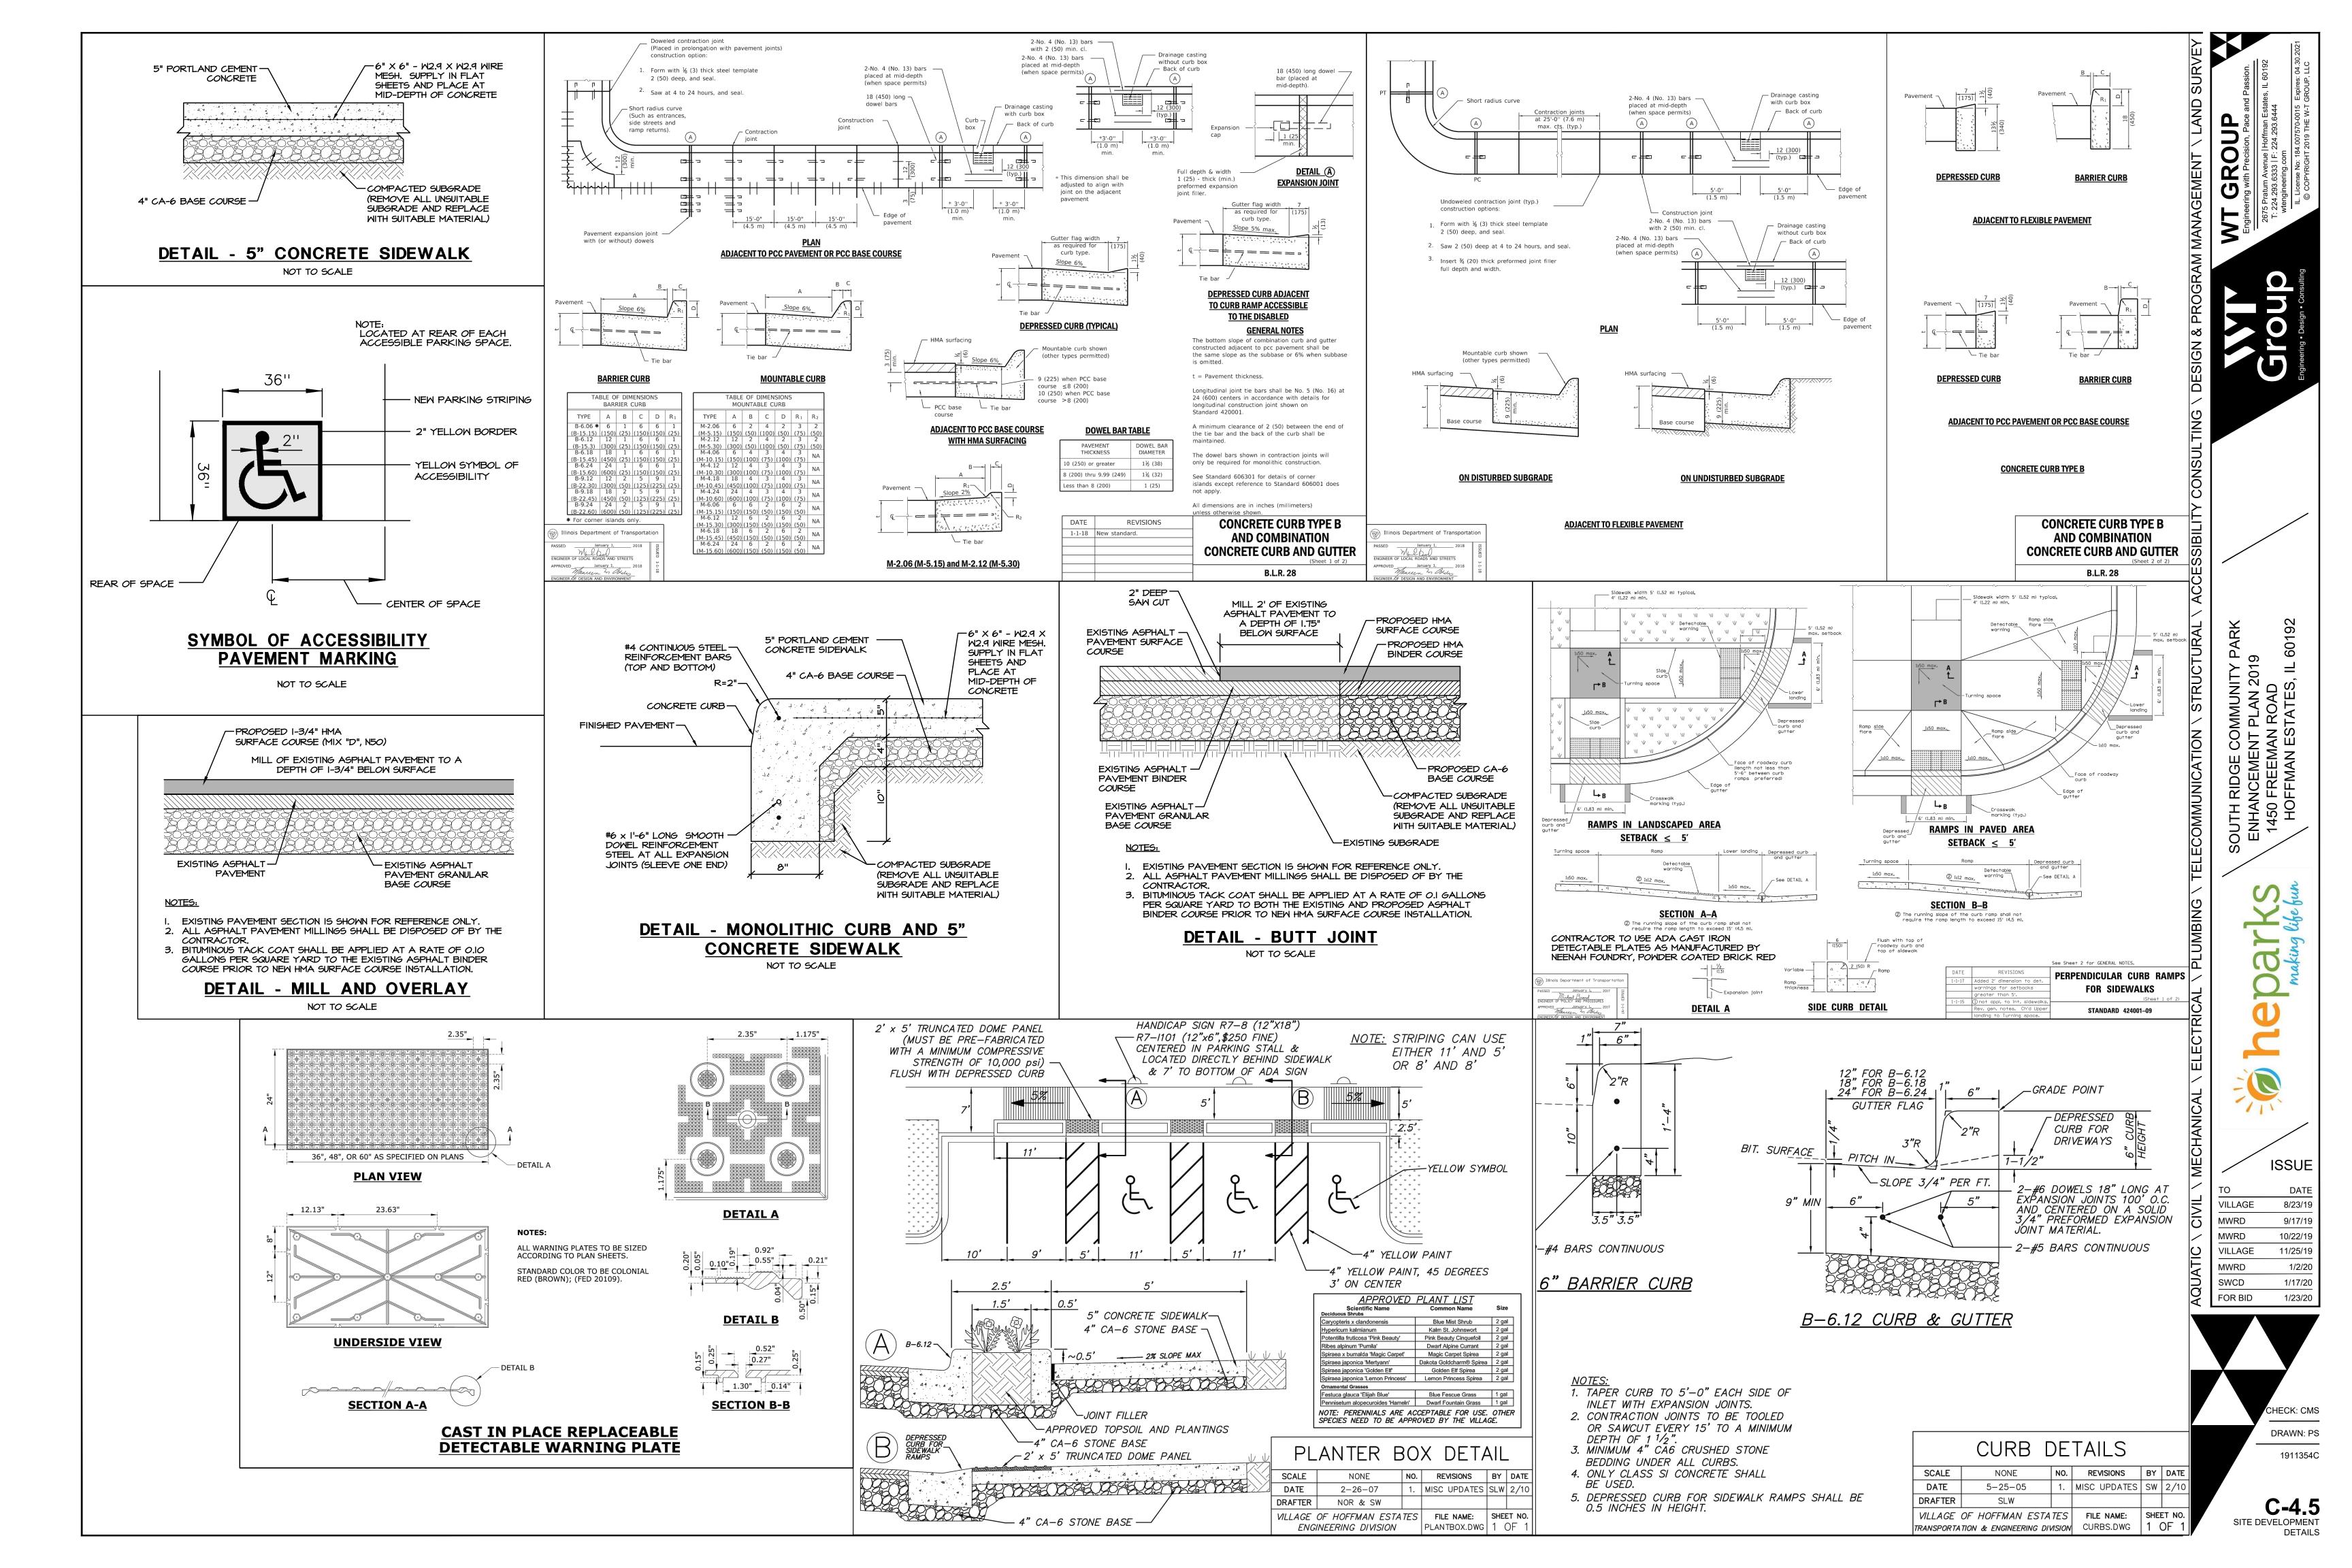
NOT TO SCALE



DETAIL - SAND VOLLEYBALL COURT SECTION

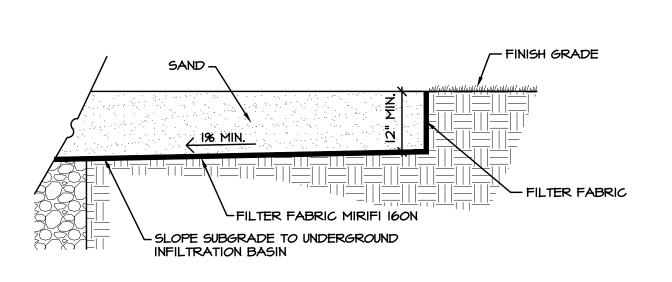


DETAIL - ENGINEERED WOOD FIBER SECTION
NOT TO SCALE

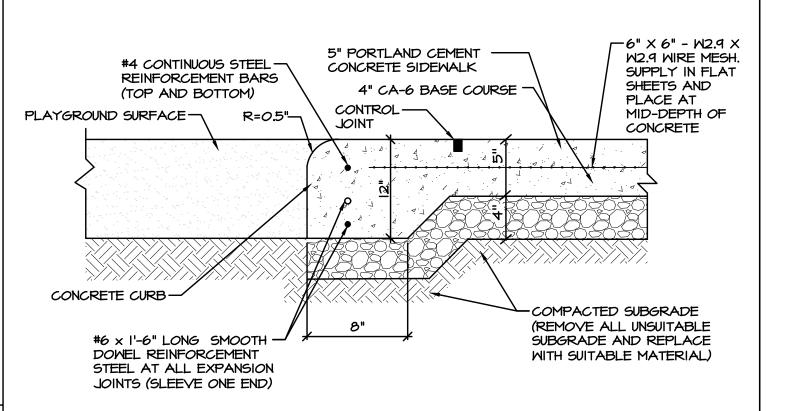


DETAIL - MONOLITHIC PLAYGROUND CURB AND 5" CONCRETE SIDEWALK


NOT TO SCALE

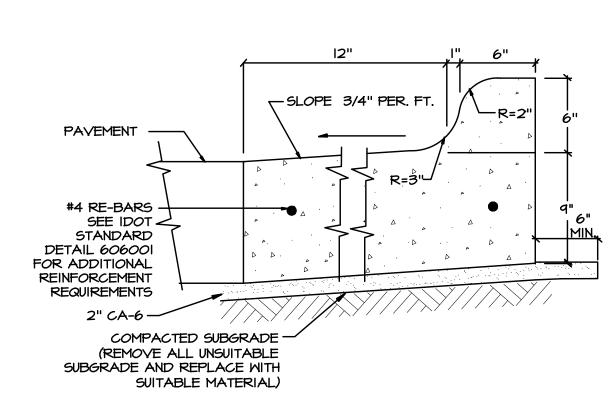


DETAIL-B6-12 CURB & GUTTER (REVERSE GUTTER PITCH) NOT TO SCALE

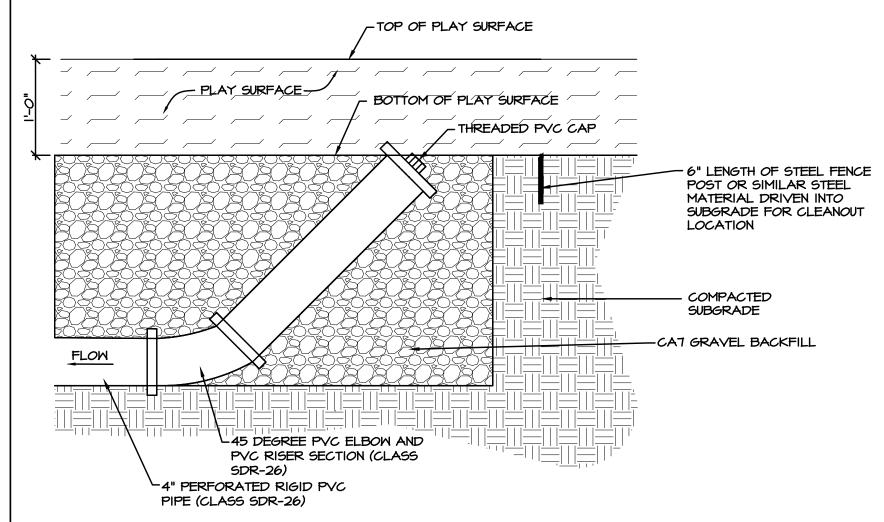

DETAIL - PLAYGROUND CLEAN OUT (WITHIN PLAYGROUND)

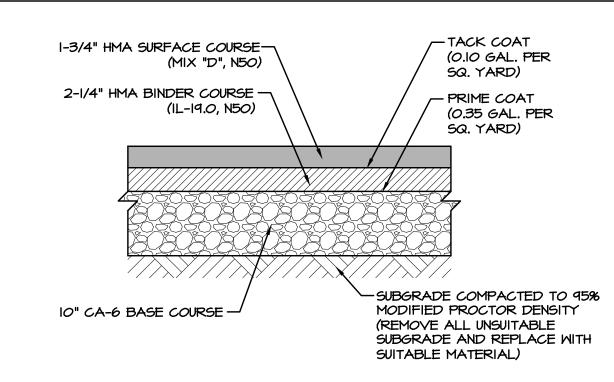



DETAIL - ASPHALT PAVEMENT NOT TO SCALE

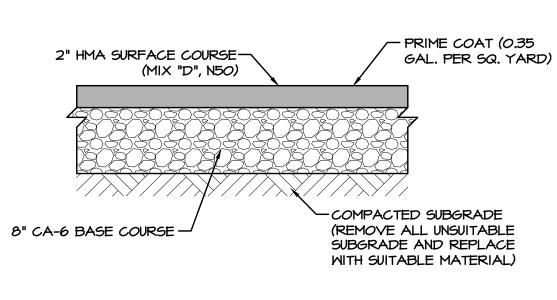

DETAIL - ASPHALT TRAIL

NOT TO SCALE

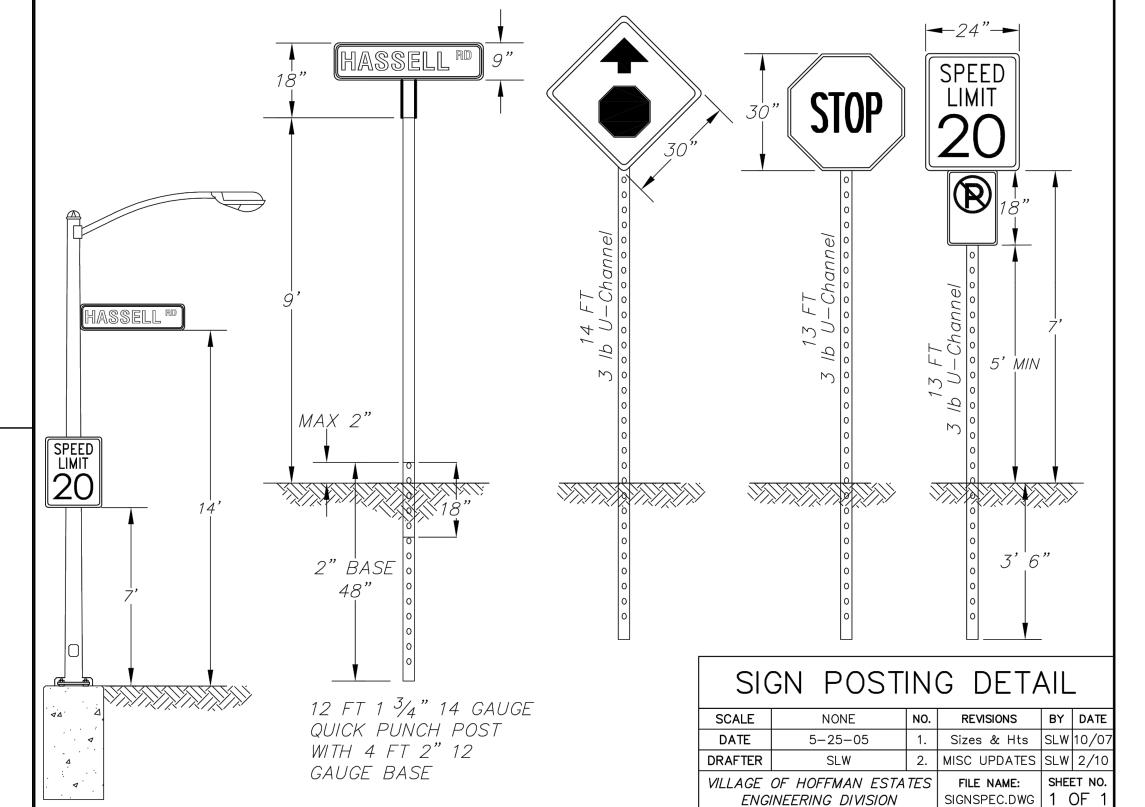

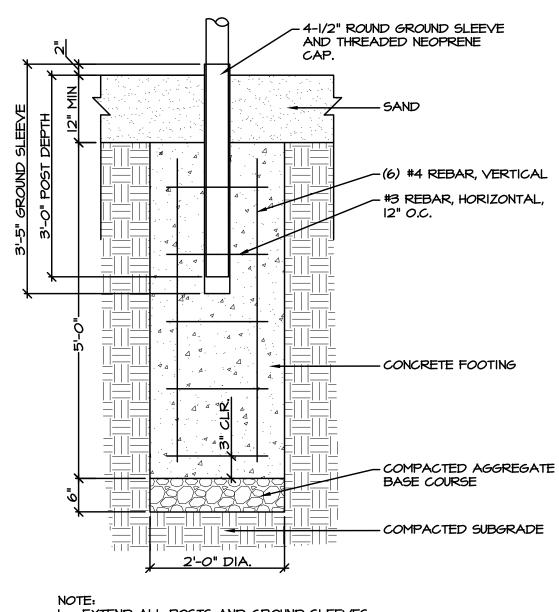


NOTE:

I. EXTEND ALL POSTS AND GROUND SLEEVES
TO ACCOMMODATE SAND DEPTH.

2. TOP PORTION OF THE SLEEVE TO BE
PANTED YELLOW.

DETAIL - VOLLEYBALL POST FOOTING
NOT TO SCALE

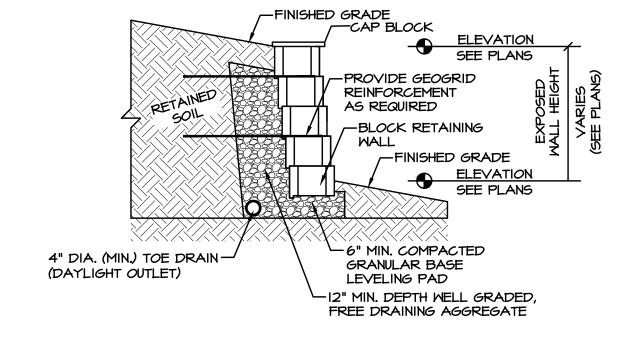

NOTES:

- I. DETAIL PROVIDED FOR CROSS SECTION PURPOSES ONLY.
- 2. REFER TO PLANS FOR RETAINING WALL LOCATIONS AND ELEVATIONS.


 3. CONTRACTOR SHALL PROVIDE SHOP DRAWINGS AND CALCULATIONS SIGNED SIGNED AND CALCULATIONS SIGNED SIGNED
- SEALED BY AN ILLINOIS LICENSED STRUCTURAL ENGINEER PRIOR TO CONSTRUCTION.

 4. CONTRACTOR SHALL INSTALL RETAINING WALL IN ACCORDANCE WITH APPROVED MANUFACTURER'S GUIDELINES AND SPECIFICATIONS.
- MANUFACTURER'S GUIDELINES AND SPECIFICATIONS.

 5. RETAINING ALL SHALL BE AULTWALL BY READING ROCK OVERSIZED BEVELED FACE RETAINING WALL. CONTRACTOR SHALL PROVIDE RETAINING WALL MATERIAL SAMPLES TO THE OWNER, ARCHITECT AND/OR ENGINEER FOR APPROVAL AND COLOR SELECTION PRIOR TO CONSTRUCTION.


DETAIL - RETAINING WALL

NOT TO SCALE

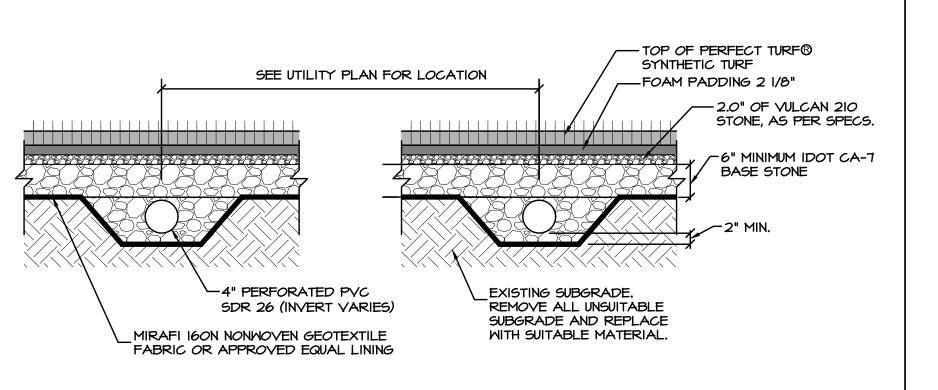

DETAIL - UNDERDRAIN BELOW SYNTHETIC TURF PLAYGROUND AND FITNESS AREA

NOT TO SCALE

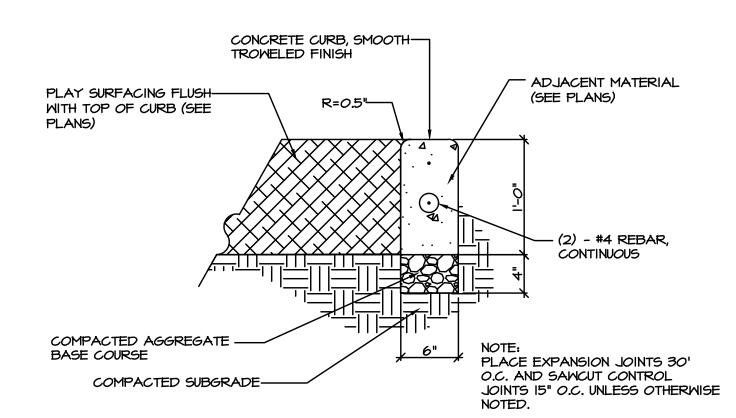

PLAYGROUND CURB


TO DATE
VILLAGE 8/23/19
MWRD 9/17/19
MWRD 10/22/19
VILLAGE 11/25/19
MWRD 1/2/20
SWCD 1/17/20
FOR BID 1/23/20

NITY PARK I 2019

SOUT ENH 145

DRAWN: PS

C-4.6
SITE DEVELOPMENT
DETAILS

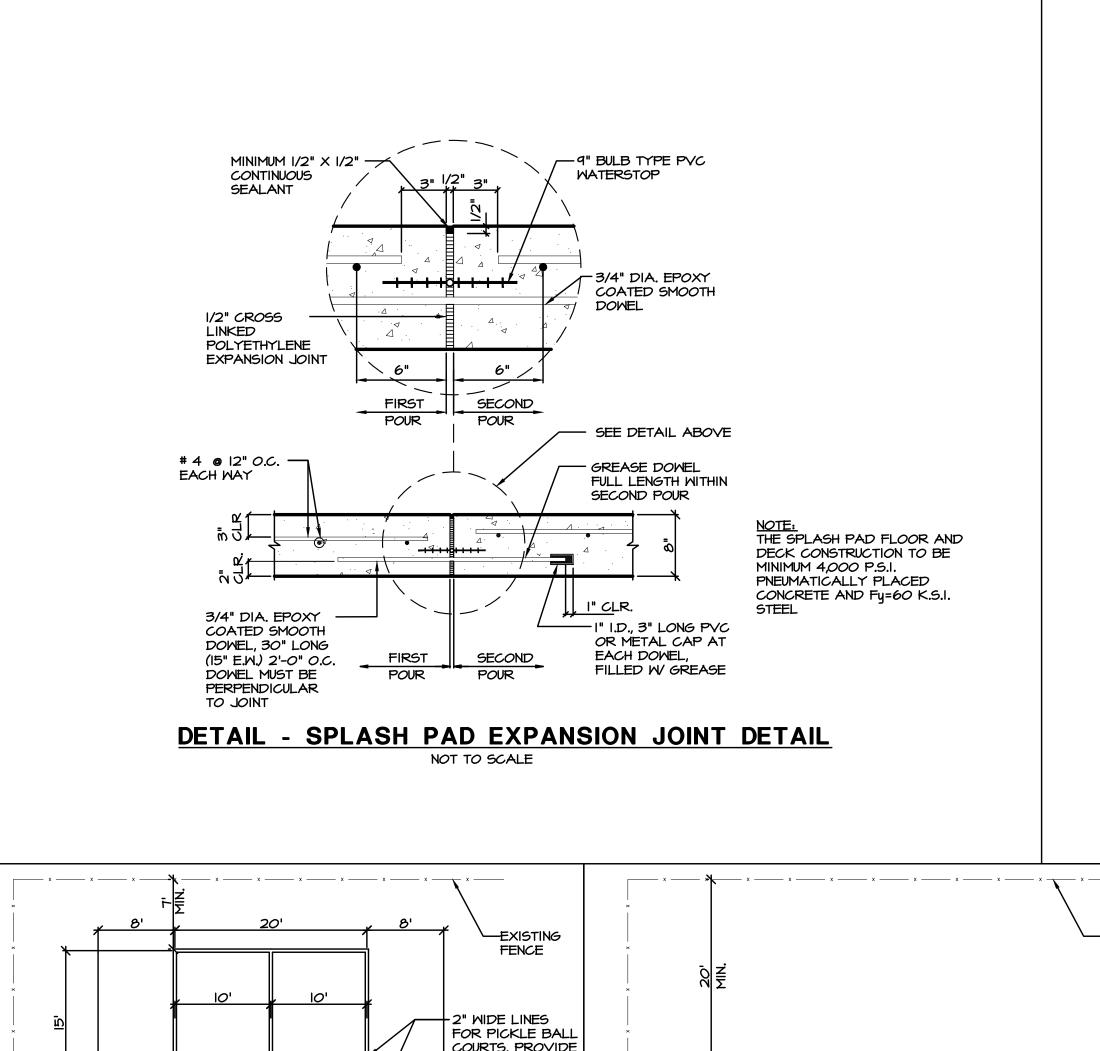

A CONTRASTING COLOR TO THE

-2" WIDE

STRIPE

(TYP)

4" LONG -

CENTER MARK

__ x ____ x

I. ALL TENNIS COURT DIMENSIONS ARE TO

THE CENTERLINE OF THE 2" WIDE STRIPE.

DETAIL - TENNIS COURT PLAN

TENNIS COURT LINES. (TYP)

-PORTABLE PICKLE BALL NETS BY OWNER


COURT PLAN

DIMENSIONS

I. ALL PICKLE BALL COURT DIMENSIONS ARE TO

THE CENTERLINE OF THE 2" WIDE STRIPE.

DETAIL - PICKLE BALL COURT PLAN

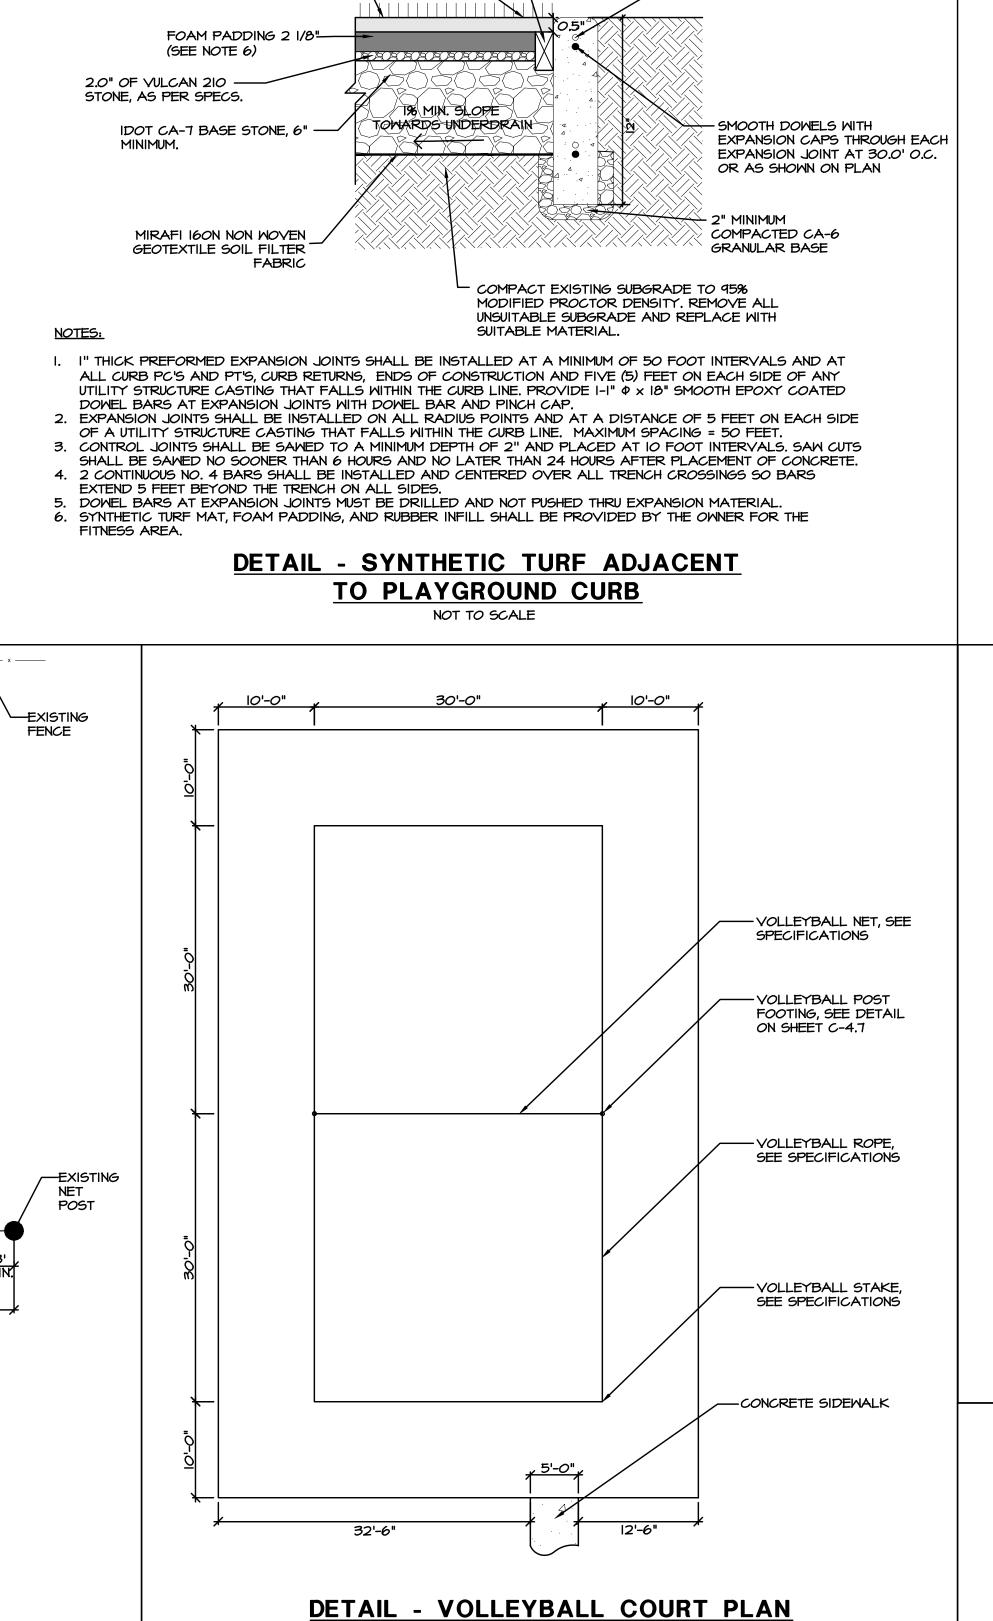

- 2 - #4 REBARS CONTINUOUS

(BETWEEN EXPANSION JOINTS)

2" x 4" NEW PLASTIC NAILER BOARD MADE .

ENDS AND NO MORE THAN 16" ON CENTER

RECOMMENDATIONS.

CONNECTED TO CURB NO MORE THAN 6" FROM

NAIL OR TACK SYNTHETIC TURF TO 2" x 4"


NEW PLASTIC NAILER BOARD MADE FROM

PERFECT TURF SYNTHETIC TURF®-

RECYCLED MATERIALS PER MANUFACTURERS

(SEE NOTE 6)

FROM RECYCLED MATERIALS TO BE

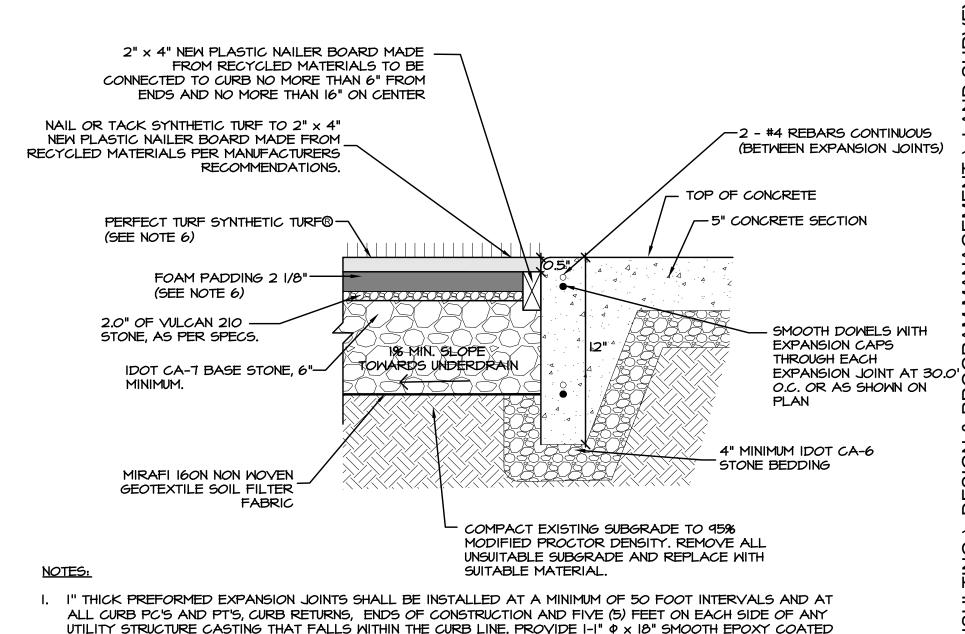


UTILITY STRUCTURE CASTING THAT FALLS WITHIN THE CURB LINE. PROVIDE I-I" $\phi \times 16$ " SMOOTH EPOXY COATED DOWEL BARS AT EXPANSION JOINTS WITH DOWEL BAR AND PINCH CAP.

2. EXPANSION JOINTS SHALL BE INSTALLED ON ALL RADIUS POINTS AND AT A DISTANCE OF 5 FEET ON EACH SIDE OF A UTILITY STRUCTURE CASTING THAT FALLS WITHIN THE CURB LINE. MAXIMUM SPACING = 50 FEET. 3. CONTROL JOINTS SHALL BE SAWED TO A MINIMUM DEPTH OF 2" AND PLACED AT 10 FOOT INTERVALS. SAW CUTS

SHALL BE SAMED NO SOONER THAN 6 HOURS AND NO LATER THAN 24 HOURS AFTER PLACEMENT OF CONCRETE. 4. 2 CONTINUOUS NO. 4 BARS SHALL BE INSTALLED AND CENTERED OVER ALL TRENCH CROSSINGS SO BARS EXTEND 5 FEET BEYOND THE TRENCH ON ALL SIDES.

. DOWEL BARS AT EXPANSION JOINTS MUST BE DRILLED AND NOT PUSHED THRU EXPANSION MATERIAL. 6. SYNTHETIC TURF MAT, FOAM PADDING, AND RUBBER INFILL SHALL BE PROVIDED BY THE OWNER FOR THE FITNESS AREA.


DETAIL - SYNTHETIC TURF ADJACENT TO MONOLITHIC PLAYGROUND SIDEWALK NOT TO SCALE

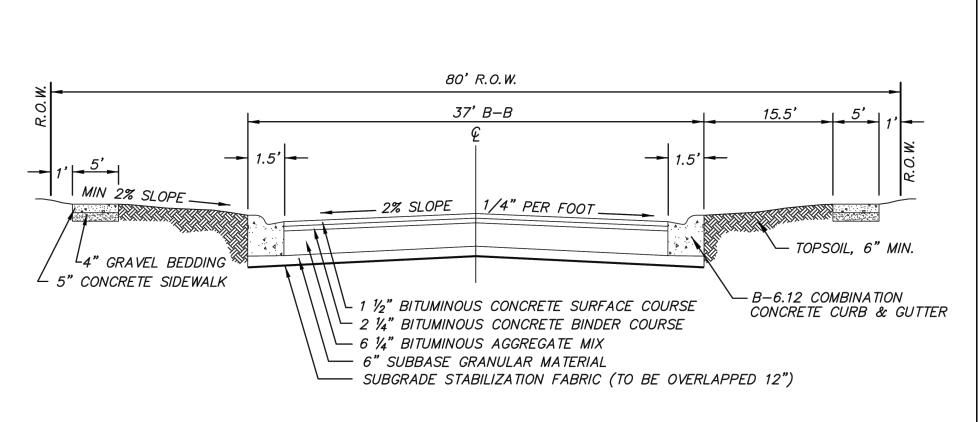

DETAIL - FREEMAN ROAD ASPHALT PAVEMENT

NOTE: PRIOR TO PLACEMENT OF STABILIZATION FABRIC, SUBGRADE IS TO BE PROOFROLLED WITH THE VILLAGE ENGINEER PRESENT. PAVEMENT MARKINGS TO BE 3M™ STAMARK™ TAPE CHECK WITH THE VILLAGE ENGINEER FOR CURREN MIX DESIGNS.

| PES. SCALE NONE NO. REVISIONS BY DATE DATE 5-25-05 1. MISC UPDATES SW 2/10 DRAFTER SLW VILLAGE OF HOFFMAN ESTATES FILE NAME: SHEET NO. TRANSPORTATION & ENGINEERING DIVISION ROAD80.DWG 1 OF 1 | | CROSS SECTION FOR ≥ 80 FOOT ROW | | | | | | | | |
|---|------------|------------------------------------|---------|---------------------|--------------|----|------|--|--|--|
| DRAFTER SLW SHEET NO. | | SCALE | NONE | NO. | REVISIONS | BY | DATE | | | |
| VILLAGE OF HOFFMAN ESTATES FILE NAME: SHEET NO. | I T | DATE | 5-25-05 | 1. | MISC UPDATES | SW | 2/10 | | | |
| 77227102 07 770771117117 20 77720 | | DRAFTER | SLW | | | | | | | |
| | | | | SHEET NO. 1 OF 1 | | | | | | |

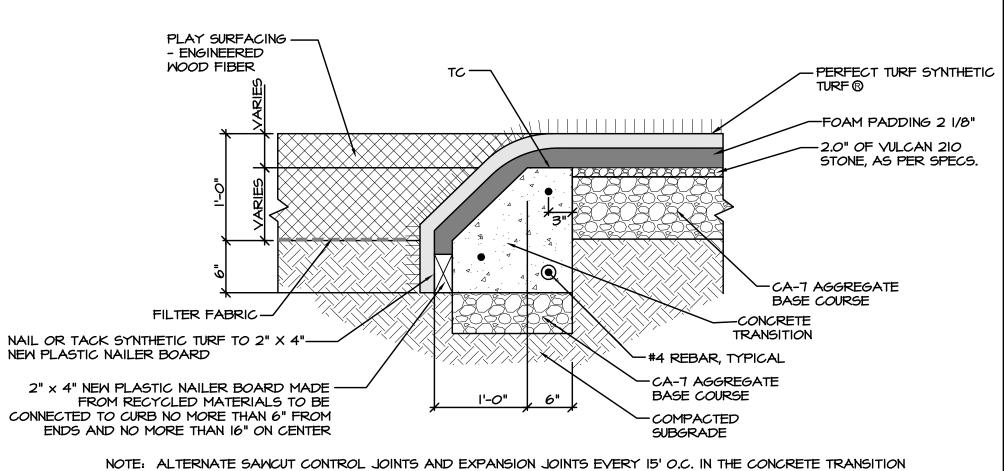

DETAIL - PLAYGROUND TRANSITION CURB

NOT TO SCALE

MWRD MWRD /ILLAGE 11/25/19 SWCD FOR BID DRAWN: PS 1911354C


VILLAGE


8/23/19

NITY PARI I 2019

OUT ENF

C-4.7 SITE DEVELOPMENT **DETAILS**

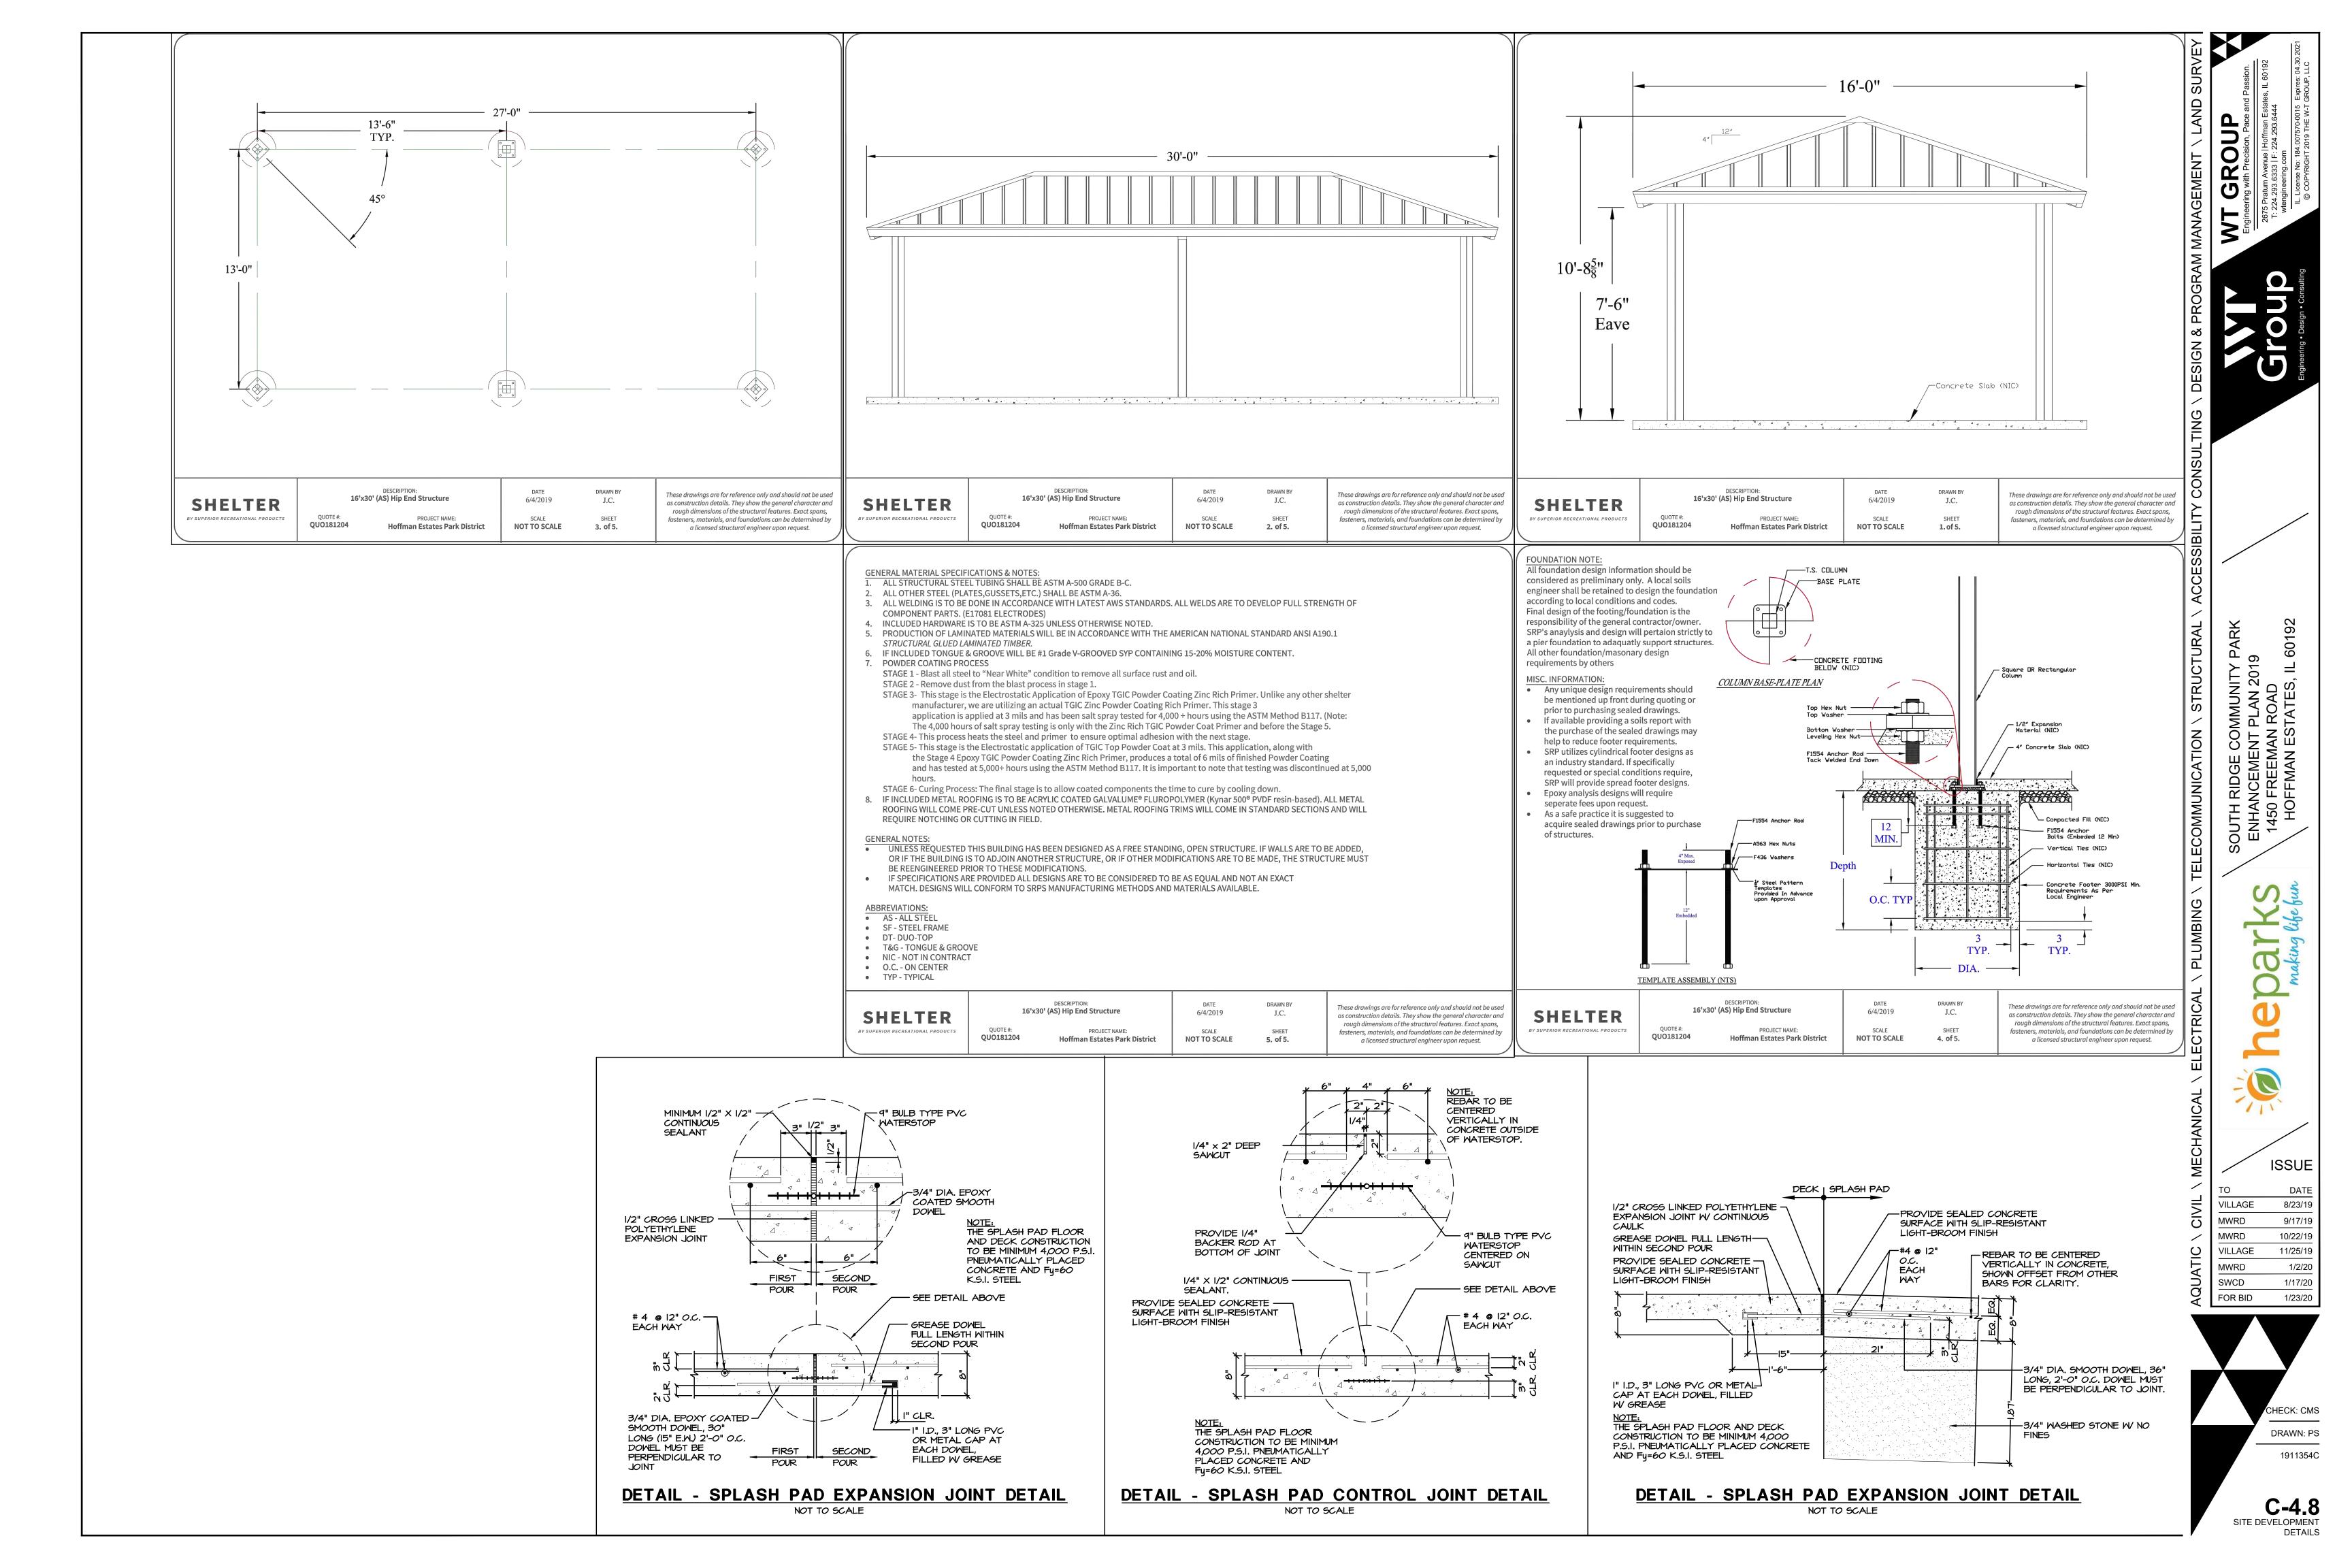

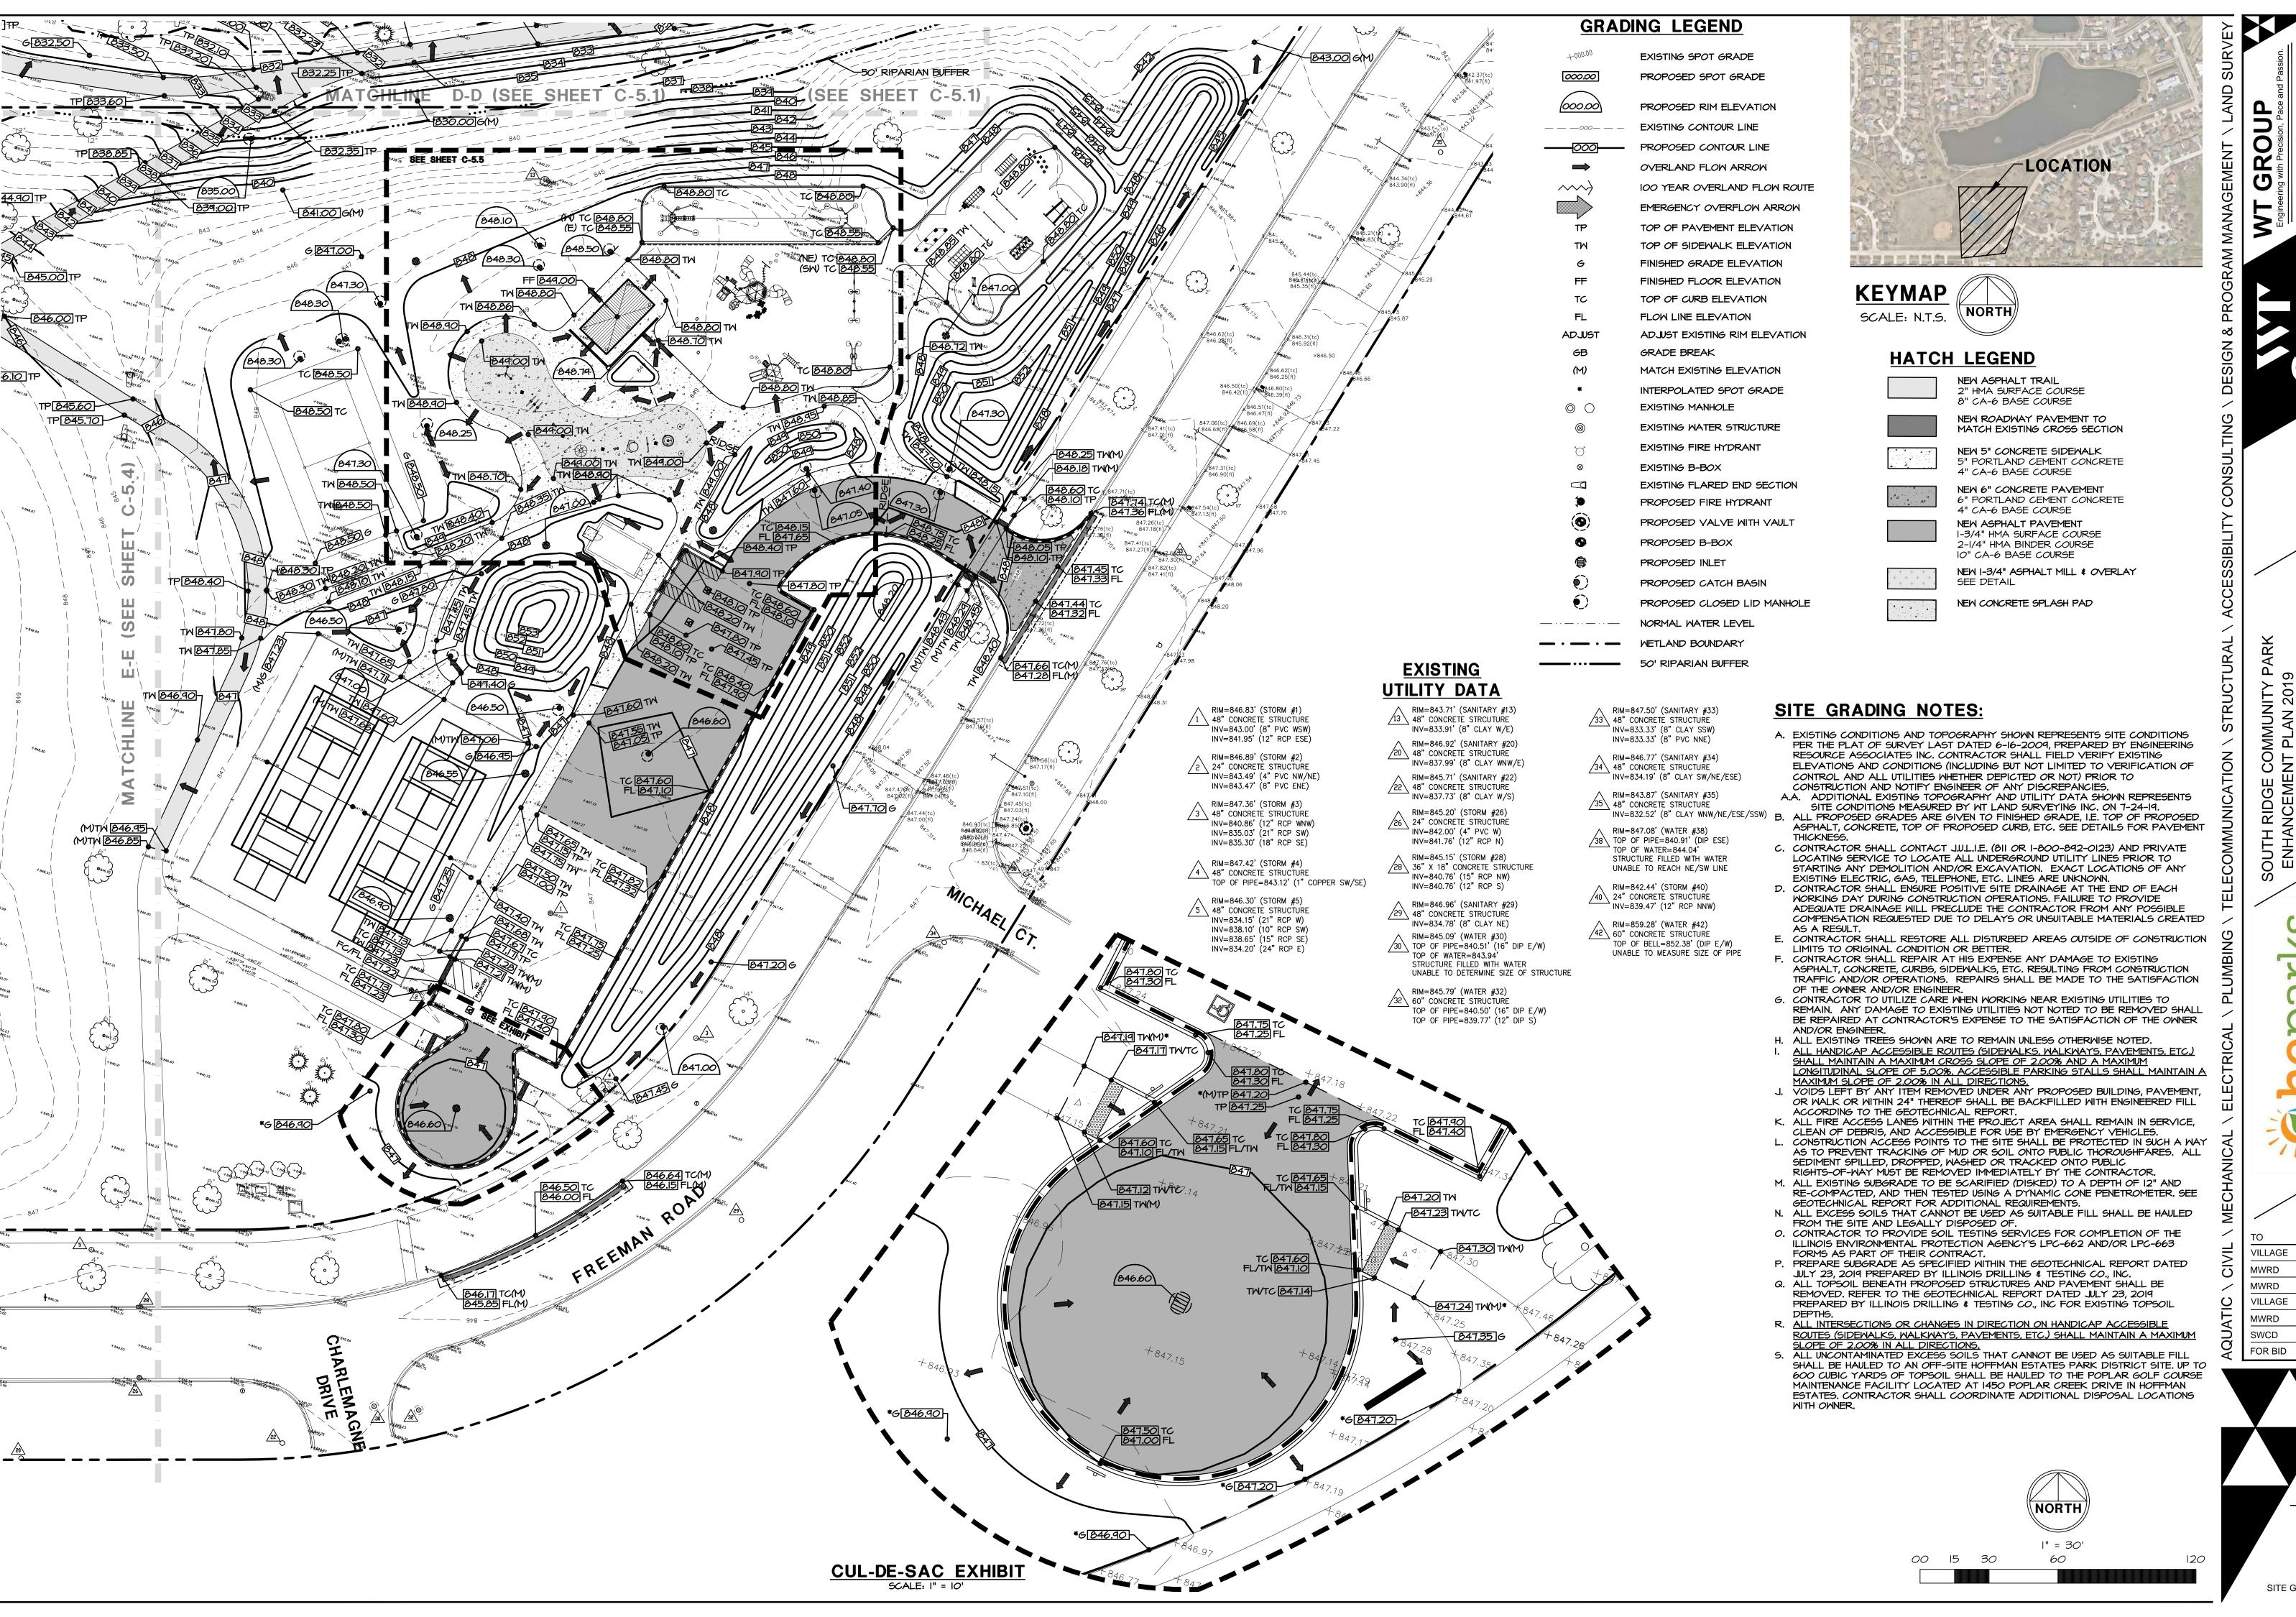

HECK: CMS DRAWN: PS 1911354C

8/23/19

9/17/19

10/22/19

11/25/19


1/2/20

1/23/20

C-5.0

SITE GRADING PLAN

EN 44

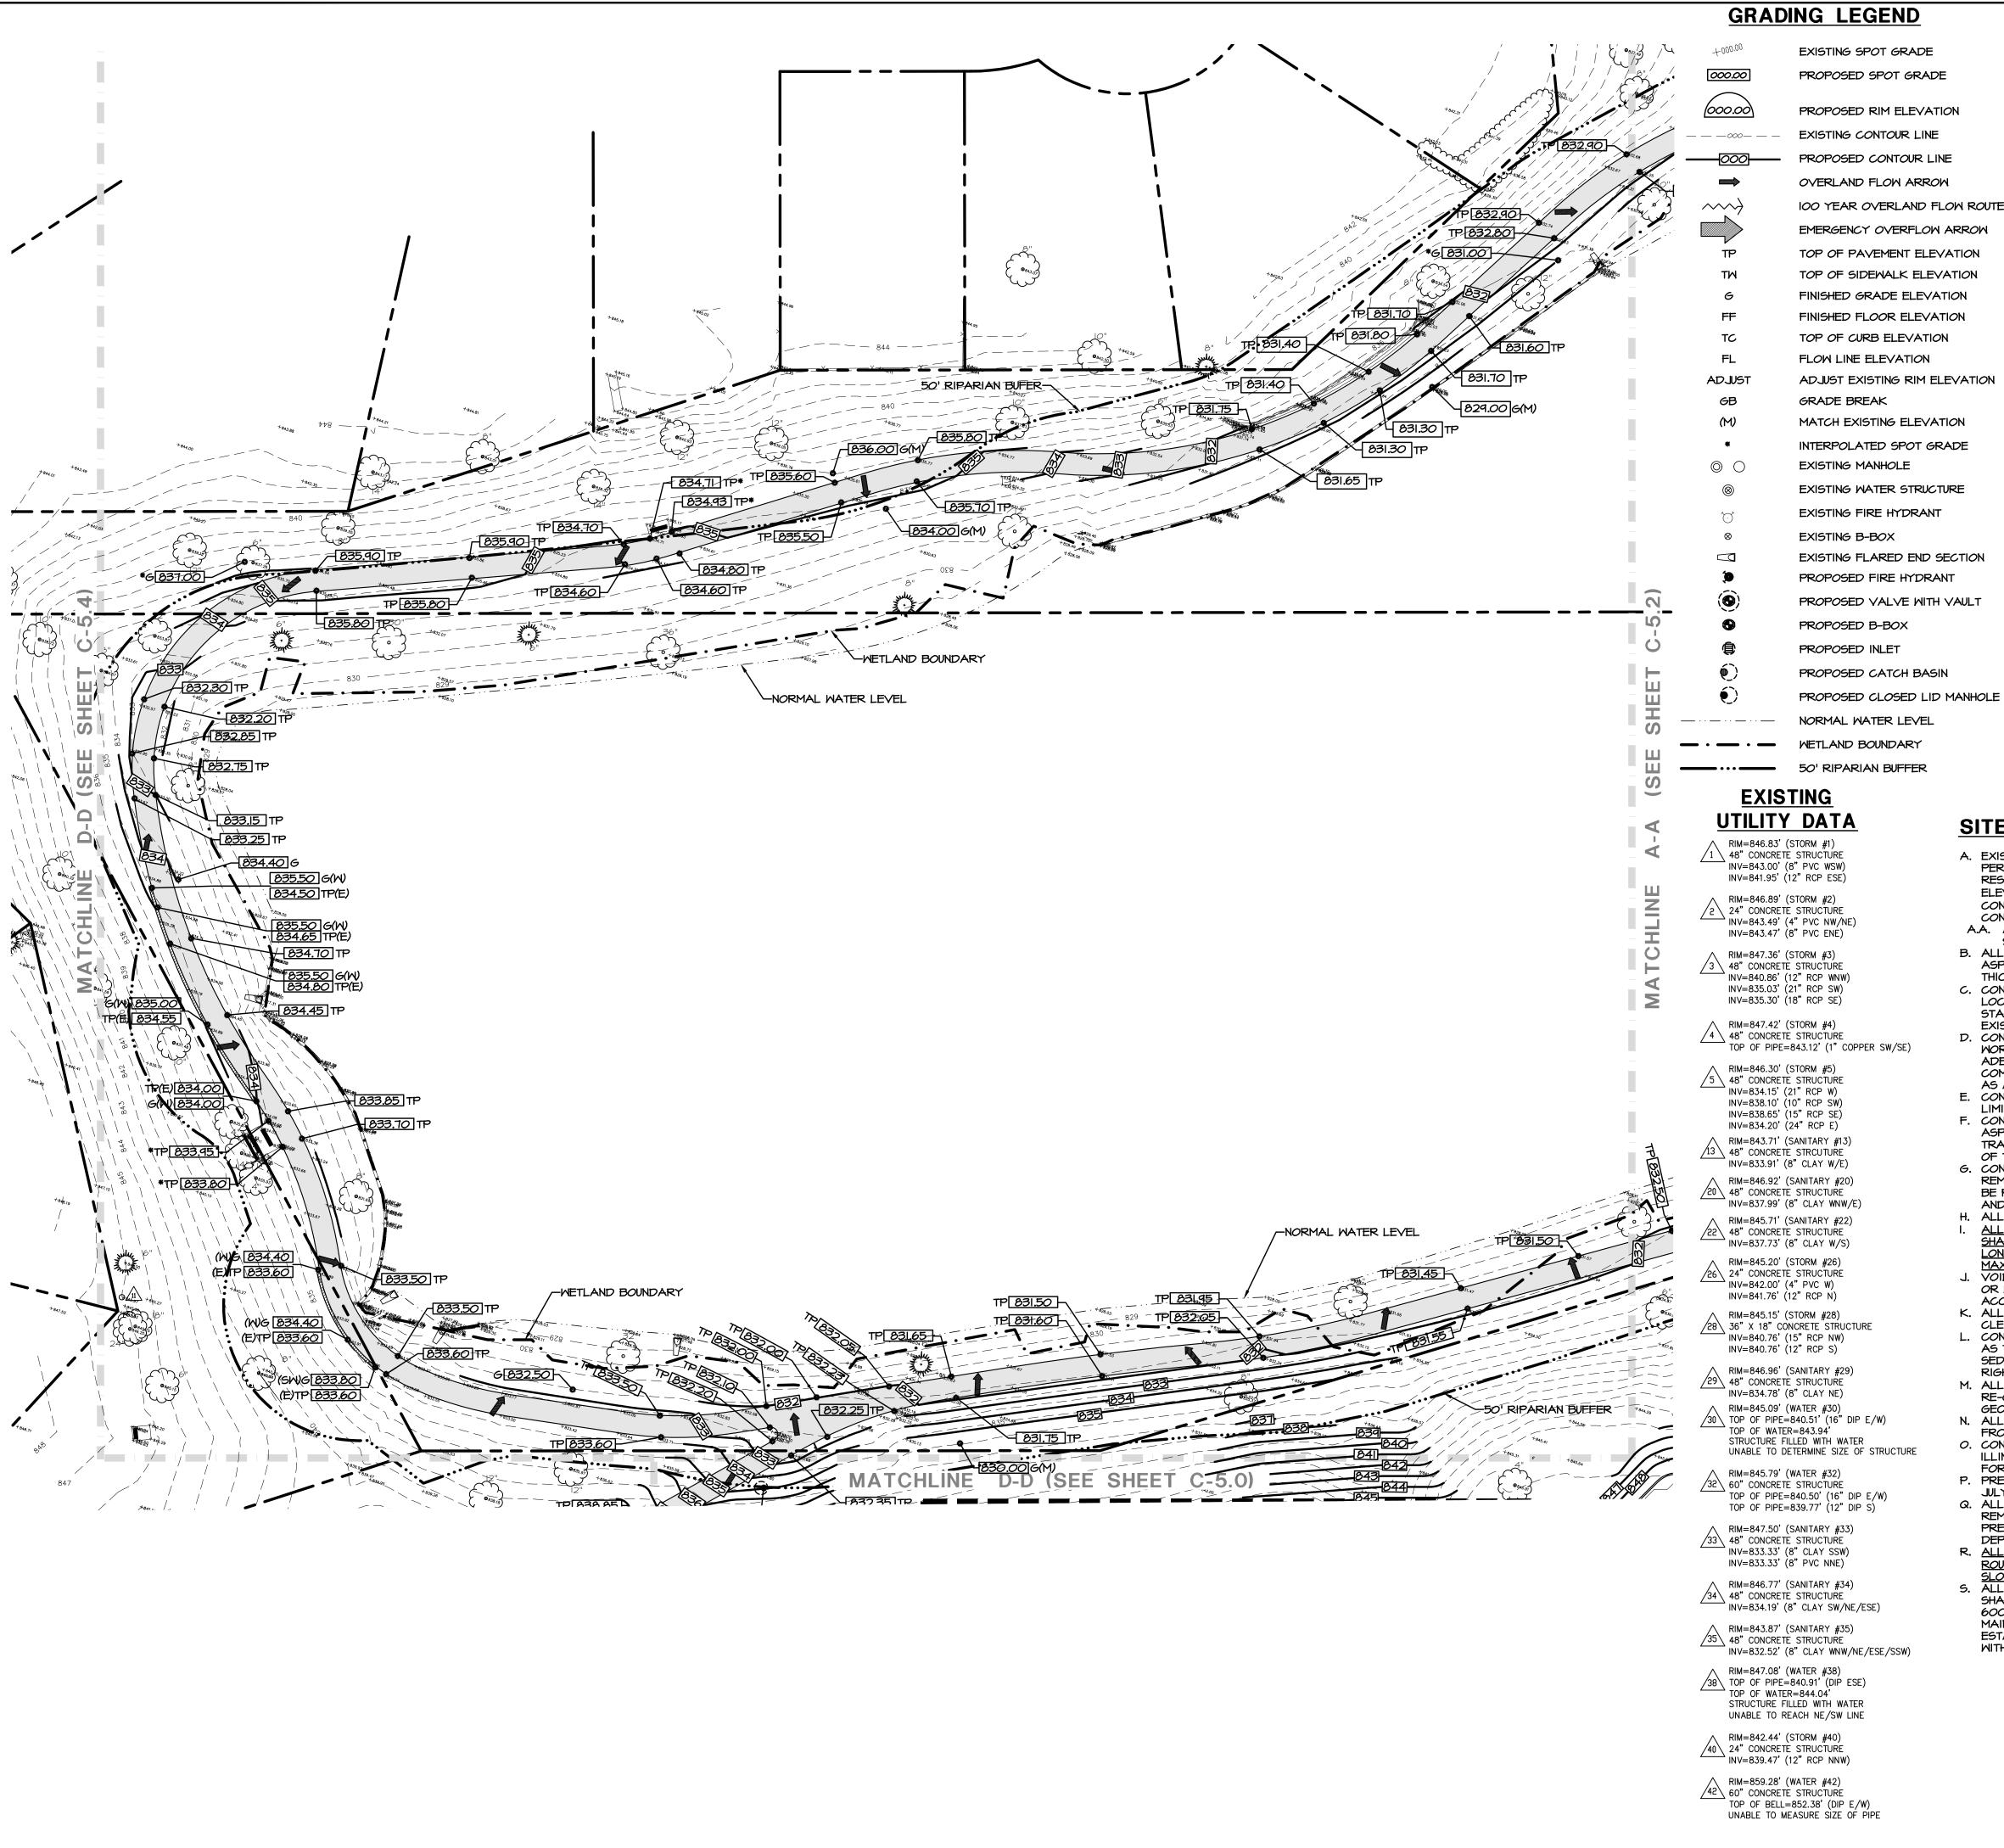

GRADING LEGEND

EXISTING SPOT GRADE PROPOSED SPOT GRADE PROPOSED RIM ELEVATION EXISTING CONTOUR LINE PROPOSED CONTOUR LINE OVERLAND FLOW ARROW 100 YEAR OVERLAND FLOW ROUTE EMERGENCY OVERFLOW ARROW TOP OF PAVEMENT ELEVATION TOP OF SIDEWALK ELEVATION FINISHED GRADE ELEVATION FINISHED FLOOR ELEVATION TOP OF CURB ELEVATION FLOW LINE ELEVATION ADJUST EXISTING RIM ELEVATION GRADE BREAK MATCH EXISTING ELEVATION

INTERPOLATED SPOT GRADE EXISTING MANHOLE EXISTING WATER STRUCTURE

> EXISTING FIRE HYDRANT EXISTING B-BOX EXISTING FLARED END SECTION PROPOSED FIRE HYDRANT

PROPOSED B-BOX PROPOSED INLET PROPOSED CATCH BASIN

NORMAL WATER LEVEL

LOCATION



HATCH LEGEND

2" HMA SURFACE COURSE 8" CA-6 BASE COURSE NEW ROADWAY PAVEMENT TO MATCH EXISTING CROSS SECTION

NEW ASPHALT TRAIL

NEW 5" CONCRETE SIDEWALK 5" PORTLAND CEMENT CONCRETE 4" CA-6 BASE COURSE NEW 6" CONCRETE PAYEMENT

6" PORTLAND CEMENT CONCRETE 4" CA-6 BASE COURSE NEW ASPHALT PAVEMENT 1-3/4" HMA SURFACE COURSE 2-1/4" HMA BINDER COURSE 10" CA-6 BASE COURSE

NEW I-3/4" ASPHALT MILL & OVERLAY SEE DETAIL

NEW CONCRETE SPLASH PAD

1 \ 48" CONCRETE STRUCTURE INV=843.00' (8" PVC WSW)

INV=843.49' (4" PVC NW/NE) INV=843.47' (8" PVC ENE)

5 \ 48" CONCRETE STRUCTURE INV=838.10' (10" RCP SW) INV=838.65' (15" RCP SE)

RIM=846.92' (SANITARY #20)

INV=837.99' (8" CLAY WNW/E) RIM=845.71' (SANITARY #22)

INV=840.76' (15" RCP NW) INV=840.76' (12" RCP S) RIM=846.96' (SANITARY #29)

INV=834.78' (8" CLAY NE) RIM=845.09' (WATER #30) TOP OF PIPE=840.51' (16" DIP E/W) STRUCTURE FILLED WITH WATER UNABLE TO DETERMINE SIZE OF STRUCTURE

TOP OF PIPE=840.50' (16" DIP E/W) TOP OF PIPE=839.77' (12" DIP S)

INV=833.33' (8" CLAY SSW) INV=833.33' (8" PVC NNE)

'INV=834.19' (8" CLAY SW/NE/ESE)

38 TOP OF PIPE=840.91' (DIP ESE) STRUCTURE FILLED WITH WATER

TOP OF BELL=852.38' (DIP E/W) UNABLE TO MEASURE SIZE OF PIPE

SITE GRADING NOTES:

- A. EXISTING CONDITIONS AND TOPOGRAPHY SHOWN REPRESENTS SITE CONDITIONS PER THE PLAT OF SURVEY LAST DATED 6-16-2009, PREPARED BY ENGINEERING RESOURCE ASSOCIATES INC. CONTRACTOR SHALL FIELD VERIFY EXISTING ELEVATIONS AND CONDITIONS (INCLUDING BUT NOT LIMITED TO VERIFICATION OF CONTROL AND ALL UTILITIES WHETHER DEPICTED OR NOT) PRIOR TO CONSTRUCTION AND NOTIFY ENGINEER OF ANY DISCREPANCIES.
- A.A. ADDITIONAL EXISTING TOPOGRAPHY AND UTILITY DATA SHOWN REPRESENTS SITE CONDITIONS MEASURED BY WT LAND SURVEYING INC. ON 7-24-19. B. ALL PROPOSED GRADES ARE GIVEN TO FINISHED GRADE, I.E. TOP OF PROPOSED ASPHALT, CONCRETE, TOP OF PROPOSED CURB, ETC. SEE DETAILS FOR PAVEMENT
- C. CONTRACTOR SHALL CONTACT J.J.L.I.E. (811 OR 1-800-892-0123) AND PRIVATE LOCATING SERVICE TO LOCATE ALL UNDERGROUND UTILITY LINES PRIOR TO STARTING ANY DEMOLITION AND/OR EXCAVATION. EXACT LOCATIONS OF ANY EXISTING ELECTRIC, GAS, TELEPHONE, ETC. LINES ARE UNKNOWN. D. CONTRACTOR SHALL ENSURE POSITIVE SITE DRAINAGE AT THE END OF EACH WORKING DAY DURING CONSTRUCTION OPERATIONS. FAILURE TO PROVIDE
- ADEQUATE DRAINAGE WILL PRECLUDE THE CONTRACTOR FROM ANY POSSIBLE COMPENSATION REQUESTED DUE TO DELAYS OR UNSUITABLE MATERIALS CREATED
- E. CONTRACTOR SHALL RESTORE ALL DISTURBED AREAS OUTSIDE OF CONSTRUCTION LIMITS TO ORIGINAL CONDITION OR BETTER F. CONTRACTOR SHALL REPAIR AT HIS EXPENSE ANY DAMAGE TO EXISTING ASPHALT, CONCRETE, CURBS, SIDEWALKS, ETC. RESULTING FROM CONSTRUCTION
- TRAFFIC AND/OR OPERATIONS. REPAIRS SHALL BE MADE TO THE SATISFACTION OF THE OWNER AND/OR ENGINEER. G. CONTRACTOR TO UTILIZE CARE WHEN WORKING NEAR EXISTING UTILITIES TO REMAIN. ANY DAMAGE TO EXISTING UTILITIES NOT NOTED TO BE REMOVED SHALL
- BE REPAIRED AT CONTRACTOR'S EXPENSE TO THE SATISFACTION OF THE OWNER AND/OR ENGINEER. H. ALL EXISTING TREES SHOWN ARE TO REMAIN UNLESS OTHERWISE NOTED. ALL HANDICAP ACCESSIBLE ROUTES (SIDEWALKS, WALKWAYS, PAVEMENTS, ETC.)
- SHALL MAINTAIN A MAXIMUM CROSS SLOPE OF 2.00% AND A MAXIMUM LONGITUDINAL SLOPE OF 5.00%. ACCESSIBLE PARKING STALLS SHALL MAINTAIN A MAXIMUM SLOPE OF 2.00% IN ALL DIRECTIONS.

 J. VOIDS LEFT BY ANY ITEM REMOVED UNDER ANY PROPOSED BUILDING, PAVEMENT, OR WALK OR WITHIN 24" THEREOF SHALL BE BACKFILLED WITH ENGINEERED FILL
- ACCORDING TO THE GEOTECHNICAL REPORT. K. ALL FIRE ACCESS LANES WITHIN THE PROJECT AREA SHALL REMAIN IN SERVICE, CLEAN OF DEBRIS, AND ACCESSIBLE FOR USE BY EMERGENCY VEHICLES. L. CONSTRUCTION ACCESS POINTS TO THE SITE SHALL BE PROTECTED IN SUCH A WAY
- AS TO PREVENT TRACKING OF MUD OR SOIL ONTO PUBLIC THOROUGHFARES. ALL SEDIMENT SPILLED, DROPPED, WASHED OR TRACKED ONTO PUBLIC RIGHTS-OF-WAY MUST BE REMOVED IMMEDIATELY BY THE CONTRACTOR. M. ALL EXISTING SUBGRADE TO BE SCARIFIED (DISKED) TO A DEPTH OF 12" AND RE-COMPACTED, AND THEN TESTED USING A DYNAMIC CONE PENETROMETER. SEE
- N. ALL EXCESS SOILS THAT CANNOT BE USED AS SUITABLE FILL SHALL BE HAULED FROM THE SITE AND LEGALLY DISPOSED OF. O. CONTRACTOR TO PROVIDE SOIL TESTING SERVICES FOR COMPLETION OF THE

GEOTECHNICAL REPORT FOR ADDITIONAL REQUIREMENTS.

- ILLINOIS ENVIRONMENTAL PROTECTION AGENCY'S LPC-662 AND/OR LPC-663 FORMS AS PART OF THEIR CONTRACT. P. PREPARE SUBGRADE AS SPECIFIED WITHIN THE GEOTECHNICAL REPORT DATED
- JULY 23, 2019 PREPARED BY ILLINOIS DRILLING & TESTING CO., INC. Q. ALL TOPSOIL BENEATH PROPOSED STRUCTURES AND PAVEMENT SHALL BE REMOVED. REFER TO THE GEOTECHNICAL REPORT DATED JULY 23, 2019 PREPARED BY ILLINOIS DRILLING & TESTING CO., INC FOR EXISTING TOPSOIL
- R. <u>ALL INTERSECTIONS OR CHANGES IN DIRECTION ON HANDICAP ACCESSIBLE</u> ROUTES (SIDEWALKS, WALKWAYS, PAVEMENTS, ETC.) SHALL MAINTAIN A MAXIMUM
- <u>SLOPE OF 2.00% IN ALL DIRECTIONS.</u>
 S. ALL UNCONTAMINATED EXCESS SOILS THAT CANNOT BE USED AS SUITABLE FILL SHALL BE HAULED TO AN OFF-SITE HOFFMAN ESTATES PARK DISTRICT SITE. UP TO 600 CUBIC YARDS OF TOPSOIL SHALL BE HAULED TO THE POPLAR GOLF COURSE MAINTENANCE FACILITY LOCATED AT 1450 POPLAR CREEK DRIVE IN HOFFMAN ESTATES. CONTRACTOR SHALL COORDINATE ADDITIONAL DISPOSAL LOCATIONS WITH OWNER.



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HECK: CMS DRAWN: PS 1911354C

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VILLAGE

MWRD

MWRD

MWRD

SWCD

FOR BID

VILLAGE

8/23/19

9/17/19


10/22/19

11/25/19

1/23/20

TOO 44

C-5.1 SITE GRADING PLAN

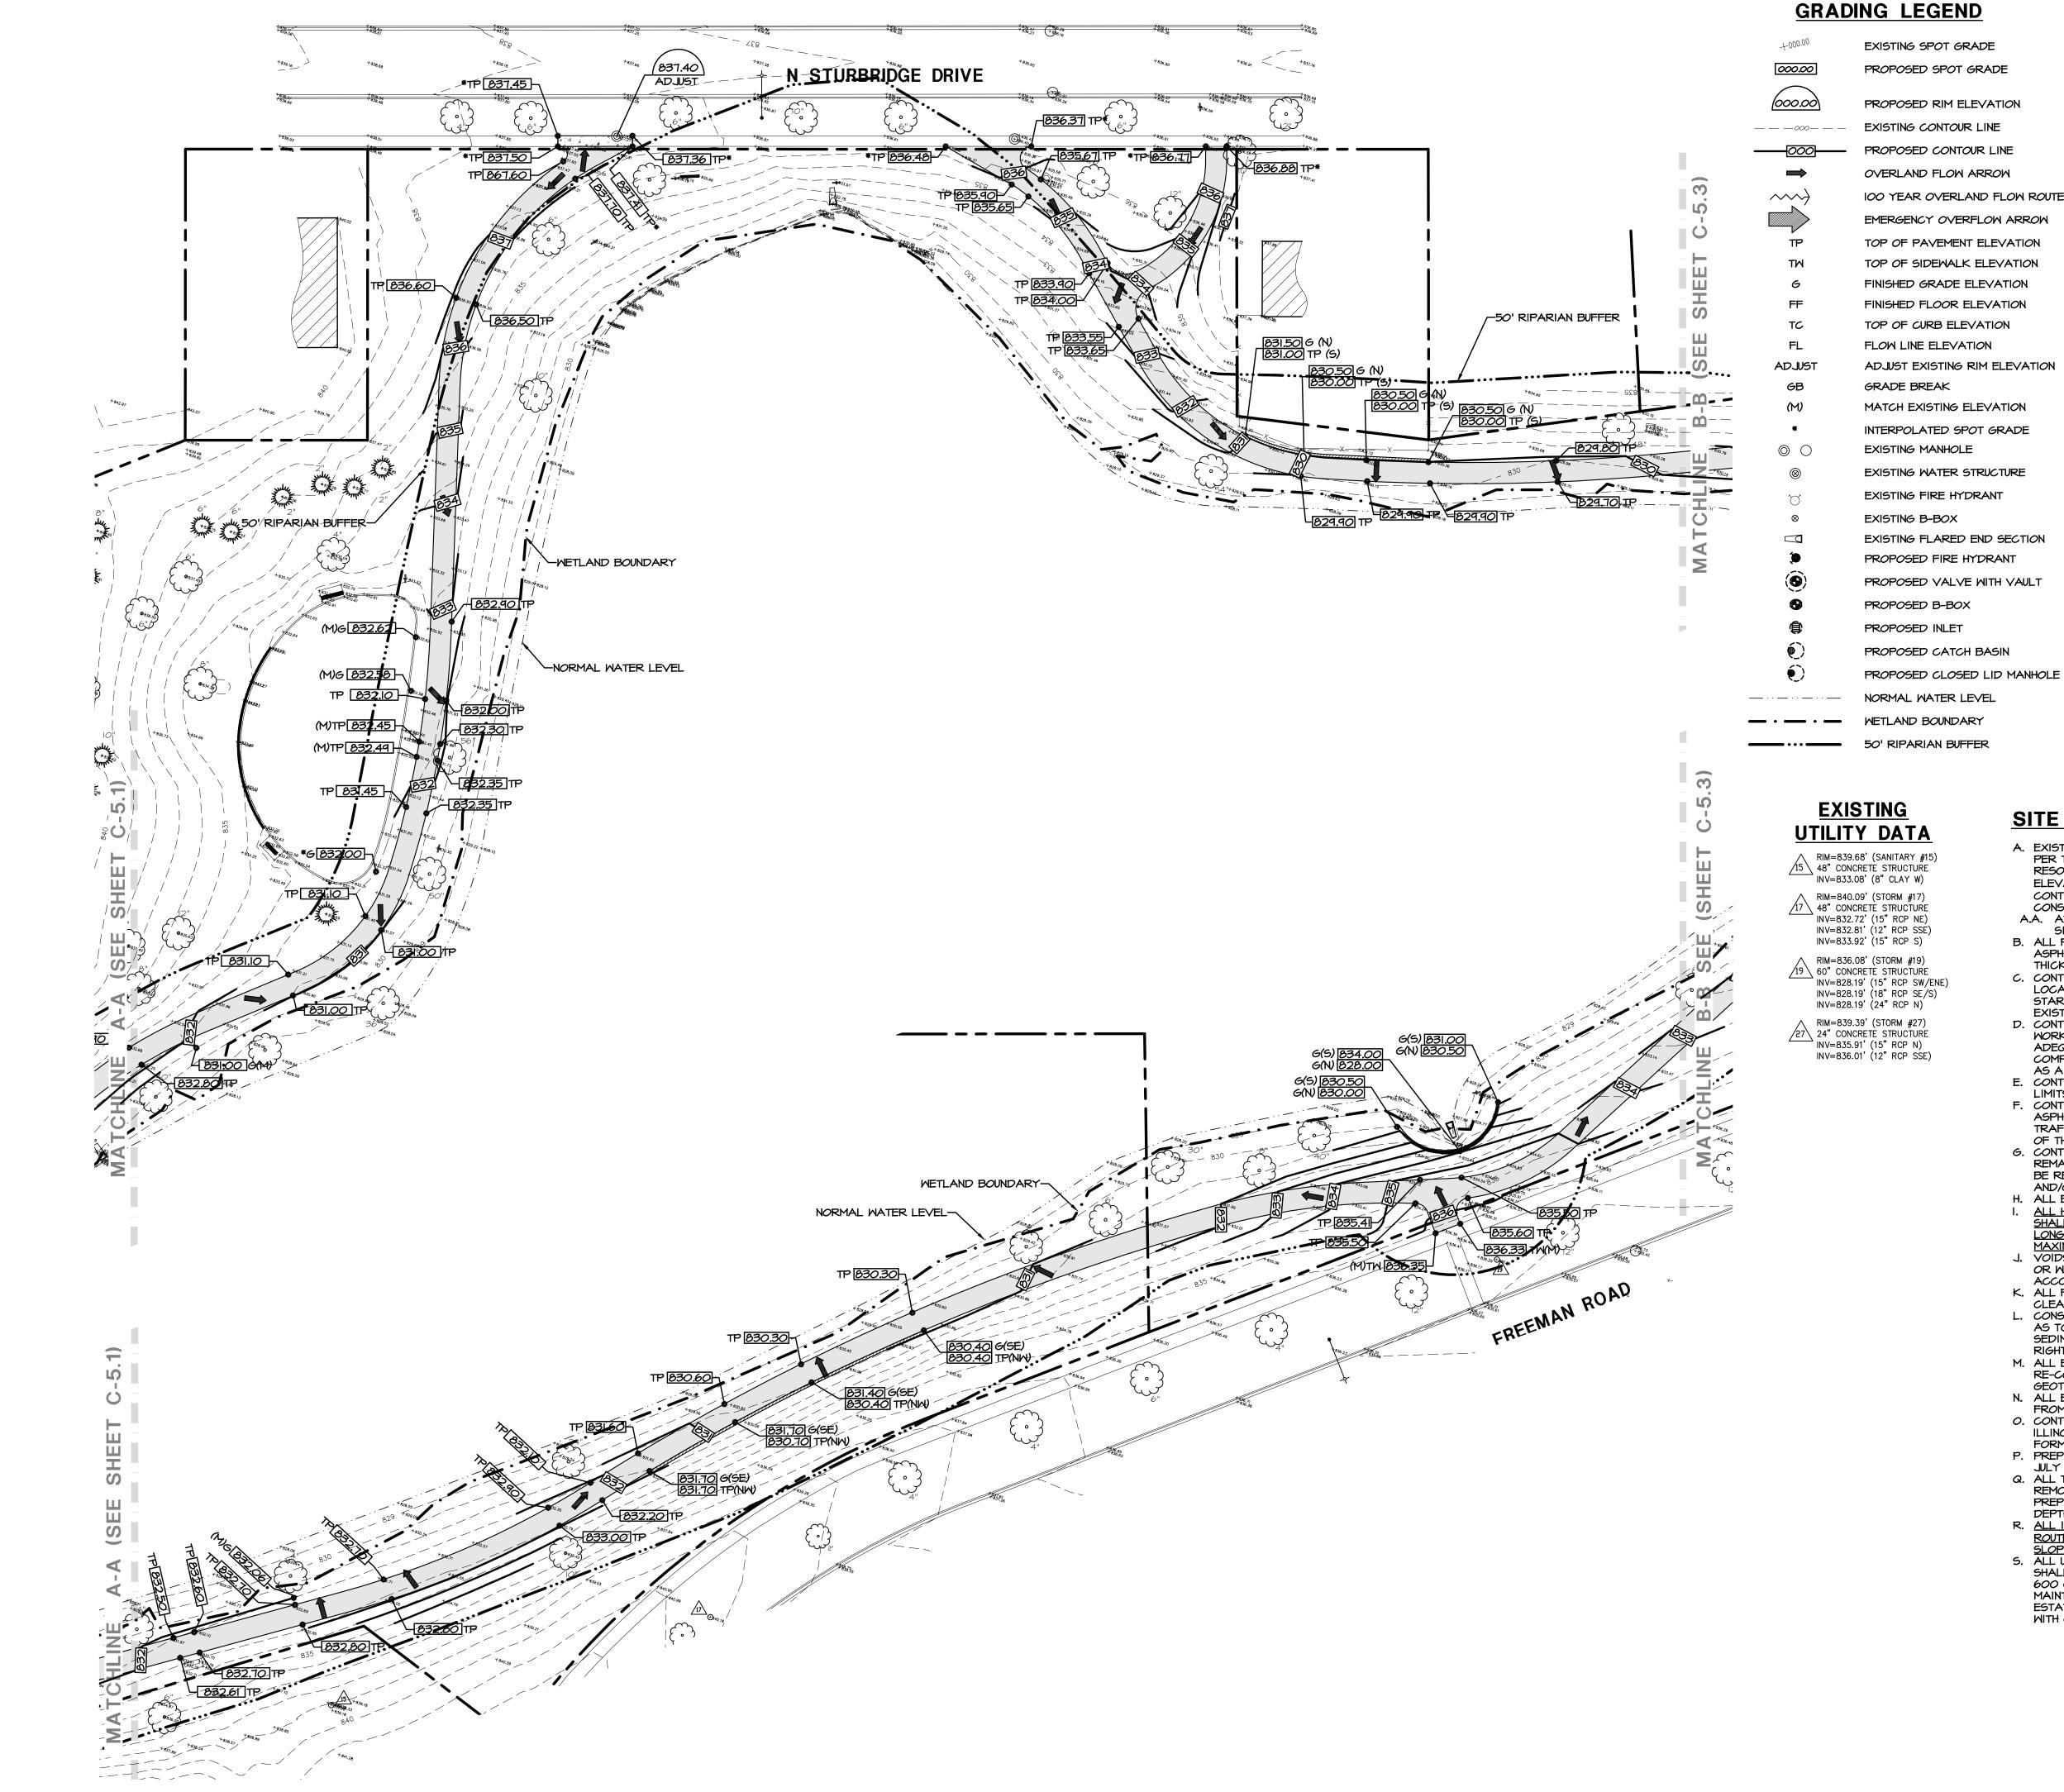

PROPOSED RIM ELEVATION 100 YEAR OVERLAND FLOW ROUTE EMERGENCY OVERFLOW ARROW

TOP OF PAVEMENT ELEVATION TOP OF SIDEWALK ELEVATION FINISHED GRADE ELEVATION FINISHED FLOOR ELEVATION

ADJUST EXISTING RIM ELEVATION MATCH EXISTING ELEVATION

INTERPOLATED SPOT GRADE EXISTING WATER STRUCTURE

EXISTING FLARED END SECTION PROPOSED VALVE WITH VAULT

-LOCATION



HATCH LEGEND

NEW ASPHALT TRAIL 2" HMA SURFACE COURSE 8" CA-6 BASE COURSE NEW ROADWAY PAVEMENT TO MATCH EXISTING CROSS SECTION

NEW 5" CONCRETE SIDEWALK 5" PORTLAND CEMENT CONCRETE 4" CA-6 BASE COURSE NEW 6" CONCRETE PAYEMENT

6" PORTLAND CEMENT CONCRETE 4" CA-6 BASE COURSE NEW ASPHALT PAVEMENT 1-3/4" HMA SURFACE COURSE 2-1/4" HMA BINDER COURSE

10" CA-6 BASE COURSE

NEW I-3/4" ASPHALT MILL & OVERLAY SEE DETAIL

NEW CONCRETE SPLASH PAD

SITE GRADING NOTES:

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- ASPHALT, CONCRETE, TOP OF PROPOSED CURB, ETC. SEE DETAILS FOR PAVEMENT THICKNESS. C. CONTRACTOR SHALL CONTACT J.U.L.I.E. (811 OR 1-800-892-0123) AND PRIVATE LOCATING SERVICE TO LOCATE ALL UNDERGROUND UTILITY LINES PRIOR TO STARTING ANY DEMOLITION AND/OR EXCAVATION. EXACT LOCATIONS OF ANY
- EXISTING ELECTRIC, GAS, TELEPHONE, ETC. LINES ARE UNKNOWN. D. CONTRACTOR SHALL ENSURE POSITIVE SITE DRAINAGE AT THE END OF EACH WORKING DAY DURING CONSTRUCTION OPERATIONS. FAILURE TO PROVIDE ADEQUATE DRAINAGE WILL PRECLUDE THE CONTRACTOR FROM ANY POSSIBLE COMPENSATION REQUESTED DUE TO DELAYS OR UNSUITABLE MATERIALS CREATED
- AS A RESULT. E. CONTRACTOR SHALL RESTORE ALL DISTURBED AREAS OUTSIDE OF CONSTRUCTION LIMITS TO ORIGINAL CONDITION OR BETTER.
- F. CONTRACTOR SHALL REPAIR AT HIS EXPENSE ANY DAMAGE TO EXISTING ASPHALT, CONCRETE, CURBS, SIDEWALKS, ETC. RESULTING FROM CONSTRUCTION TRAFFIC AND/OR OPERATIONS. REPAIRS SHALL BE MADE TO THE SATISFACTION OF THE OWNER AND/OR ENGINEER.
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- H. ALL EXISTING TREES SHOWN ARE TO REMAIN UNLESS OTHERWISE NOTED. I. ALL HANDICAP ACCESSIBLE ROUTES (SIDEWALKS, WALKWAYS, PAVEMENTS, ETC.) SHALL MAINTAIN A MAXIMUM CROSS SLOPE OF 2.00% AND A MAXIMUM <u>LONGITUDINAL SLOPE OF 5.00%. ACCESSIBLE PARKING STALLS SHALL MAINTAIN A</u> MAXIMUM SLOPE OF 2.00% IN ALL DIRECTIONS.
- J. VOIDS LEFT BY ANY ITEM REMOVED UNDER ANY PROPOSED BUILDING, PAVEMENT, OR WALK OR WITHIN 24" THEREOF SHALL BE BACKFILLED WITH ENGINEERED FILL ACCORDING TO THE GEOTECHNICAL REPORT. K. ALL FIRE ACCESS LANES WITHIN THE PROJECT AREA SHALL REMAIN IN SERVICE,
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- M. ALL EXISTING SUBGRADE TO BE SCARIFIED (DISKED) TO A DEPTH OF 12" AND RE-COMPACTED, AND THEN TESTED USING A DYNAMIC CONE PENETROMETER. SEE GEOTECHNICAL REPORT FOR ADDITIONAL REQUIREMENTS.
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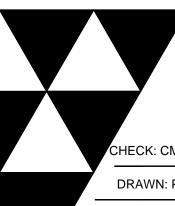
> C-5.2 SITE GRADING PLAN

EN 44




VILLAGE 8/23/19 9/17/19 10/22/19

MWRD MWRD 11/25/19 VILLAGE MWRD SWCD FOR BID 1/23/20



120

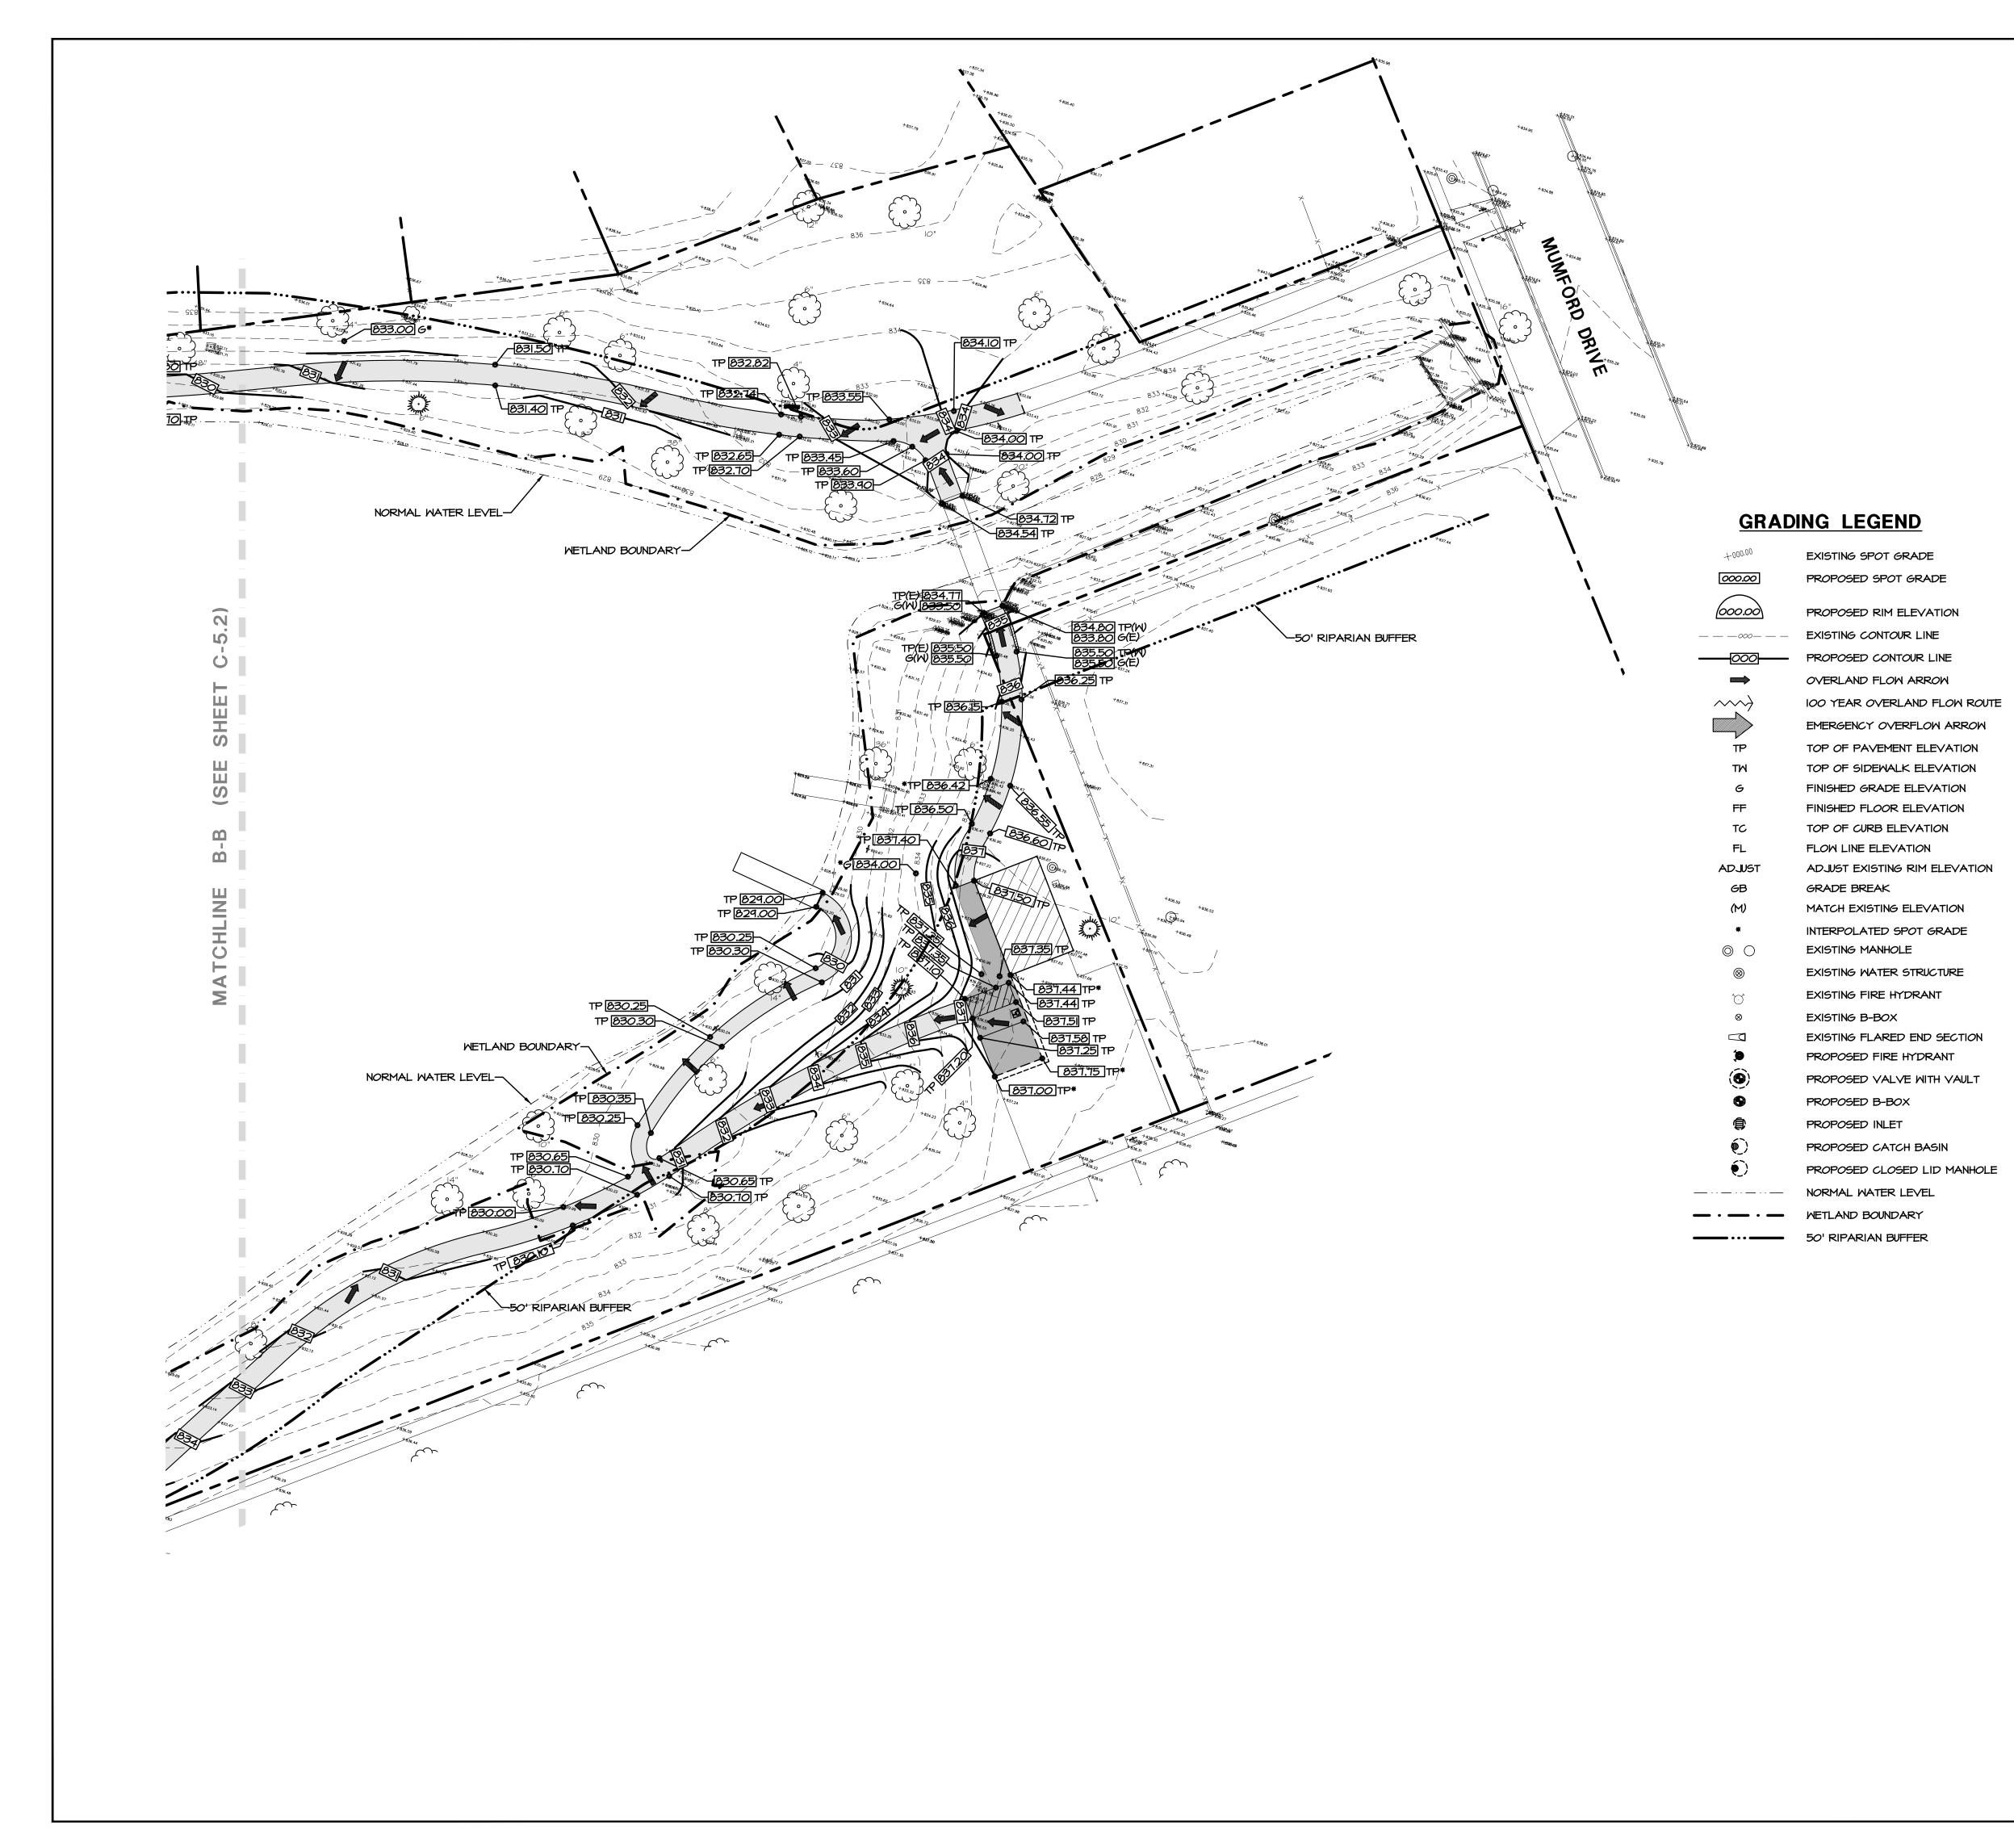





HATCH LEGEND

2" HMA SURFACE COURSE 8" CA-6 BASE COURSE NEW ROADWAY PAVEMENT TO MATCH EXISTING CROSS SECTION NEW 5" CONCRETE SIDEWALK 5" PORTLAND CEMENT CONCRETE 4" CA-6 BASE COURSE NEW 6" CONCRETE PAYEMENT

6" PORTLAND CEMENT CONCRETE

NEW ASPHALT TRAIL

4" CA-6 BASE COURSE NEW ASPHALT PAVEMENT 1-3/4" HMA SURFACE COURSE 2-1/4" HMA BINDER COURSE 10" CA-6 BASE COURSE

NEW I-3/4" ASPHALT MILL & OVERLAY SEE DETAIL

NEW CONCRETE SPLASH PAD

SITE GRADING NOTES:

- A. EXISTING CONDITIONS AND TOPOGRAPHY SHOWN REPRESENTS SITE CONDITIONS PER THE PLAT OF SURVEY LAST DATED 6-16-2009, PREPARED BY ENGINEERING RESOURCE ASSOCIATES INC. CONTRACTOR SHALL FIELD VERIFY EXISTING ELEVATIONS AND CONDITIONS (INCLUDING BUT NOT LIMITED TO VERIFICATION OF CONTROL AND ALL UTILITIES WHETHER DEPICTED OR NOT) PRIOR TO CONSTRUCTION AND NOTIFY ENGINEER OF ANY DISCREPANCIES.
- A.A. ADDITIONAL EXISTING TOPOGRAPHY AND UTILITY DATA SHOWN REPRESENTS SITE CONDITIONS MEASURED BY WT LAND SURVEYING INC. ON 7-24-19.
- B. ALL PROPOSED GRADES ARE GIVEN TO FINISHED GRADE, I.E. TOP OF PROPOSED ASPHALT, CONCRETE, TOP OF PROPOSED CURB, ETC. SEE DETAILS FOR PAVEMENT THICKNESS. C. CONTRACTOR SHALL CONTACT J.U.L.I.E. (811 OR 1-800-892-0123) AND PRIVATE
- LOCATING SERVICE TO LOCATE ALL UNDERGROUND UTILITY LINES PRIOR TO STARTING ANY DEMOLITION AND/OR EXCAVATION. EXACT LOCATIONS OF ANY EXISTING ELECTRIC, GAS, TELEPHONE, ETC. LINES ARE UNKNOWN. D. CONTRACTOR SHALL ENSURE POSITIVE SITE DRAINAGE AT THE END OF EACH
- WORKING DAY DURING CONSTRUCTION OPERATIONS. FAILURE TO PROVIDE ADEQUATE DRAINAGE WILL PRECLUDE THE CONTRACTOR FROM ANY POSSIBLE COMPENSATION REQUESTED DUE TO DELAYS OR UNSUITABLE MATERIALS CREATED
- AS A RESULT.
- E. CONTRACTOR SHALL RESTORE ALL DISTURBED AREAS OUTSIDE OF CONSTRUCTION LIMITS TO ORIGINAL CONDITION OR BETTER. F. CONTRACTOR SHALL REPAIR AT HIS EXPENSE ANY DAMAGE TO EXISTING
- ASPHALT, CONCRETE, CURBS, SIDEWALKS, ETC. RESULTING FROM CONSTRUCTION TRAFFIC AND/OR OPERATIONS. REPAIRS SHALL BE MADE TO THE SATISFACTION OF THE OWNER AND/OR ENGINEER. G. CONTRACTOR TO UTILIZE CARE WHEN WORKING NEAR EXISTING UTILITIES TO
- REMAIN. ANY DAMAGE TO EXISTING UTILITIES NOT NOTED TO BE REMOVED SHALL BE REPAIRED AT CONTRACTOR'S EXPENSE TO THE SATISFACTION OF THE OWNER AND/OR ENGINEER.
- H. ALL EXISTING TREES SHOWN ARE TO REMAIN UNLESS OTHERWISE NOTED. ALL HANDICAP ACCESSIBLE ROUTES (SIDEWALKS, WALKWAYS, PAVEMENTS, ETC.)
- SHALL MAINTAIN A MAXIMUM CROSS SLOPE OF 2.00% AND A MAXIMUM LONGITUDINAL SLOPE OF 5.00%. ACCESSIBLE PARKING STALLS SHALL MAINTAIN A MAXIMUM SLOPE OF 2.00% IN ALL DIRECTIONS.

 J. VOIDS LEFT BY ANY ITEM REMOVED UNDER ANY PROPOSED BUILDING, PAVEMENT,
- OR WALK OR WITHIN 24" THEREOF SHALL BE BACKFILLED WITH ENGINEERED FILL ACCORDING TO THE GEOTECHNICAL REPORT. K. ALL FIRE ACCESS LANES WITHIN THE PROJECT AREA SHALL REMAIN IN SERVICE,
- CLEAN OF DEBRIS, AND ACCESSIBLE FOR USE BY EMERGENCY VEHICLES. L. CONSTRUCTION ACCESS POINTS TO THE SITE SHALL BE PROTECTED IN SUCH A WAY AS TO PREVENT TRACKING OF MUD OR SOIL ONTO PUBLIC THOROUGHFARES. ALL
- SEDIMENT SPILLED, DROPPED, WASHED OR TRACKED ONTO PUBLIC RIGHTS-OF-WAY MUST BE REMOVED IMMEDIATELY BY THE CONTRACTOR. M. ALL EXISTING SUBGRADE TO BE SCARIFIED (DISKED) TO A DEPTH OF 12" AND RE-COMPACTED, AND THEN TESTED USING A DYNAMIC CONE PENETROMETER. SEE
- GEOTECHNICAL REPORT FOR ADDITIONAL REQUIREMENTS. N. ALL EXCESS SOILS THAT CANNOT BE USED AS SUITABLE FILL SHALL BE HAULED FROM THE SITE AND LEGALLY DISPOSED OF. O. CONTRACTOR TO PROVIDE SOIL TESTING SERVICES FOR COMPLETION OF THE
- ILLINOIS ENVIRONMENTAL PROTECTION AGENCY'S LPC-662 AND/OR LPC-663 FORMS AS PART OF THEIR CONTRACT. P. PREPARE SUBGRADE AS SPECIFIED WITHIN THE GEOTECHNICAL REPORT DATED
- JULY 23, 2019 PREPARED BY ILLINOIS DRILLING & TESTING CO., INC. Q. ALL TOPSOIL BENEATH PROPOSED STRUCTURES AND PAVEMENT SHALL BE REMOVED. REFER TO THE GEOTECHNICAL REPORT DATED JULY 23, 2019
- PREPARED BY ILLINOIS DRILLING & TESTING CO., INC FOR EXISTING TOPSOIL R. <u>ALL INTERSECTIONS OR CHANGES IN DIRECTION ON HANDICAP ACCESSIBLE</u> ROUTES (SIDEWALKS, WALKWAYS, PAVEMENTS, ETC.) SHALL MAINTAIN A MAXIMUM SLOPE OF 2.00% IN ALL DIRECTIONS.
- S. ALL UNCONTAMINATED EXCESS SOILS THAT CANNOT BE USED AS SUITABLE FILL SHALL BE HAULED TO AN OFF-SITE HOFFMAN ESTATES PARK DISTRICT SITE. UP TO 600 CUBIC YARDS OF TOPSOIL SHALL BE HAULED TO THE POPLAR GOLF COURSE MAINTENANCE FACILITY LOCATED AT 1450 POPLAR CREEK DRIVE IN HOFFMAN ESTATES. CONTRACTOR SHALL COORDINATE ADDITIONAL DISPOSAL LOCATIONS WITH OWNER.



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HECK: CMS DRAWN: PS 1911354C

VILLAGE

MWRD

MWRD

MWRD

SWCD FOR BID

120

VILLAGE

8/23/19

9/17/19


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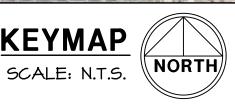
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EN 44

C-5.3 SITE GRADING PLAN






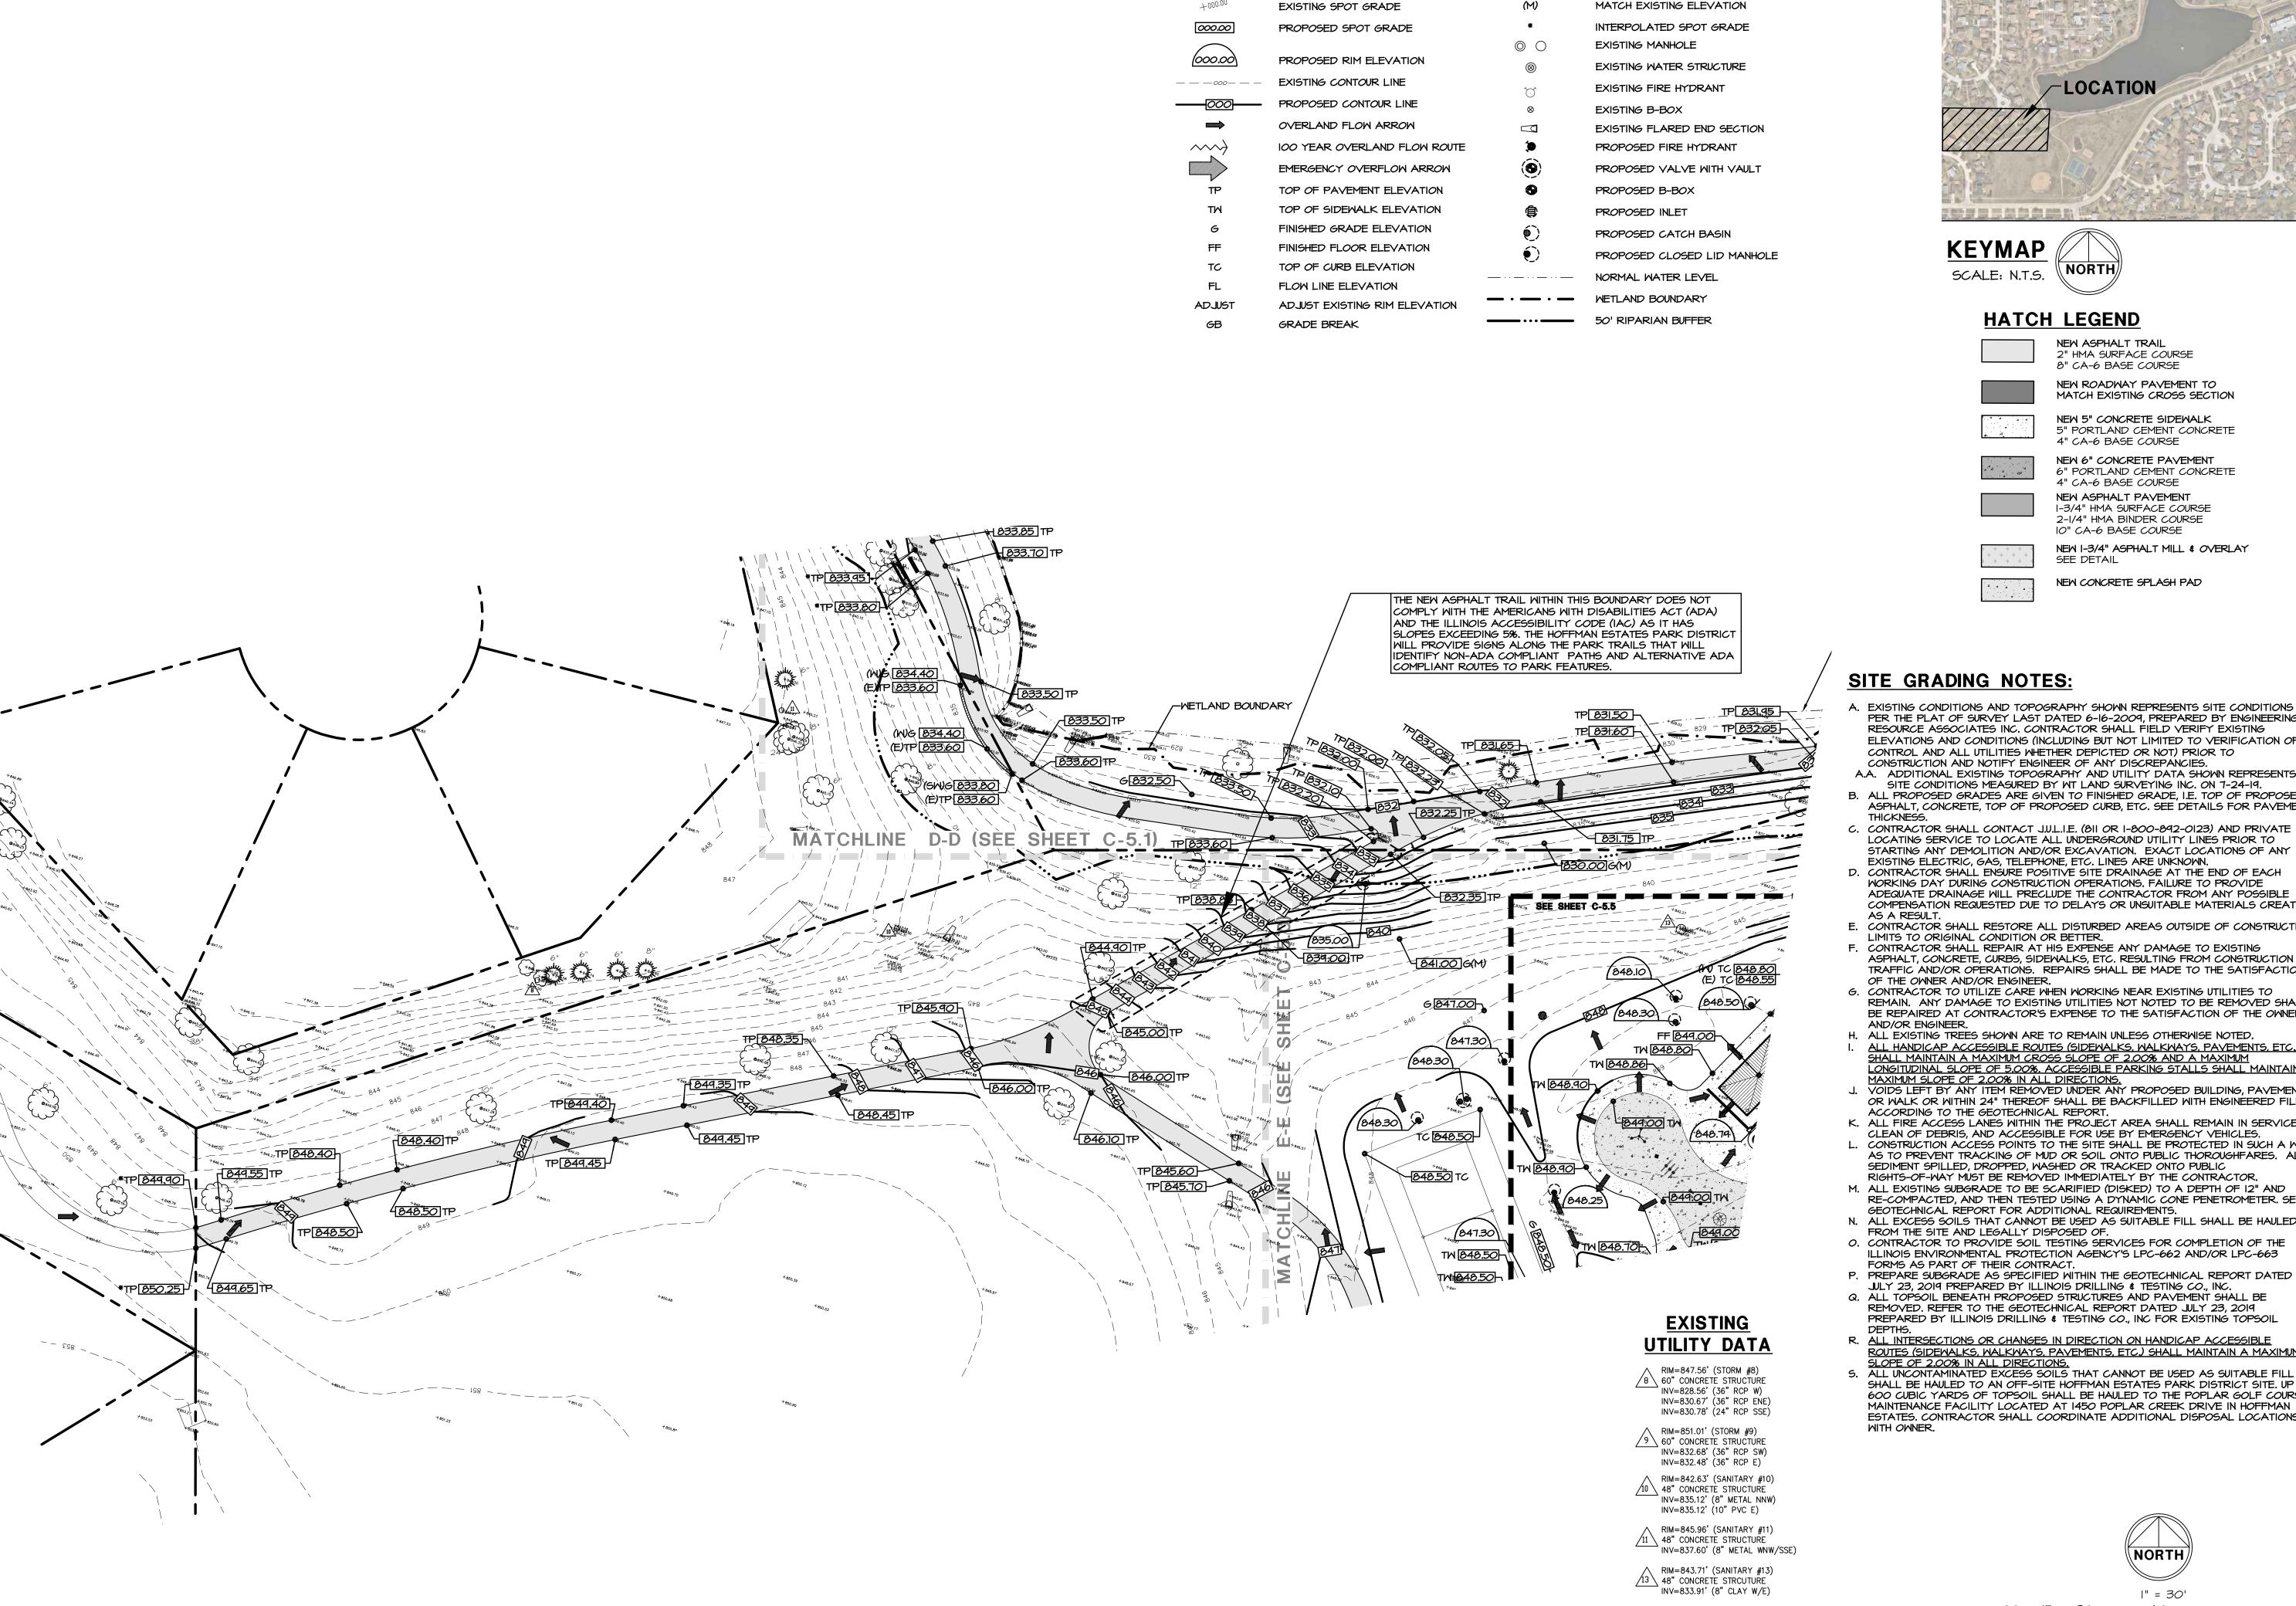

2" HMA SURFACE COURSE 8" CA-6 BASE COURSE NEW ROADWAY PAVEMENT TO MATCH EXISTING CROSS SECTION





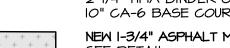




GRADING LEGEND

- EXISTING CONDITIONS AND TOPOGRAPHY SHOWN REPRESENTS SITE CONDITIONS PER THE PLAT OF SURVEY LAST DATED 6-16-2009, PREPARED BY ENGINEERING RESOURCE ASSOCIATES INC. CONTRACTOR SHALL FIELD VERIFY EXISTING ELEVATIONS AND CONDITIONS (INCLUDING BUT NOT LIMITED TO VERIFICATION OF CONTROL AND ALL UTILITIES WHETHER DEPICTED OR NOT) PRIOR TO CONSTRUCTION AND NOTIFY ENGINEER OF ANY DISCREPANCIES.
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- C. CONTRACTOR SHALL CONTACT J.U.L.I.E. (811 OR 1-800-892-0123) AND PRIVATE LOCATING SERVICE TO LOCATE ALL UNDERGROUND UTILITY LINES MICK TO STARTING ANY DEMOLITION AND/OR EXCAVATION. EXACT LOCATIONS OF ANY
- D. CONTRACTOR SHALL ENSURE POSITIVE SITE DRAINAGE AT THE END OF EACH WORKING DAY DURING CONSTRUCTION OPERATIONS. FAILURE TO PROVIDE ADEQUATE DRAINAGE WILL PRECLUDE THE CONTRACTOR FROM ANY POSSIBLE COMPENSATION REQUESTED DUE TO DELAYS OR UNSUITABLE MATERIALS CREATED
- E. CONTRACTOR SHALL RESTORE ALL DISTURBED AREAS OUTSIDE OF CONSTRUCTION LIMITS TO ORIGINAL CONDITION OR BETTER.
- F. CONTRACTOR SHALL REPAIR AT HIS EXPENSE ANY DAMAGE TO EXISTING ASPHALT, CONCRETE, CURBS, SIDEWALKS, ETC. RESULTING FROM CONSTRUCTION TRAFFIC AND/OR OPERATIONS. REPAIRS SHALL BE MADE TO THE SATISFACTION
- REMAIN. ANY DAMAGE TO EXISTING UTILITIES NOT NOTED TO BE REMOVED SHALL BE REPAIRED AT CONTRACTOR'S EXPENSE TO THE SATISFACTION OF THE OWNER
- H. ALL EXISTING TREES SHOWN ARE TO REMAIN UNLESS OTHERWISE NOTED. ALL HANDICAP ACCESSIBLE ROUTES (SIDEWALKS, WALKWAYS, PAVEMENTS, ETC.)
- MAXIMUM SLOPE OF 2.00% IN ALL DIRECTIONS J. VOIDS LEFT BY ANY ITEM REMOVED UNDER ANY PROPOSED BUILDING, PAVEMENT, OR WALK OR WITHIN 24" THEREOF SHALL BE BACKFILLED WITH ENGINEERED FILL
- ACCORDING TO THE GEOTECHNICAL REPORT. K. ALL FIRE ACCESS LANES WITHIN THE PROJECT AREA SHALL REMAIN IN SERVICE,
- L. CONSTRUCTION ACCESS POINTS TO THE SITE SHALL BE PROTECTED IN SUCH A WAY AS TO PREVENT TRACKING OF MUD OR SOIL ONTO PUBLIC THOROUGHFARES. ALL SEDIMENT SPILLED, DROPPED, WASHED OR TRACKED ONTO PUBLIC
- M. ALL EXISTING SUBGRADE TO BE SCARIFIED (DISKED) TO A DEPTH OF 12" AND RE-COMPACTED, AND THEN TESTED USING A DYNAMIC CONE PENETROMETER. SEE GEOTECHNICAL REPORT FOR ADDITIONAL REQUIREMENTS.
- FROM THE SITE AND LEGALLY DISPOSED OF. O. CONTRACTOR TO PROVIDE SOIL TESTING SERVICES FOR COMPLETION OF THE
- ILLINOIS ENVIRONMENTAL PROTECTION AGENCY'S LPC-662 AND/OR LPC-663 FORMS AS PART OF THEIR CONTRACT.
- Q. ALL TOPSOIL BENEATH PROPOSED STRUCTURES AND PAVEMENT SHALL BE REMOVED. REFER TO THE GEOTECHNICAL REPORT DATED JULY 23, 2019
- S. ALL UNCONTAMINATED EXCESS SOILS THAT CANNOT BE USED AS SUITABLE FILL SHALL BE HAULED TO AN OFF-SITE HOFFMAN ESTATES PARK DISTRICT SITE. UP TO 600 CUBIC YARDS OF TOPSOIL SHALL BE HAULED TO THE POPLAR GOLF COURSE MAINTENANCE FACILITY LOCATED AT 1450 POPLAR CREEK DRIVE IN HOFFMAN ESTATES. CONTRACTOR SHALL COORDINATE ADDITIONAL DISPOSAL LOCATIONS WITH OWNER.

KEYMAP



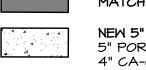

5" PORTLAND CEMENT CONCRETE 4" CA-6 BASE COURSE




2-1/4" HMA BINDER COURSE 10" CA-6 BASE COURSE NEW I-3/4" ASPHALT MILL & OVERLAY



NEW CONCRETE SPLASH PAD



- A.A. ADDITIONAL EXISTING TOPOGRAPHY AND UTILITY DATA SHOWN REPRESENTS
- EXISTING ELECTRIC, GAS, TELEPHONE, ETC. LINES ARE UNKNOWN.
- AS A RESULT.
- OF THE OWNER AND/OR ENGINEER. G. CONTRACTOR TO UTILIZE CARE WHEN WORKING NEAR EXISTING UTILITIES TO
- AND/OR ENGINEER.
- SHALL MAINTAIN A MAXIMUM CROSS SLOPE OF 2.00% AND A MAXIMUM LONGITUDINAL SLOPE OF 5.00%. ACCESSIBLE PARKING STALLS SHALL MAINTAIN A
- CLEAN OF DEBRIS, AND ACCESSIBLE FOR USE BY EMERGENCY VEHICLES.
- RIGHTS-OF-WAY MUST BE REMOVED IMMEDIATELY BY THE CONTRACTOR.
- N. ALL EXCESS SOILS THAT CANNOT BE USED AS SUITABLE FILL SHALL BE HAULED
- JULY 23, 2019 PREPARED BY ILLINOIS DRILLING & TESTING CO., INC. PREPARED BY ILLINOIS DRILLING & TESTING CO., INC FOR EXISTING TOPSOIL
- R. ALL INTERSECTIONS OR CHANGES IN DIRECTION ON HANDICAP ACCESSIBLE <u>ROUTES (SIDEMALKS, MALKMAYS, PAVEMENTS, ETC.) SHALL MAINTAIN A MAXIMUM</u> SLOPE OF 2.00% IN ALL DIRECTIONS.

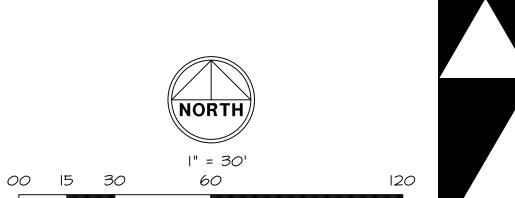

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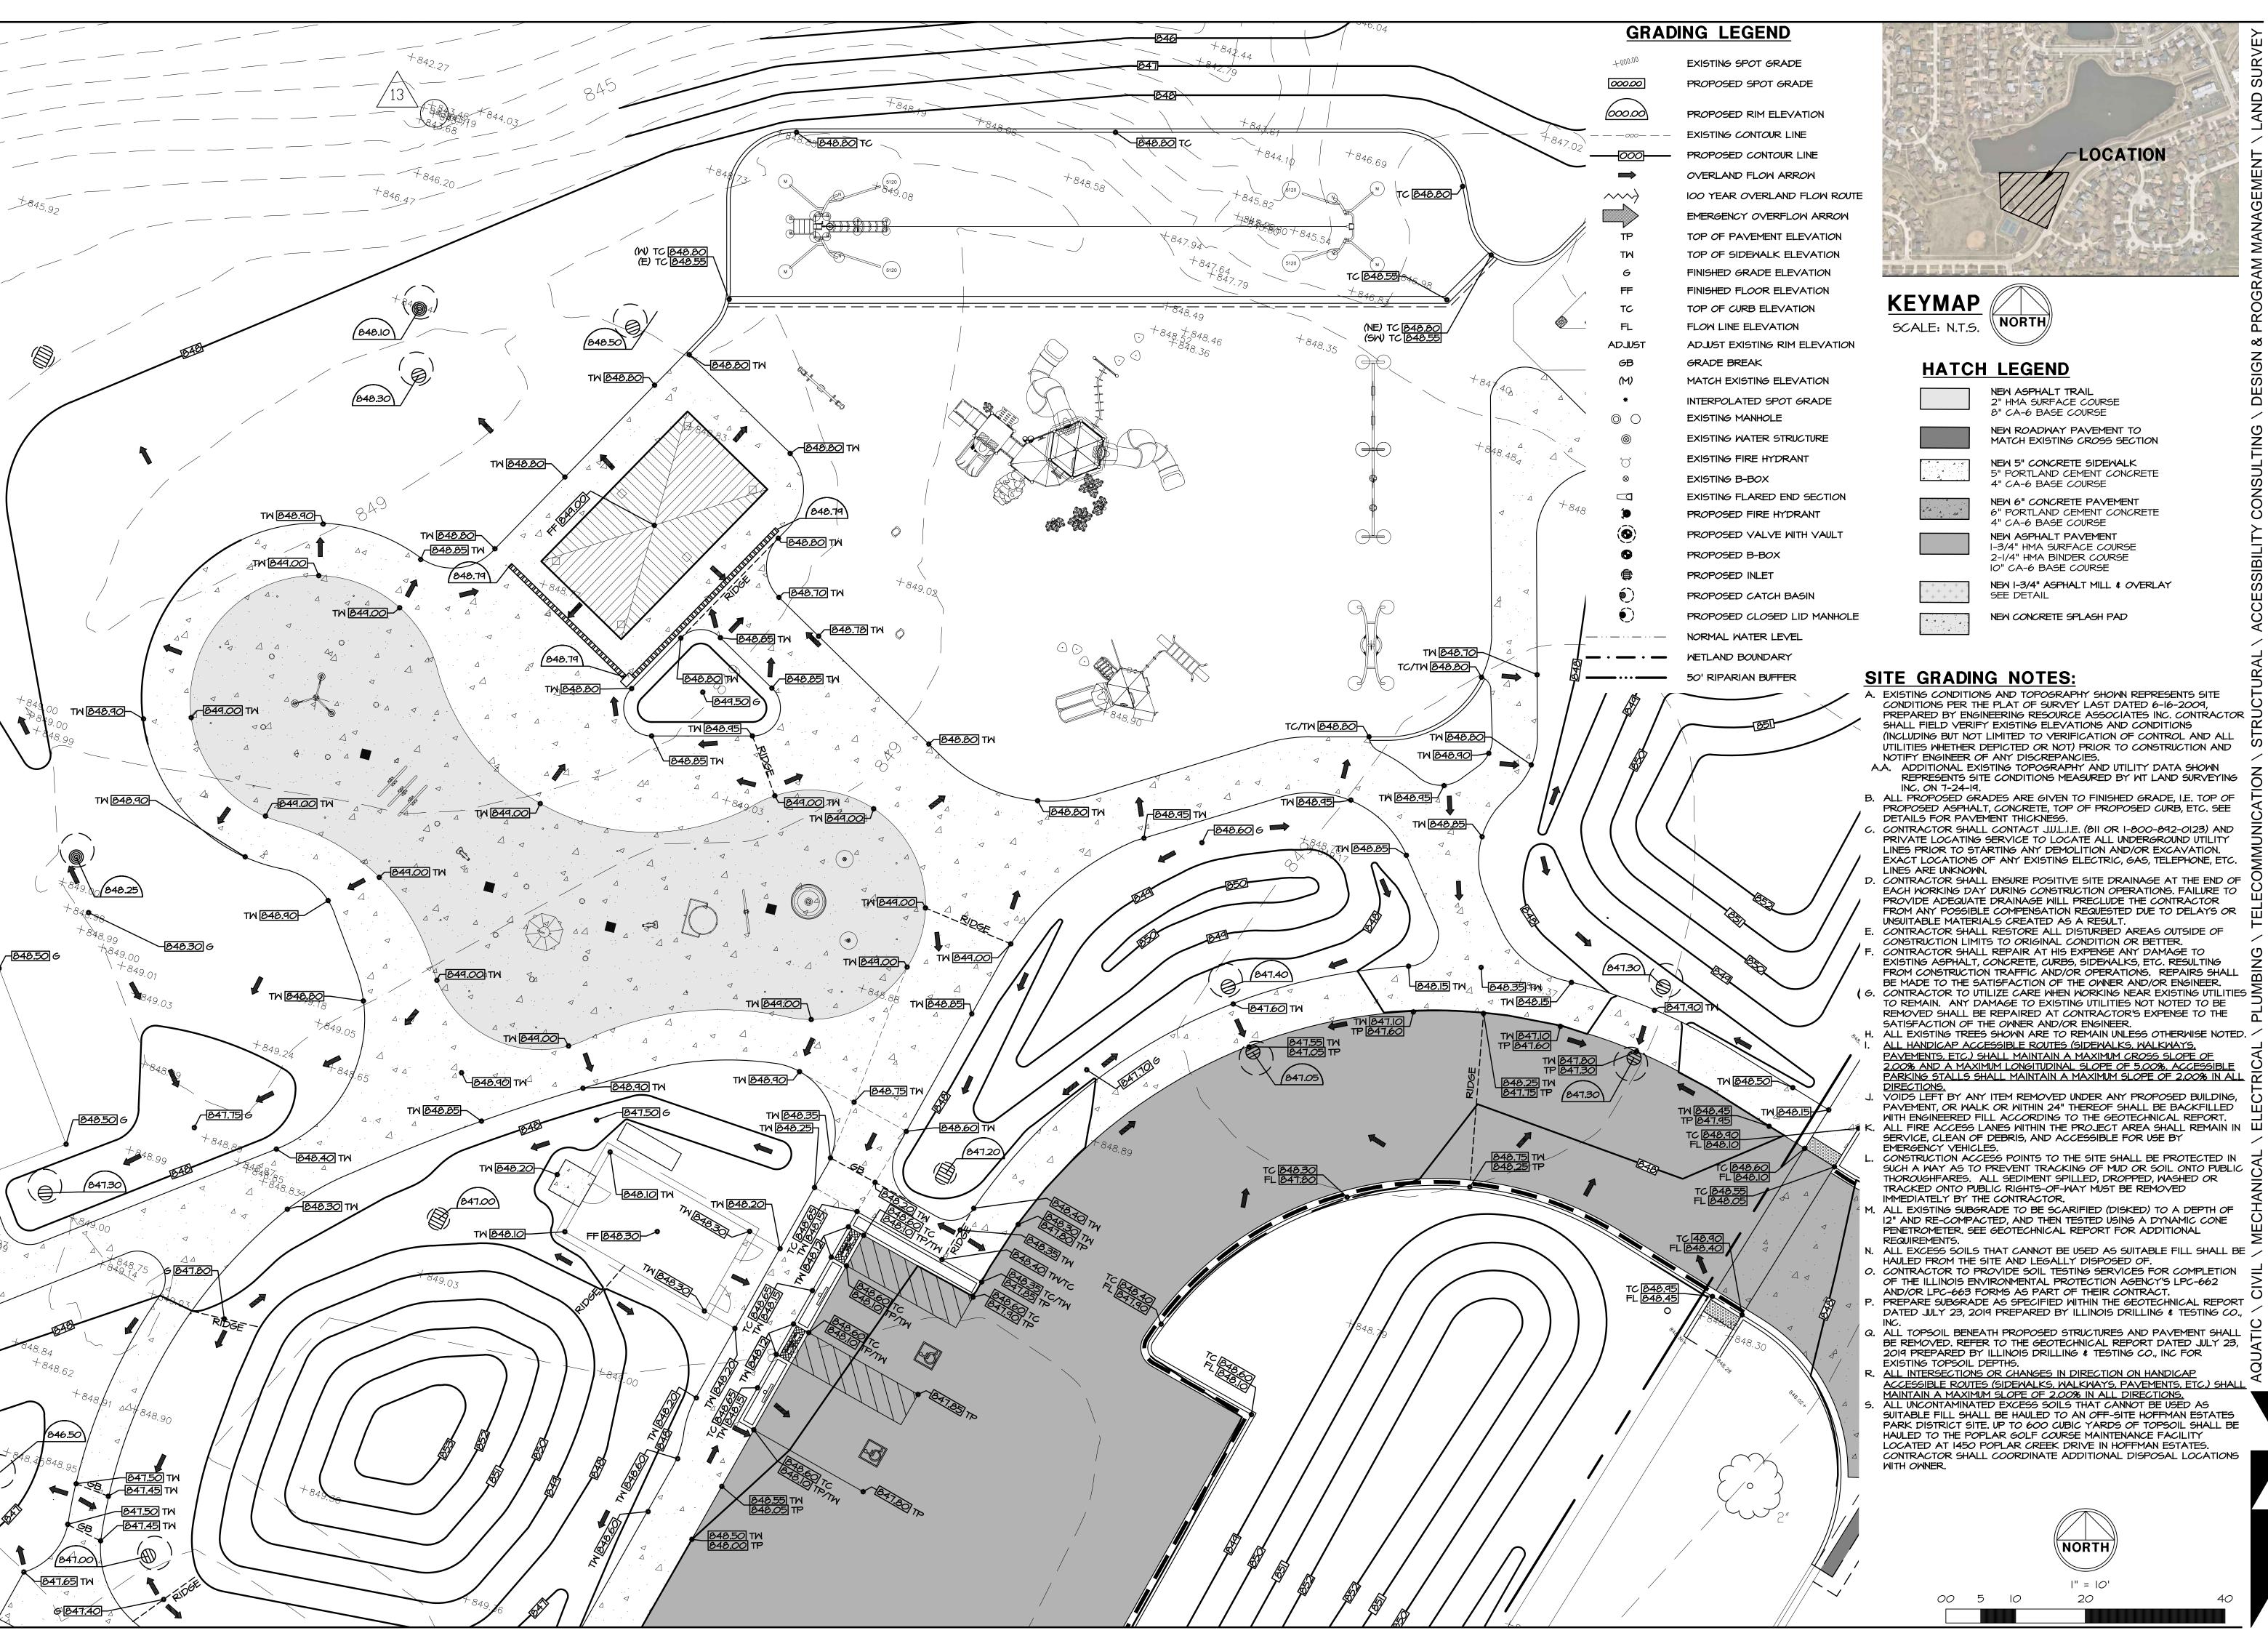
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VILLAGE 8/23/19 9/17/19 10/22/19

MWRD MWRD 11/25/19 VILLAGE MWRD 1/2/20 SWCD FOR BID 1/23/20

DRAWN: PS 1911354C

> C-5.4 SITE GRADING PLAN



HECK: CMS DRAWN: PS 1911354C

VILLAGE

MWRD

MWRD

MWRD

SWCD

FOR BID

VILLAGE

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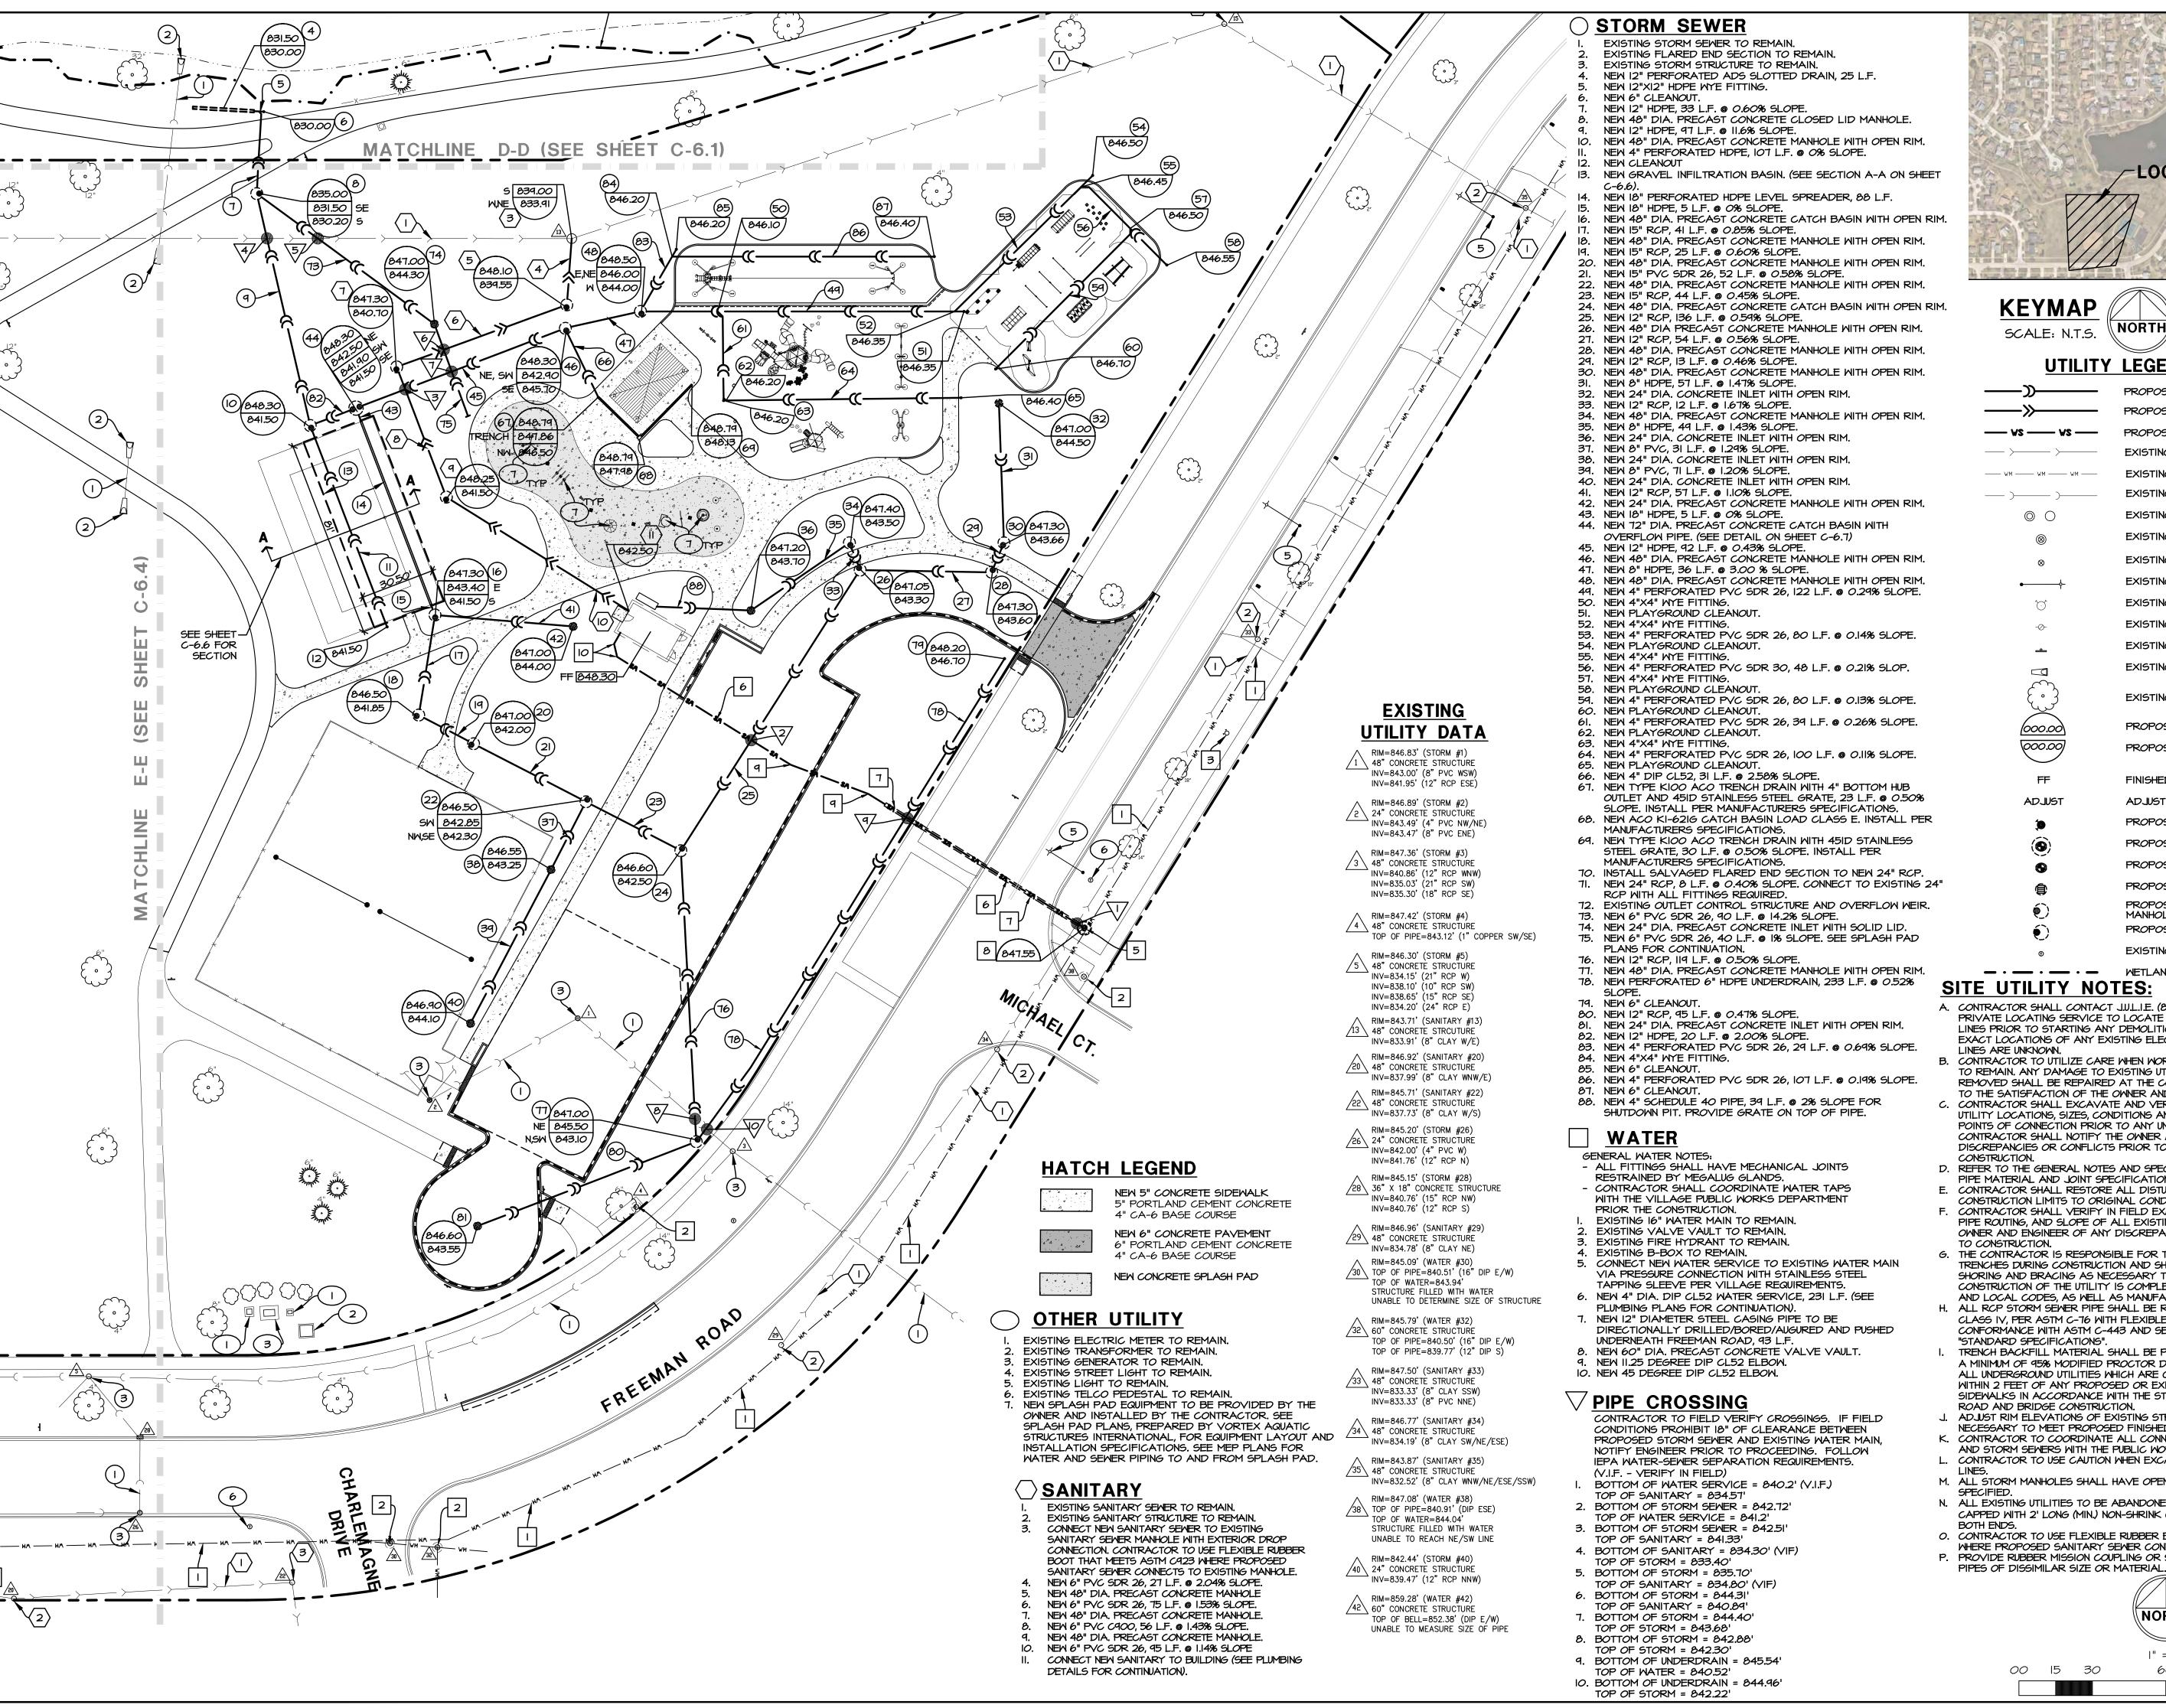
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1/23/20

C-5.5





ENF 14

VILLAGE

MWRD

MWRD

MWRD

SWCD

FOR BID

VILLAGE

8/23/19

9/17/19

11/25/19

1/23/20



UTILITY LEGEND

PROPOSED STORM SEWER PROPOSED SANITARY SEWER PROPOSED WATER SERVICE EXISTING SANITARY SEWER EXISTING WATER MAIN EXISTING STORM SEWER EXISTING MANHOLE EXISTING WATER STRUCTURE EXISTING B-BOX EXISTING STREET LIGHT EXISTING FIRE HYDRANT EXISTING UTILITY POLE EXISTING SIGN EXISTING FLARED END SECTION EXISTING TREE PROPOSED RIM ELEVATION PROPOSED INVERT ELEVATION

> FINISHED FLOOR ELEVATION ADJUST EXISTING RIM ELEVATION

PROPOSED FIRE HYDRANT PROPOSED VALVE WITH VAULT PROPOSED B-BOX

PROPOSED INLET PROPOSED OPEN LID MANHOLE/CATCH BASIN PROPOSED CLOSED LID MANHOLE EXISTING TELCO PEDESTAL

WETLAND BOUNDARY _ . _ . _ . _

SITE UTILITY NOTES:

- A. CONTRACTOR SHALL CONTACT J.U.L.I.E. (811 OR 1-800-892-0123) AND PRIVATE LOCATING SERVICE TO LOCATE ALL UNDERGROUND UTILITY LINES PRIOR TO STARTING ANY DEMOLITION AND/OR EXCAVATION. EXACT LOCATIONS OF ANY EXISTING ELECTRIC, GAS, TELEPHONE, ETC. LINES ARE UNKNOWN.
- B. CONTRACTOR TO UTILIZE CARE WHEN WORKING NEAR EXISTING UTILITIES TO REMAIN. ANY DAMAGE TO EXISTING UTILITIES NOT NOTED TO BE REMOVED SHALL BE REPAIRED AT THE CONTRACTOR'S EXPENSE AND TO THE SATISFACTION OF THE OWNER AND/OR ENGINEER. C. CONTRACTOR SHALL EXCAVATE AND VERIFY IN FIELD ALL EXISTING
- UTILITY LOCATIONS, SIZES, CONDITIONS AND ELEVATIONS AT PROPOSED POINTS OF CONNECTION PRIOR TO ANY UNDERGROUND CONSTRUCTION. CONTRACTOR SHALL NOTIFY THE OWNER AND ENGINEER OF ANY DISCREPANCIES OR CONFLICTS PRIOR TO PROCEEDING WITH
- D. REFER TO THE GENERAL NOTES AND SPECIFICATION SHEETS FOR ALL PIPE MATERIAL AND JOINT SPECIFICATIONS.
- E. CONTRACTOR SHALL RESTORE ALL DISTURBED AREAS OUTSIDE OF CONSTRUCTION LIMITS TO ORIGINAL CONDITION OR BETTER. F. CONTRACTOR SHALL VERIFY IN FIELD EXACT SIZE, MATERIAL, INVERT, PIPE ROUTING, AND SLOPE OF ALL EXISTING UTILITIES AND NOTIFY THE
- OWNER AND ENGINEER OF ANY DISCREPANCIES OR CONFLICTS PRIOR TO CONSTRUCTION. G. THE CONTRACTOR IS RESPONSIBLE FOR THE STABILITY OF UTILITY TRENCHES DURING CONSTRUCTION AND SHALL PROVIDE TEMPORARY SHORING AND BRACING AS NECESSARY TO MAINTAIN STABILITY UNTIL
- CONSTRUCTION OF THE UTILITY IS COMPLETE IN ORDER TO MEET OSHA AND LOCAL CODES, AS WELL AS MANUFACTURER'S REQUIREMENTS. H. ALL RCP STORM SEWER PIPE SHALL BE REINFORCED CONCRETE PIPE, CLASS IV, PER ASTM C-76 WITH FLEXIBLE (O-RING) GASKET JOINTS IN CONFORMANCE WITH ASTM C-443 AND SECTION 31-1.08 OF THE
- TRENCH BACKFILL MATERIAL SHALL BE PLACED AND COMPACTED TO A MINIMUM OF 95% MODIFIED PROCTOR DENSITY (ASTM D-1557) OVER ALL UNDERGROUND UTILITIES WHICH ARE CONSTRUCTED UNDER OR WITHIN 2 FEET OF ANY PROPOSED OR EXISTING PAVEMENT OR SIDEWALKS IN ACCORDANCE WITH THE STANDARD SPECIFICATIONS FOR
- ROAD AND BRIDGE CONSTRUCTION. J. ADJUST RIM ELEVATIONS OF EXISTING STRUCTURES IN PAVEMENT AS NECESSARY TO MEET PROPOSED FINISHED GRADE.
- K. CONTRACTOR TO COORDINATE ALL CONNECTIONS TO CITY UTILITIES AND STORM SEWERS WITH THE PUBLIC WORKS DEPARTMENT. L. CONTRACTOR TO USE CAUTION WHEN EXCAVATING AT EXISTING UTILITY
- M. ALL STORM MANHOLES SHALL HAVE OPEN LIDS UNLESS OTHERWISE
- N. ALL EXISTING UTILITIES TO BE ABANDONED IN PLACE SHALL BE CAPPED WITH 2' LONG (MIN.) NON-SHRINK CONCRETE MORTAR PLUGS AT
- O. CONTRACTOR TO USE FLEXIBLE RUBBER BOOT THAT MEETS ASTM C923 WHERE PROPOSED SANITARY SEWER CONNECTS TO EXISTING MANHOLE. P. PROVIDE RUBBER MISSION COUPLING OR SIMILAR CONNECTION BETWEEN




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SITE UTILITY PLAN

1911354C C-6.0

DRAWN: PS

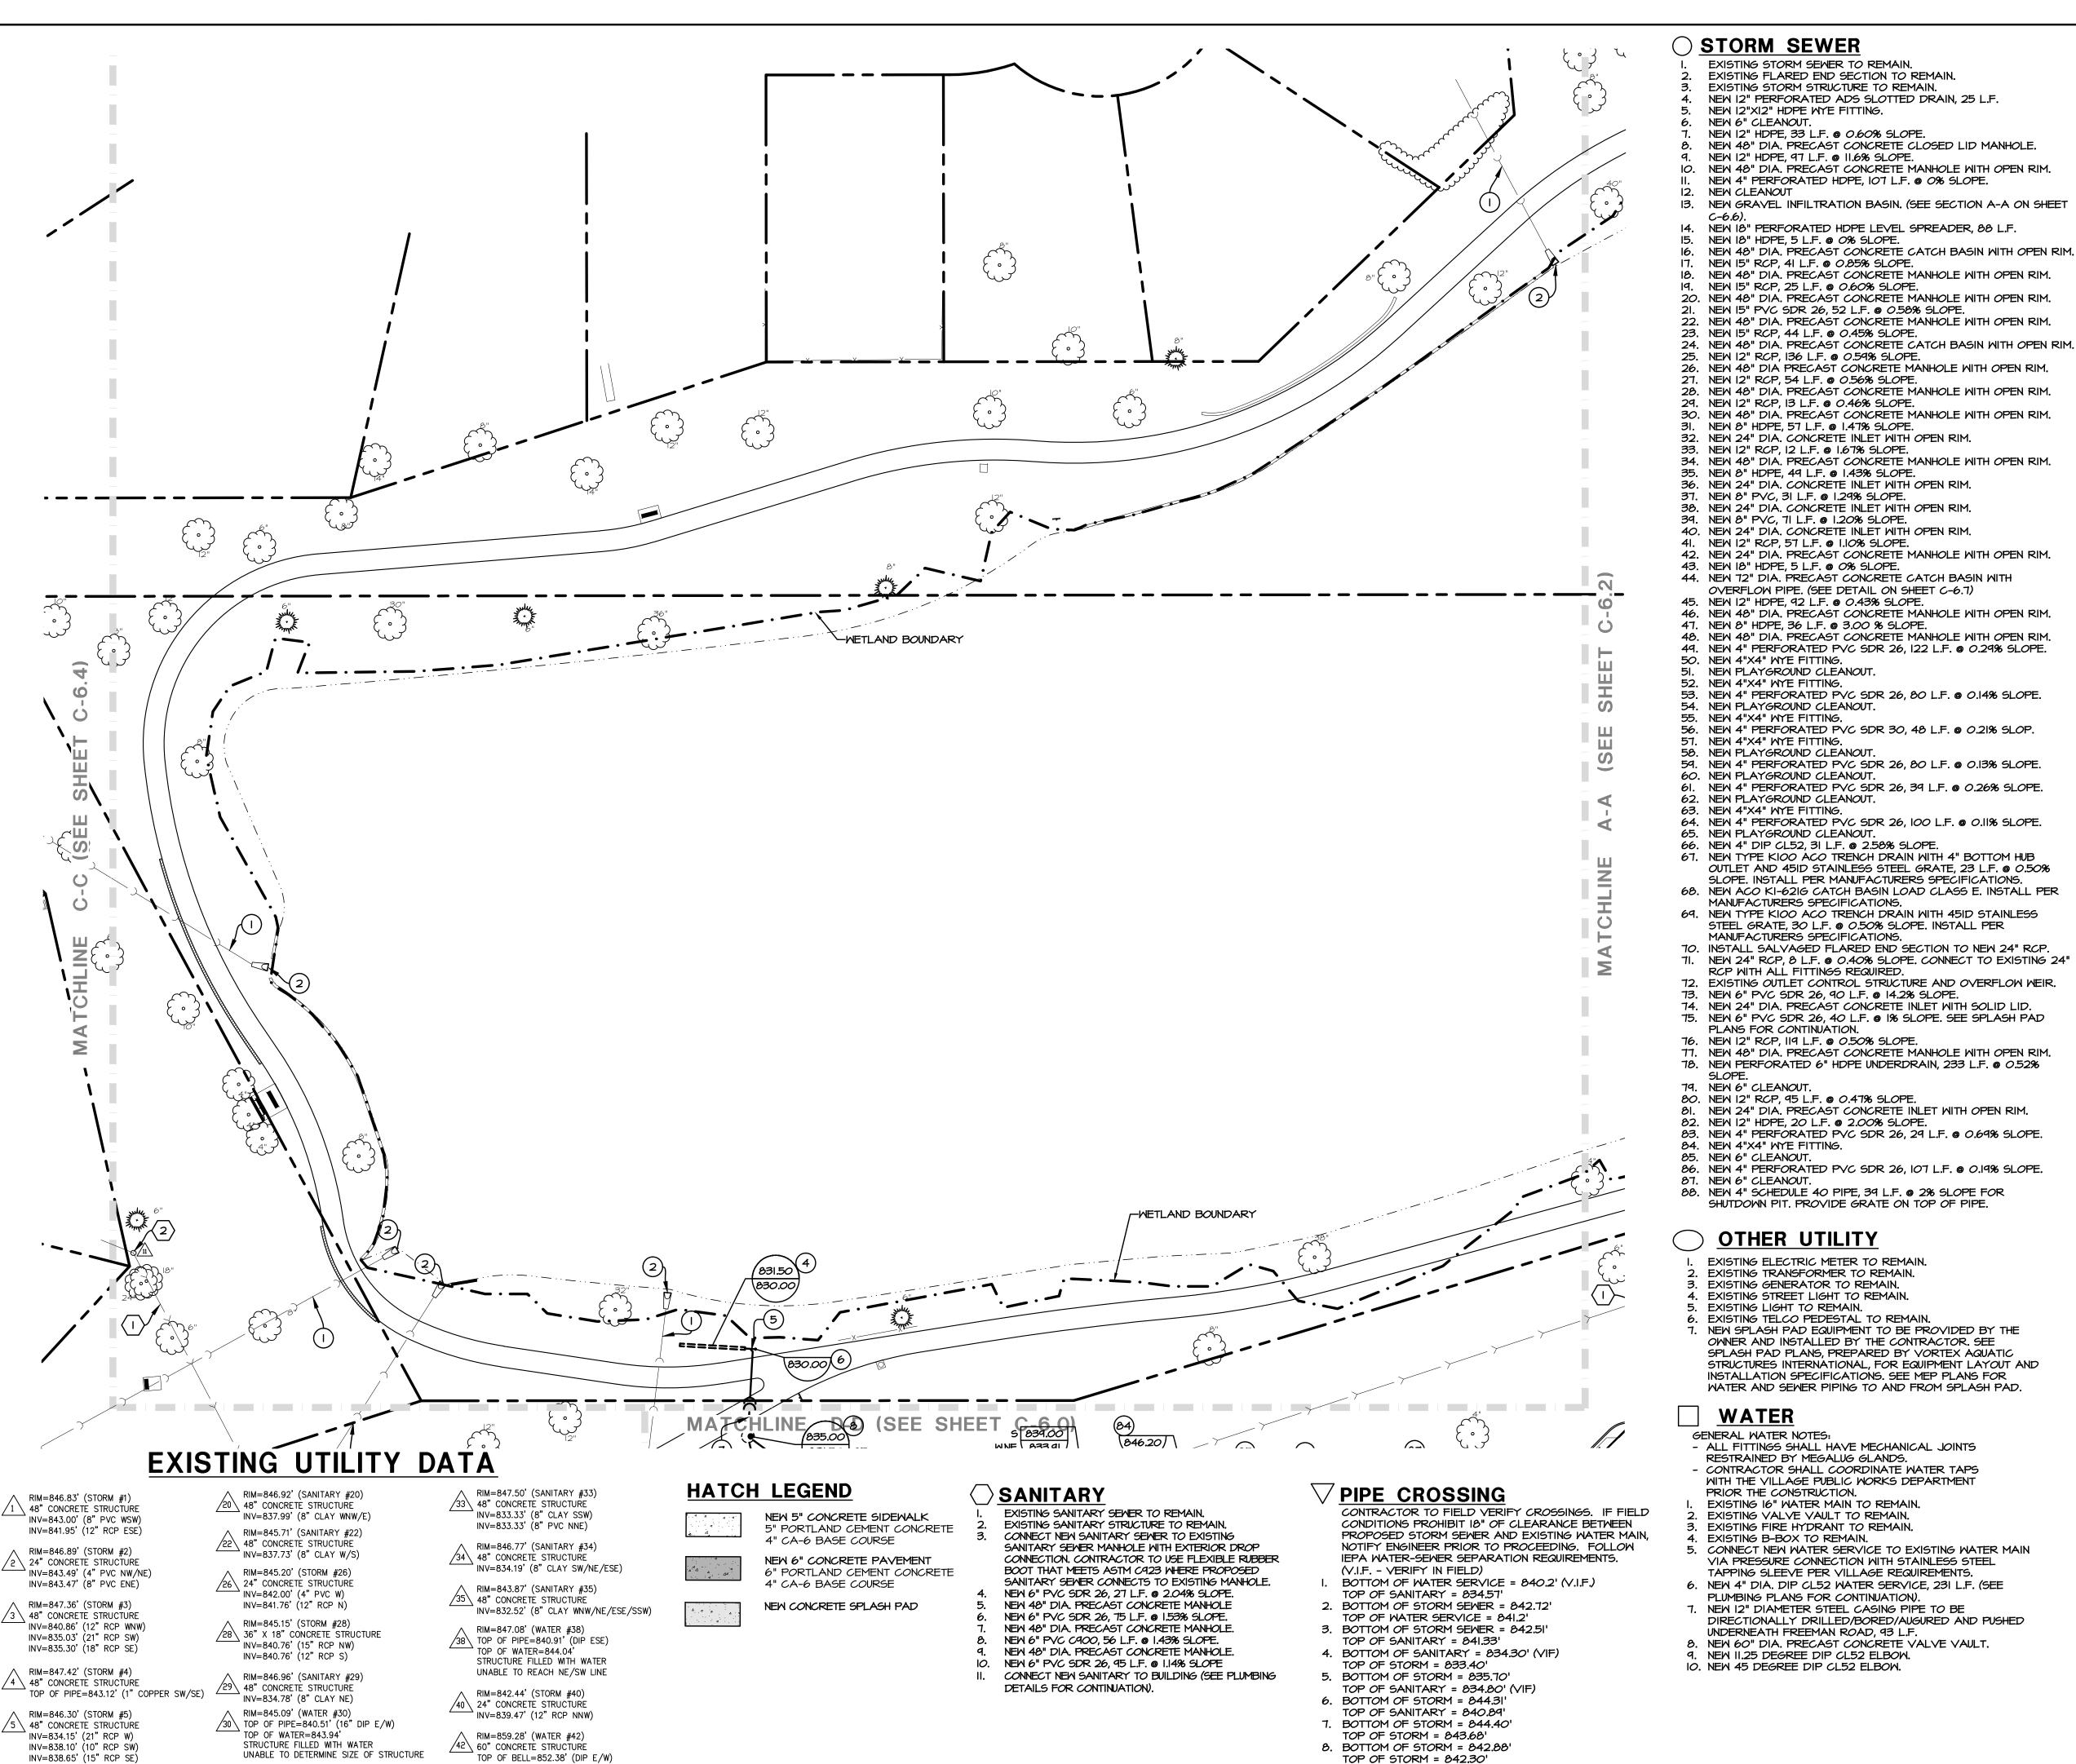

UNABLE TO MEASURE SIZE OF PIPE

INV=834.20' (24" RCP E)

RIM=843.71' (SANITARY #13

INV=833.91' (8" CLAY W/E)

/13 \ 48" CONCRETE STRCUTURE

RIM=845.79' (WATER #32)

TOP OF PIPE=840.50' (16" DIP E/W)

TOP OF PIPE=839.77' (12" DIP S)

32\ 60" CONCRETE STRUCTURE

STORM SEWER

- EXISTING STORM SEWER TO REMAIN EXISTING FLARED END SECTION TO REMAIN. EXISTING STORM STRUCTURE TO REMAIN. NEW 12" PERFORATED ADS SLOTTED DRAIN, 25 L.F. NEW 12"X12" HDPE WYE FITTING.
- NEW 6" CLEANOUT. NEW 12" HDPE, 33 L.F. @ 0.60% SLOPE.
- NEW 48" DIA. PRECAST CONCRETE CLOSED LID MANHOLE. NEW 12" HDPE, 97 L.F. @ 11.6% SLOPE. NEW 48" DIA. PRECAST CONCRETE MANHOLE WITH OPEN RIM. NEW 4" PERFORATED HDPE, IOT L.F. @ 0% SLOPE.
- 13. NEW GRAVEL INFILTRATION BASIN. (SEE SECTION A-A ON SHEET
- NEW 18" PERFORATED HDPE LEVEL SPREADER, 88 L.F. NEW 18" HDPE, 5 L.F. @ 0% SLOPE.
- NEW 15" RCP, 41 L.F. @ 0.85% SLOPE. NEW 48" DIA. PRECAST CONCRETE MANHOLE WITH OPEN RIM. NEW 15" RCP, 25 L.F. @ 0.60% SLOPE. 20. NEW 48" DIA. PRECAST CONCRETE MANHOLE WITH OPEN RIM.
- 21. NEW 15" PVC SDR 26, 52 L.F. @ 0.58% SLOPE. 22. NEW 48" DIA. PRECAST CONCRETE MANHOLE WITH OPEN RIM. 23. NEW 15" RCP, 44 L.F. @ 0.45% SLOPE. 24. NEW 48" DIA. PRECAST CONCRETE CATCH BASIN WITH OPEN RIM.
- 25. NEW 12" RCP, 136 L.F. @ 0.59% SLOPE. 26. NEW 48" DIA PRECAST CONCRETE MANHOLE WITH OPEN RIM. 27. NEW 12" RCP, 54 L.F. @ 0.56% SLOPE. 28. NEW 48" DIA. PRECAST CONCRETE MANHOLE WITH OPEN RIM.
- 29. NEW 12" RCP, 13 L.F. @ 0.46% SLOPE. 30. NEW 48" DIA. PRECAST CONCRETE MANHOLE WITH OPEN RIM. 31. NEW 8" HDPE, 57 L.F. @ 1.47% SLOPE. 32. NEW 24" DIA. CONCRETE INLET WITH OPEN RIM.
- 33. NEW 12" RCP, 12 L.F. @ 1.67% SLOPE 34. NEW 48" DIA. PRECAST CONCRETE MANHOLE WITH OPEN RIM
- 35. NEW 8" HDPE, 49 L.F. @ 1.43% SLOPE. 36. NEW 24" DIA. CONCRETE INLET WITH OPEN RIM. 37. NEW 8" PVC, 31 L.F. @ 1.29% SLOPE.
- 39. NEW 8" PVC, 71 L.F. @ 1.20% SLOPE. 40. NEW 24" DIA. CONCRETE INLET WITH OPEN RIM. 41. NEW 12" RCP, 57 L.F. @ 1.10% SLOPE.
- 42. NEW 24" DIA. PRECAST CONCRETE MANHOLE WITH OPEN RIM. 43. NEW 18" HDPE, 5 L.F. @ 0% SLOPE. 44. NEW 72" DIA. PRECAST CONCRETE CATCH BASIN WITH OVERFLOW PIPE. (SEE DETAIL ON SHEET C-6.7)
- 46. NEW 46" DIA. PRECAST CONCRETE MANHOLE WITH OPEN RIM. 47. NEW 8" HDPE, 36 L.F. @ 3.00 % SLOPE. 48. NEW 48" DIA. PRECAST CONCRETE MANHOLE WITH OPEN RIM. 49. NEW 4" PERFORATED PVC SDR 26, 122 L.F. @ 0.29% SLOPE.
- 51. NEW PLAYGROUND CLEANOUT. 52. NEW 4"X4" MYE FITTING. 53. NEW 4" PERFORATED PVC SDR 26, 80 L.F. @ 0.14% SLOPE.
- 56. NEW 4" PERFORATED PVC SDR 30, 48 L.F. @ 0.21% SLOP. 57. NEW 4"X4" WYE FITTING.
- 58. NEW PLAYGROUND CLEANOUT. 59. NEW 4" PERFORATED PVC SDR 26, 80 L.F. @ 0.13% SLOPE.
- 60. NEW PLAYGROUND CLEANOUT. 61. NEW 4" PERFORATED PVC SDR 26, 39 L.F. @ 0.26% SLOPE. 62. NEW PLAYGROUND CLEANOUT.
- 64. NEW 4" PERFORATED PVC SDR 26, 100 L.F. @ 0.11% SLOPE. 65. NEW PLAYGROUND CLEANOUT. 66. NEW 4" DIP CL52, 31 L.F. @ 2.58% SLOPE.
- OUTLET AND 45ID STAINLESS STEEL GRATE, 23 L.F. @ 0.50% SLOPE. INSTALL PER MANUFACTURERS SPECIFICATIONS. 68. NEW ACO KI-62IG CATCH BASIN LOAD CLASS E. INSTALL PER MANUFACTURERS SPECIFICATIONS.
- 69. NEW TYPE KIOO ACO TRENCH DRAIN WITH 45ID STAINLESS STEEL GRATE, 30 L.F. @ 0.50% SLOPE. INSTALL PER MANUFACTURERS SPECIFICATIONS.
- 70. INSTALL SALVAGED FLARED END SECTION TO NEW 24" RCP. NEW 24" RCP, 8 L.F. @ 0.40% SLOPE. CONNECT TO EXISTING 24" RCP WITH ALL FITTINGS REQUIRED. 72. EXISTING OUTLET CONTROL STRUCTURE AND OVERFLOW WEIR
- 73. NEW 6" PVC SDR 26, 90 L.F. @ 14.2% SLOPE. 74. NEW 24" DIA. PRECAST CONCRETE INLET WITH SOLID LID. 75. NEW 6" PVC SDR 26, 40 L.F. @ 1% SLOPE. SEE SPLASH PAD PLANS FOR CONTINUATION.
- 76. NEW 12" RCP, 119 L.F. @ 0.50% SLOPE. 77. NEW 48" DIA. PRECAST CONCRETE MANHOLE WITH OPEN RIM. 78. NEW PERFORATED 6" HDPE UNDERDRAIN, 233 L.F. @ 0.52%
- 80. NEW 12" RCP. 95 L.F. @ 0.47% SLOPE. 81. NEW 24" DIA. PRECAST CONCRETE INLET WITH OPEN RIM.
- 82. NEW 12" HDPE, 20 L.F. @ 2.00% SLOPE. 83. NEW 4" PERFORATED PVC SDR 26, 29 L.F. @ 0.69% SLOPE. 84. NEW 4"X4" MYE FITTING.
- 86. NEW 4" PERFORATED PVC SDR 26, 107 L.F. @ 0.19% SLOPE. 87. NEW 6" CLEANOUT. 88. NEW 4" SCHEDULE 40 PIPE, 39 L.F. @ 2% SLOPE FOR

OTHER UTILITY

- EXISTING ELECTRIC METER TO REMAIN. EXISTING TRANSFORMER TO REMAIN. EXISTING GENERATOR TO REMAIN.
- EXISTING STREET LIGHT TO REMAIN. . EXISTING LIGHT TO REMAIN.
- NEW SPLASH PAD EQUIPMENT TO BE PROVIDED BY THE OWNER AND INSTALLED BY THE CONTRACTOR. SEE SPLASH PAD PLANS, PREPARED BY VORTEX AQUATIC STRUCTURES INTERNATIONAL, FOR EQUIPMENT LAYOUT AND INSTALLATION SPECIFICATIONS. SEE MEP PLANS FOR WATER AND SEWER PIPING TO AND FROM SPLASH PAD.


9. BOTTOM OF UNDERDRAIN = 845.54'

10. BOTTOM OF UNDERDRAIN = 844.96'

TOP OF WATER = 840.52'

TOP OF STORM = 842,22'

- GENERAL WATER NOTES:
- ALL FITTINGS SHALL HAVE MECHANICAL JOINTS RESTRAINED BY MEGALUG GLANDS. - CONTRACTOR SHALL COORDINATE WATER TAPS WITH THE VILLAGE PUBLIC WORKS DEPARTMENT
- PRIOR THE CONSTRUCTION. EXISTING 16" WATER MAIN TO REMAIN. EXISTING VALVE VAULT TO REMAIN.
- . CONNECT NEW WATER SERVICE TO EXISTING WATER MAIN VIA PRESSURE CONNECTION WITH STAINLESS STEEL TAPPING SLEEVE PER VILLAGE REQUIREMENTS.
- 6. NEW 4" DIA. DIP CL52 WATER SERVICE, 231 L.F. (SEE PLUMBING PLANS FOR CONTINUATION). 7. NEW 12" DIAMETER STEEL CASING PIPE TO BE DIRECTIONALLY DRILLED/BORED/AUGURED AND PUSHED
- NEW 60" DIA. PRECAST CONCRETE VALVE VAULT. . NEW II.25 DEGREE DIP CL52 ELBOW. IO. NEW 45 DEGREE DIP CL52 ELBOW.

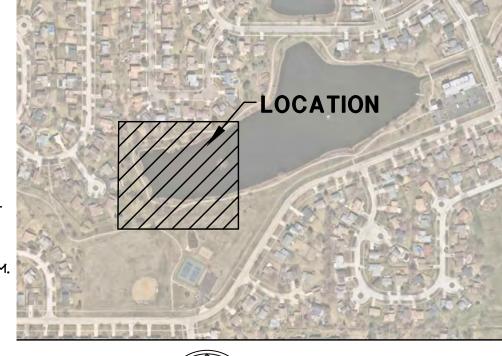

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UTILITY LEGEND

PROPOSED STORM SEWER PROPOSED SANITARY SEWER PROPOSED WATER SERVICE EXISTING SANITARY SEWER EXISTING WATER MAIN —— vm —— vm —— EXISTING STORM SEWER _____ EXISTING MANHOLE \odot EXISTING WATER STRUCTURE EXISTING B-BOX EXISTING STREET LIGHT •-----EXISTING FIRE HYDRANT EXISTING UTILITY POLE EXISTING SIGN

EXISTING TREE

PROPOSED INVERT ELEVATION

EXISTING FLARED END SECTION

PROPOSED RIM ELEVATION

FINISHED FLOOR ELEVATION ADJUST EXISTING RIM ELEVATION

PROPOSED FIRE HYDRANT PROPOSED VALVE WITH VAULT

PROPOSED B-BOX PROPOSED INLET

PROPOSED OPEN LID MANHOLE/CATCH BASIN PROPOSED CLOSED LID MANHOLE

WETLAND BOUNDARY

EXISTING TELCO PEDESTAL


SITE UTILITY NOTES:

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ADJUST

- A. CONTRACTOR SHALL CONTACT J.J.L.I.E. (811 OR 1-800-892-0123) AND PRIVATE LOCATING SERVICE TO LOCATE ALL UNDERGROUND UTILITY LINES PRIOR TO STARTING ANY DEMOLITION AND/OR EXCAVATION. EXACT LOCATIONS OF ANY EXISTING ELECTRIC, GAS, TELEPHONE, ETC.
- LINES ARE UNKNOWN. B. CONTRACTOR TO UTILIZE CARE WHEN WORKING NEAR EXISTING UTILITIES TO REMAIN. ANY DAMAGE TO EXISTING UTILITIES NOT NOTED TO BE REMOVED SHALL BE REPAIRED AT THE CONTRACTOR'S EXPENSE AND
- TO THE SATISFACTION OF THE OWNER AND/OR ENGINEER. C. CONTRACTOR SHALL EXCAVATE AND VERIFY IN FIELD ALL EXISTING UTILITY LOCATIONS, SIZES, CONDITIONS AND ELEVATIONS AT PROPOSED POINTS OF CONNECTION PRIOR TO ANY UNDERGROUND CONSTRUCTION. CONTRACTOR SHALL NOTIFY THE OWNER AND ENGINEER OF ANY DISCREPANCIES OR CONFLICTS PRIOR TO PROCEEDING WITH
- CONSTRUCTION. D. REFER TO THE GENERAL NOTES AND SPECIFICATION SHEETS FOR ALL
- PIPE MATERIAL AND JOINT SPECIFICATIONS. E. CONTRACTOR SHALL RESTORE ALL DISTURBED AREAS OUTSIDE OF CONSTRUCTION LIMITS TO ORIGINAL CONDITION OR BETTER.
- CONTRACTOR SHALL VERIFY IN FIELD EXACT SIZE, MATERIAL, INVERT, PIPE ROUTING, AND SLOPE OF ALL EXISTING UTILITIES AND NOTIFY THE OWNER AND ENGINEER OF ANY DISCREPANCIES OR CONFLICTS PRIOR TO CONSTRUCTION. G. THE CONTRACTOR IS RESPONSIBLE FOR THE STABILITY OF UTILITY
- TRENCHES DURING CONSTRUCTION AND SHALL PROVIDE TEMPORARY SHORING AND BRACING AS NECESSARY TO MAINTAIN STABILITY UNTIL CONSTRUCTION OF THE UTILITY IS COMPLETE IN ORDER TO MEET OSHA AND LOCAL CODES, AS WELL AS MANUFACTURER'S REQUIREMENTS. H. ALL RCP STORM SEWER PIPE SHALL BE REINFORCED CONCRETE PIPE, CLASS IV, PER ASTM C-76 WITH FLEXIBLE (O-RING) GASKET JOINTS IN
- CONFORMANCE WITH ASTM C-443 AND SECTION 31-1.08 OF THE "STANDARD SPECIFICATIONS". TRENCH BACKFILL MATERIAL SHALL BE PLACED AND COMPACTED TO A MINIMUM OF 95% MODIFIED PROCTOR DENSITY (ASTM D-1557) OVER ALL UNDERGROUND UTILITIES WHICH ARE CONSTRUCTED UNDER OR WITHIN 2 FEET OF ANY PROPOSED OR EXISTING PAVEMENT OR SIDEWALKS IN ACCORDANCE WITH THE STANDARD SPECIFICATIONS FOR
- ROAD AND BRIDGE CONSTRUCTION. J. ADJUST RIM ELEVATIONS OF EXISTING STRUCTURES IN PAVEMENT AS NECESSARY TO MEET PROPOSED FINISHED GRADE.
- K. CONTRACTOR TO COORDINATE ALL CONNECTIONS TO CITY UTILITIES AND STORM SEWERS WITH THE PUBLIC WORKS DEPARTMENT. L. CONTRACTOR TO USE CAUTION WHEN EXCAVATING AT EXISTING UTILITY
- M. ALL STORM MANHOLES SHALL HAVE OPEN LIDS UNLESS OTHERWISE
- SPECIFIED. N. ALL EXISTING UTILITIES TO BE ABANDONED IN PLACE SHALL BE CAPPED WITH 2' LONG (MIN.) NON-SHRINK CONCRETE MORTAR PLUGS AT
- BOTH ENDS. O. CONTRACTOR TO USE FLEXIBLE RUBBER BOOT THAT MEETS ASTM C923 WHERE PROPOSED SANITARY SEWER CONNECTS TO EXISTING MANHOLE. P. PROVIDE RUBBER MISSION COUPLING OR SIMILAR CONNECTION BETWEEN



1" = 30' 00 15 30

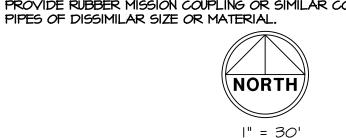C-6.1

SWCD 1/17/20 FOR BID 1/23/20

VILLAGE

MWRD

MWRD

MWRD

VILLAGE

8/23/19

9/17/19


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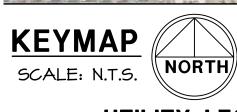
SITE UTILITY PLAN





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ENF 14

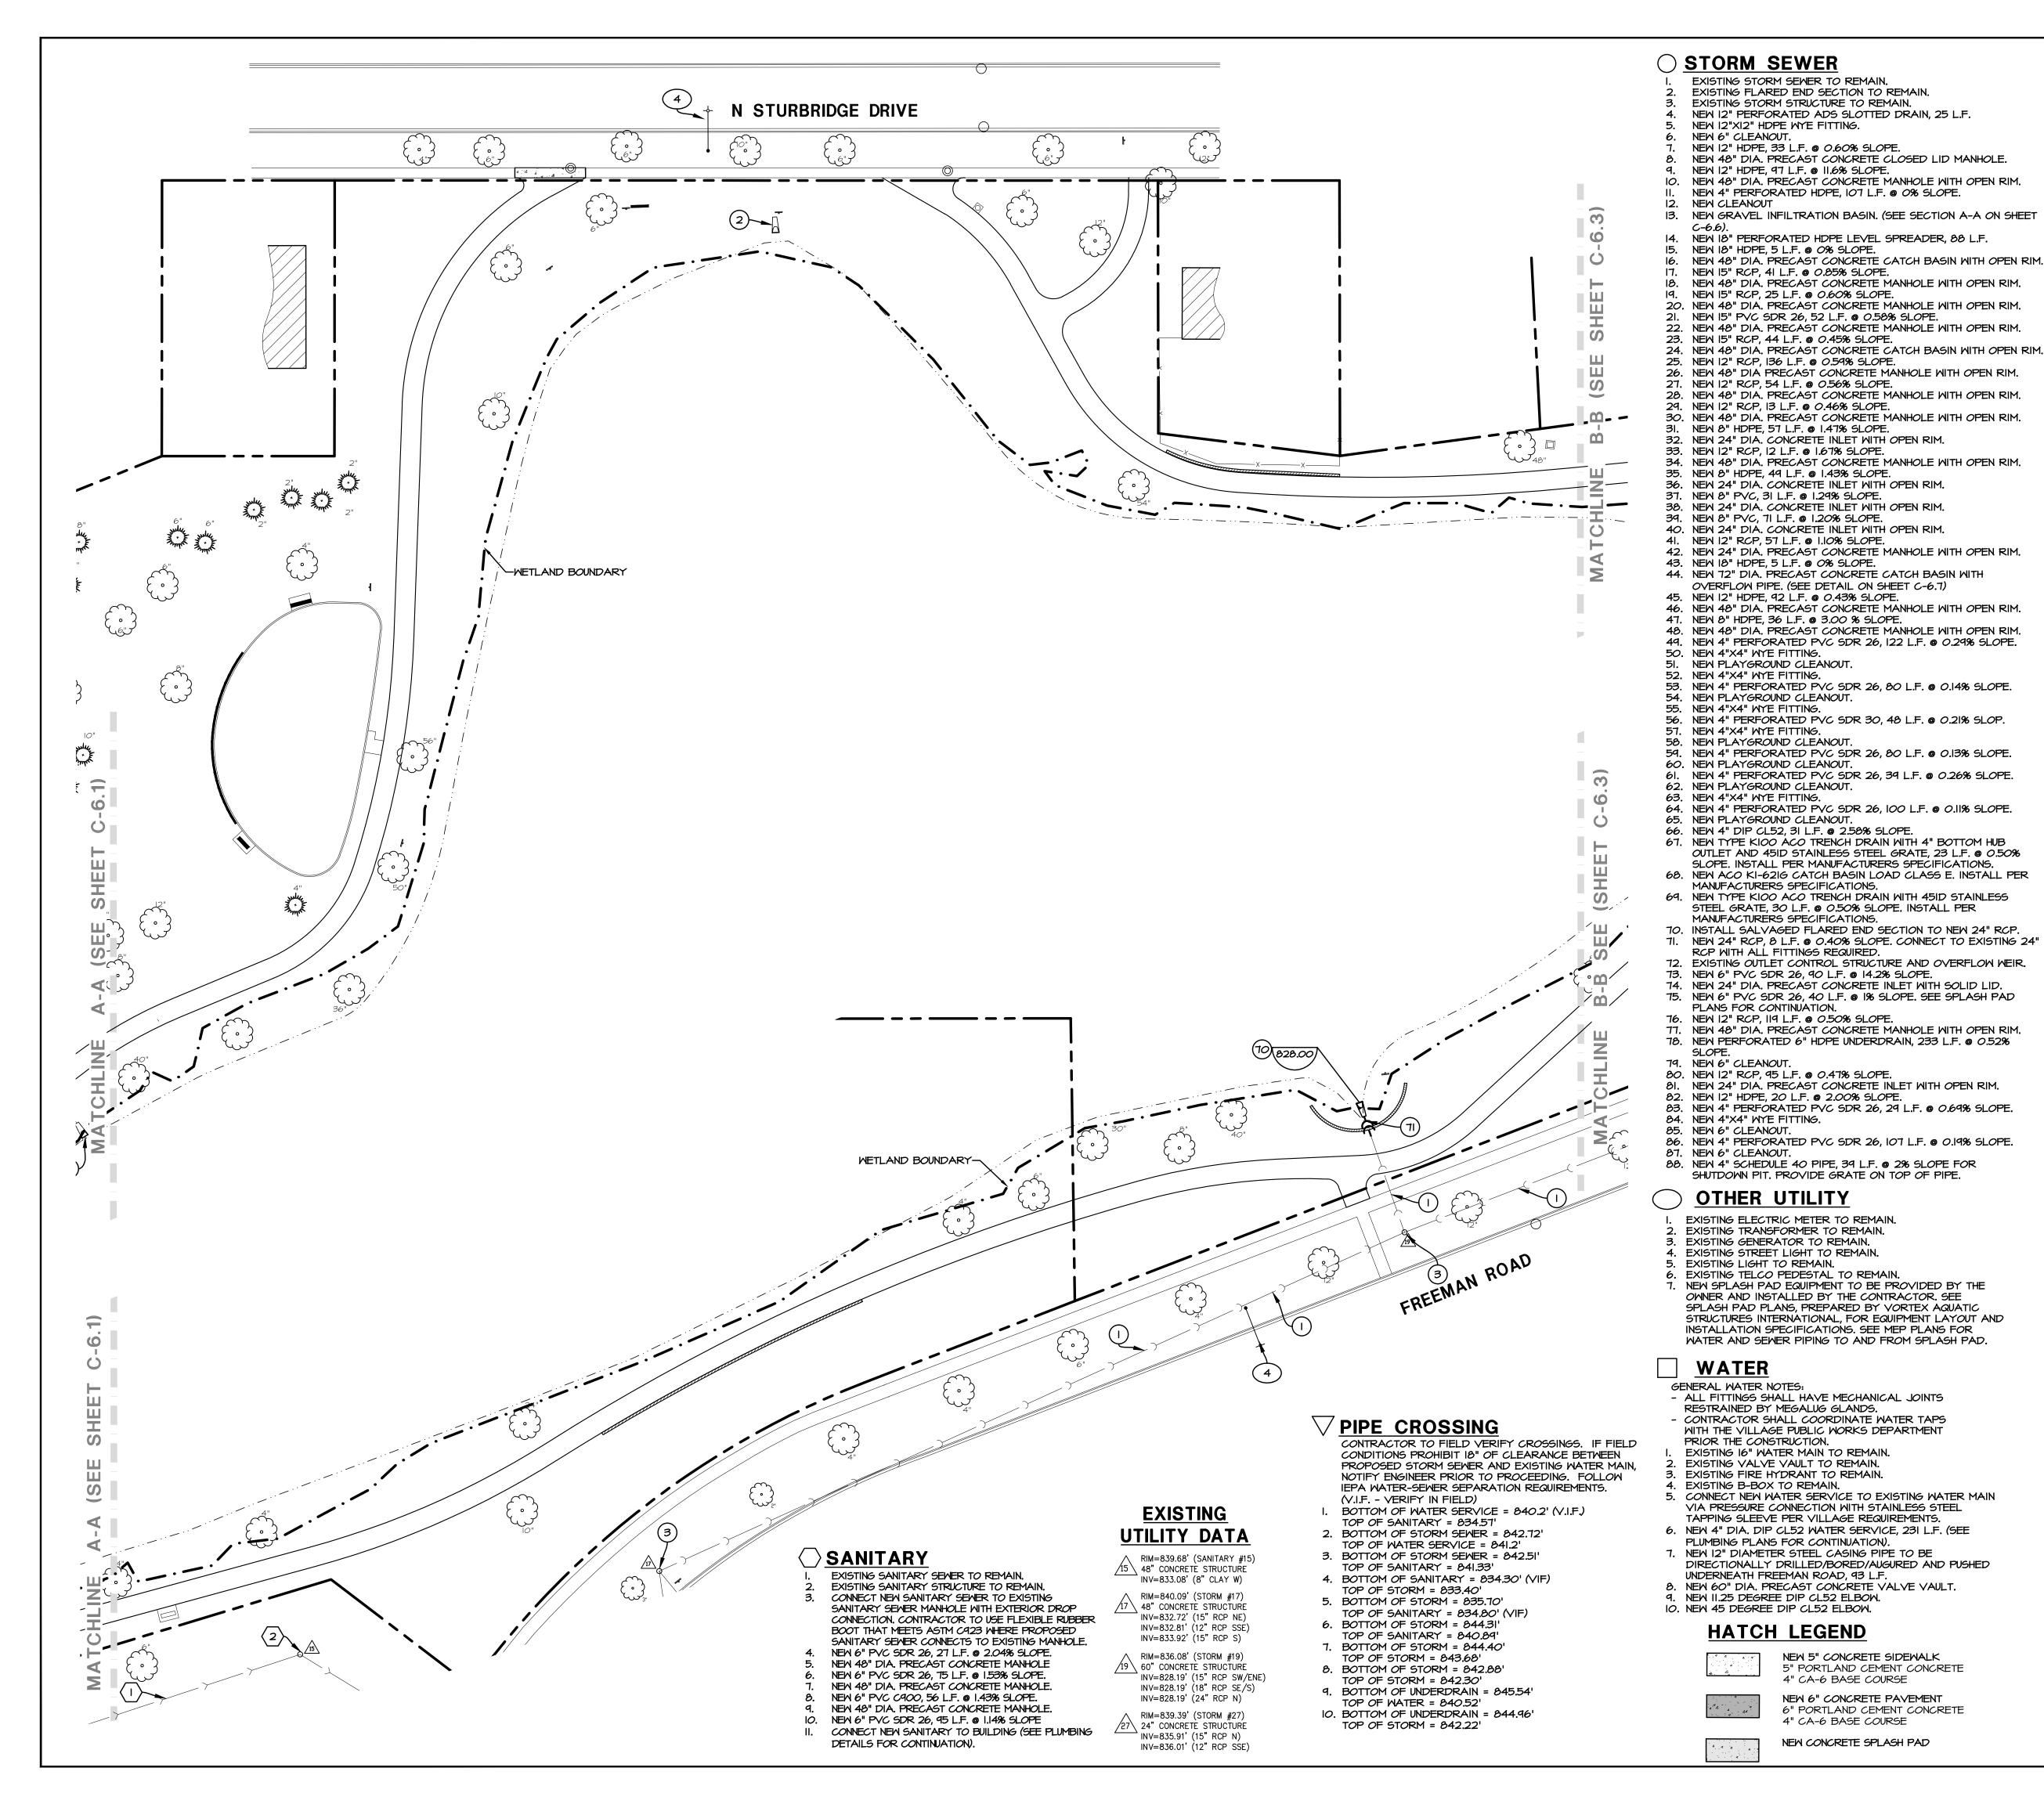

UTILITY LEGEND

PROPOSED STORM SEWER PROPOSED SANITARY SEWER PROPOSED WATER SERVICE EXISTING SANITARY SEWER EXISTING WATER MAIN EXISTING STORM SEWER EXISTING MANHOLE \bigcirc EXISTING WATER STRUCTURE EXISTING B-BOX EXISTING STREET LIGHT EXISTING FIRE HYDRANT EXISTING UTILITY POLE

> EXISTING FLARED END SECTION

EXISTING SIGN

EXISTING TREE (000.00)

PROPOSED RIM ELEVATION PROPOSED INVERT ELEVATION

FINISHED FLOOR ELEVATION ADJUST ADJUST EXISTING RIM ELEVATION

PROPOSED FIRE HYDRANT PROPOSED VALVE WITH VAULT PROPOSED B-BOX

PROPOSED INLET PROPOSED OPEN LID MANHOLE/CATCH BASIN PROPOSED CLOSED LID MANHOLE

EXISTING TELCO PEDESTAL

WETLAND BOUNDARY

SITE UTILITY NOTES:

(000.00)

A. CONTRACTOR SHALL CONTACT J.J.L.I.E. (811 OR 1-800-892-0123) AND PRIVATE LOCATING SERVICE TO LOCATE ALL UNDERGROUND UTILITY LINES PRIOR TO STARTING ANY DEMOLITION AND/OR EXCAVATION. EXACT LOCATIONS OF ANY EXISTING ELECTRIC, GAS, TELEPHONE, ETC. LINES ARE UNKNOWN.

B. CONTRACTOR TO UTILIZE CARE WHEN WORKING NEAR EXISTING UTILITIES TO REMAIN. ANY DAMAGE TO EXISTING UTILITIES NOT NOTED TO BE REMOVED SHALL BE REPAIRED AT THE CONTRACTOR'S EXPENSE AND TO THE SATISFACTION OF THE OWNER AND/OR ENGINEER

C. CONTRACTOR SHALL EXCAVATE AND VERIFY IN FIELD ALL EXISTING UTILITY LOCATIONS, SIZES, CONDITIONS AND ELEVATIONS AT PROPOSED POINTS OF CONNECTION PRIOR TO ANY UNDERGROUND CONSTRUCTION. CONTRACTOR SHALL NOTIFY THE OWNER AND ENGINEER OF ANY DISCREPANCIES OR CONFLICTS PRIOR TO PROCEEDING WITH

CONSTRUCTION. D. REFER TO THE GENERAL NOTES AND SPECIFICATION SHEETS FOR ALL PIPE MATERIAL AND JOINT SPECIFICATIONS. E. CONTRACTOR SHALL RESTORE ALL DISTURBED AREAS OUTSIDE OF

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G. THE CONTRACTOR IS RESPONSIBLE FOR THE STABILITY OF UTILITY TRENCHES DURING CONSTRUCTION AND SHALL PROVIDE TEMPORARY SHORING AND BRACING AS NECESSARY TO MAINTAIN STABILITY UNTIL CONSTRUCTION OF THE UTILITY IS COMPLETE IN ORDER TO MEET OSHA AND LOCAL CODES, AS WELL AS MANUFACTURER'S REQUIREMENTS. H. ALL RCP STORM SEWER PIPE SHALL BE REINFORCED CONCRETE PIPE,

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NECESSARY TO MEET PROPOSED FINISHED GRADE. K. CONTRACTOR TO COORDINATE ALL CONNECTIONS TO CITY UTILITIES AND STORM SEWERS WITH THE PUBLIC WORKS DEPARTMENT.

WITHIN 2 FEET OF ANY PROPOSED OR EXISTING PAVEMENT OR

L. CONTRACTOR TO USE CAUTION WHEN EXCAVATING AT EXISTING UTILITY


M. ALL STORM MANHOLES SHALL HAVE OPEN LIDS UNLESS OTHERWISE

SPECIFIED N. ALL EXISTING UTILITIES TO BE ABANDONED IN PLACE SHALL BE CAPPED WITH 2' LONG (MIN.) NON-SHRINK CONCRETE MORTAR PLUGS AT

O. CONTRACTOR TO USE FLEXIBLE RUBBER BOOT THAT MEETS ASTM C923 WHERE PROPOSED SANITARY SEMER CONNECTS TO EXISTING MANHOLE.



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HECK: CMS DRAWN: PS 1911354C

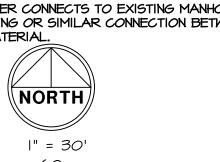VILLAGE

MWRD

MWRD

MWRD

SWCD

FOR BID

VILLAGE

8/23/19

9/17/19

10/22/19

11/25/19

1/23/20

C-6.2 SITE UTILITY PLAN



STORM SEWER

- EXISTING STORM SEWER TO REMAIN. EXISTING FLARED END SECTION TO REMAIN. EXISTING STORM STRUCTURE TO REMAIN. NEW 12" PERFORATED ADS SLOTTED DRAIN, 25 L.F.
- NEW 12"XI2" HDPE WYE FITTING. NEW 6" CLEANOUT.
- NEW 12" HDPE, 33 L.F. @ 0.60% SLOPE. NEW 48" DIA. PRECAST CONCRETE CLOSED LID MANHOLE. NEW 12" HDPE, 97 L.F. @ 11.6% SLOPE.
- IO. NEW 48" DIA. PRECAST CONCRETE MANHOLE WITH OPEN RIM. NEW 4" PERFORATED HDPE, 107 L.F. @ 0% SLOPE. 12. NEW CLEANOUT 13. NEW GRAVEL INFILTRATION BASIN. (SEE SECTION A-A ON SHEET
- 14. NEW 18" PERFORATED HDPE LEVEL SPREADER, 88 L.F.
- 15. NEW 18" HDPE, 5 L.F. @ 0% SLOPE. 16. NEW 46" DIA. PRECAST CONCRETE CATCH BASIN WITH OPEN RIM.
- 17. NEW 15" RCP, 41 L.F. @ 0.85% SLOPE. 18. NEW 48" DIA. PRECAST CONCRETE MANHOLE WITH OPEN RIM. 19. NEW 15" RCP, 25 L.F. @ 0.60% SLOPE. 20. NEW 48" DIA. PRECAST CONCRETE MANHOLE WITH OPEN RIM.
- 21. NEW 15" PVC SDR 26, 52 L.F. @ 0.58% SLOPE. 22. NEW 48" DIA. PRECAST CONCRETE MANHOLE WITH OPEN RIM. 23. NEW 15" RCP, 44 L.F. @ 0.45% SLOPE.
- 24. NEW 48" DIA. PRECAST CONCRETE CATCH BASIN WITH OPEN RIM. 25. NEW 12" RCP, 136 L.F. @ 0.59% SLOPE. 26. NEW 48" DIA PRECAST CONCRETE MANHOLE WITH OPEN RIM. 27. NEW 12" RCP, 54 L.F. @ 0.56% SLOPE.
- 28. NEW 48" DIA. PRECAST CONCRETE MANHOLE WITH OPEN RIM. 29. NEW 12" RCP, 13 L.F. @ 0.46% SLOPE. 30. NEW 48" DIA. PRECAST CONCRETE MANHOLE WITH OPEN RIM.
- 31. NEW 8" HDPE, 57 L.F. @ 1.47% SLOPE. 32. NEW 24" DIA. CONCRETE INLET WITH OPEN RIM. 33. NEW 12" RCP, 12 L.F. @ 1.67% SLOPE.
- 34. NEW 48" DIA. PRECAST CONCRETE MANHOLE WITH OPEN RIM. 35. NEW 8" HDPE, 49 L.F. @ 1.43% SLOPE. 36. NEW 24" DIA. CONCRETE INLET WITH OPEN RIM.
- 37. NEW 8" PVC, 31 L.F. @ 1.29% SLOPE. 38. NEW 24" DIA. CONCRETE INLET WITH OPEN RIM. 39. NEW 8" PVC, 71 L.F. @ 1.20% SLOPE.
- 40. NEW 24" DIA. CONCRETE INLET WITH OPEN RIM. 41. NEW 12" RCP, 57 L.F. @ 1.10% SLOPE. 42. NEW 24" DIA. PRECAST CONCRETE MANHOLE WITH OPEN RIM.
- 43. NEW 18" HDPE, 5 L.F. @ 0% SLOPE. 44. NEW 72" DIA. PRECAST CONCRETE CATCH BASIN WITH OVERFLOW PIPE. (SEE DETAIL ON SHEET C-6.7)
- 45. NEW 12" HDPE, 92 L.F. @ 0.43% SLOPE. 46. NEW 48" DIA. PRECAST CONCRETE MANHOLE WITH OPEN RIM. 47. NEW 8" HDPE, 36 L.F. @ 3.00 % SLOPE. 48. NEW 48" DIA. PRECAST CONCRETE MANHOLE WITH OPEN RIM.
- 49. NEW 4" PERFORATED PVC SDR 26, 122 L.F. @ 0.29% SLOPE. 50. NEW 4"X4" MYE FITTING. 51. NEW PLAYGROUND CLEANOUT. 52. NEW 4"X4" MYE FITTING.
- 53. NEW 4" PERFORATED PVC SDR 26, 80 L.F. @ 0.14% SLOPE. 54. NEW PLAYGROUND CLEANOUT. 55. NEW 4"X4" MYE FITTING
- 56. NEW 4" PERFORATED PVC SDR 30, 48 L.F. @ 0.21% SLOP. 57. NEW 4"X4" MYE FITTING. 58. NEW PLAYGROUND CLEANOUT.
- 59. NEW 4" PERFORATED PVC SDR 26, 80 L.F. @ 0.13% SLOPE. 60. NEW PLAYGROUND CLEANOUT. 61. NEW 4" PERFORATED PVC SDR 26, 39 L.F. @ 0.26% SLOPE.
- 62. NEW PLAYGROUND CLEANOUT. 63. NEW 4"X4" MYE FITTING. 64. NEW 4" PERFORATED PVC SDR 26, 100 L.F. @ 0.11% SLOPE.
- 65. NEW PLAYGROUND CLEANOUT. 66. NEW 4" DIP CL52, 31 L.F. @ 2.58% SLOPE. 67. NEW TYPE KIOO ACO TRENCH DRAIN WITH 4" BOTTOM HUB OUTLET AND 45ID STAINLESS STEEL GRATE, 23 L.F. @ 0.50% SLOPE. INSTALL PER MANUFACTURERS SPECIFICATIONS.
- 68. NEW ACO KI-62IG CATCH BASIN LOAD CLASS E. INSTALL PER MANUFACTURERS SPECIFICATIONS. 69. NEW TYPE KIOO ACO TRENCH DRAIN WITH 45ID STAINLESS STEEL GRATE, 30 L.F. @ 0.50% SLOPE. INSTALL PER
- MANUFACTURERS SPECIFICATIONS. 70. INSTALL SALVAGED FLARED END SECTION TO NEW 24" RCP. 71. NEW 24" RCP, 8 L.F. @ 0.40% SLOPE. CONNECT TO EXISTING 24" RCP WITH ALL FITTINGS REQUIRED
- 72. EXISTING OUTLET CONTROL STRUCTURE AND OVERFLOW WEIR. 73. NEW 6" PVC SDR 26, 90 L.F. @ 14.2% SLOPE. 74. NEW 24" DIA. PRECAST CONCRETE INLET WITH SOLID LID.
- 75. NEW 6" PVC SDR 26, 40 L.F. @ 1% SLOPE. SEE SPLASH PAD PLANS FOR CONTINUATION. 76. NEW 12" RCP, 119 L.F. @ 0.50% SLOPE. 77. NEW 48" DIA. PRECAST CONCRETE MANHOLE WITH OPEN RIM.
- 18. NEW PERFORATED 6" HDPE UNDERDRAIN, 233 L.F. @ 0.52% 79. NEW 6" CLEANOUT. 80. NEW 12" RCP, 95 L.F. @ 0.47% SLOPE.
- 81. NEW 24" DIA. PRECAST CONCRETE INLET WITH OPEN RIM. 82. NEW 12" HDPE, 20 L.F. @ 2.00% SLOPE. 83. NEW 4" PERFORATED PVC SDR 26, 29 L.F. @ 0.69% SLOPE.
- 84. NEW 4"X4" MYE FITTING. 85. NEW 6" CLEANOUT. 86. NEW 4" PERFORATED PVC SDR 26, 107 L.F. @ 0.19% SLOPE. 87. NEW 6" CLEANOUT.
- 88. NEW 4" SCHEDULE 40 PIPE, 39 L.F. @ 2% SLOPE FOR SHUTDOWN PIT. PROVIDE GRATE ON TOP OF PIPE.

OTHER UTILITY

- EXISTING ELECTRIC METER TO REMAIN. 2. EXISTING TRANSFORMER TO REMAIN. 3. EXISTING GENERATOR TO REMAIN. EXISTING STREET LIGHT TO REMAIN. EXISTING LIGHT TO REMAIN. 6. EXISTING TELCO PEDESTAL TO REMAIN.
- 7. NEW SPLASH PAD EQUIPMENT TO BE PROVIDED BY THE OWNER AND INSTALLED BY THE CONTRACTOR. SEE SPLASH PAD PLANS, PREPARED BY VORTEX AQUATIC STRUCTURES INTERNATIONAL, FOR EQUIPMENT LAYOUT AND INSTALLATION SPECIFICATIONS, SEE MEP PLANS FOR WATER AND SEWER PIPING TO AND FROM SPLASH PAD.

WATER

- GENERAL WATER NOTES: - ALL FITTINGS SHALL HAVE MECHANICAL JOINTS RESTRAINED BY MEGALUG GLANDS. - CONTRACTOR SHALL COORDINATE WATER TAPS WITH THE VILLAGE PUBLIC WORKS DEPARTMENT
- PRIOR THE CONSTRUCTION. EXISTING 16" WATER MAIN TO REMAIN. 2. EXISTING VALVE VAULT TO REMAIN.
- 3. EXISTING FIRE HYDRANT TO REMAIN. 4. EXISTING B-BOX TO REMAIN. 5. CONNECT NEW WATER SERVICE TO EXISTING WATER MAIN VIA PRESSURE CONNECTION WITH STAINLESS STEEL
- 6. NEW 4" DIA. DIP CL52 WATER SERVICE, 231 L.F. (SEE PLUMBING PLANS FOR CONTINUATION). 7. NEW 12" DIAMETER STEEL CASING PIPE TO BE DIRECTIONALLY DRILLED/BORED/AUGURED AND PUSHED

TAPPING SLEEVE PER VILLAGE REQUIREMENTS.

- UNDERNEATH FREEMAN ROAD, 93 L.F. 8. NEW 60" DIA. PRECAST CONCRETE VALVE VAULT.
- 1. NEW II.25 DEGREE DIP CL52 ELBOW.
- IO. NEW 45 DEGREE DIP CL52 ELBOW.

TOP OF WATER = 840.52'

TOP OF STORM = 842.22'

10. BOTTOM OF UNDERDRAIN = 844,96'



ENF 14

VILLAGE

MWRD

MWRD

MWRD

SWCD

FOR BID

VILLAGE

8/23/19

9/17/19

10/22/19

11/25/19

1/2/20

1/17/20

1/23/20



UTILITY LEGEND

PROPOSED SANITARY SEWER PROPOSED WATER SERVICE EXISTING SANITARY SEWER EXISTING WATER MAIN — VM — VM — VM — EXISTING STORM SEWER EXISTING MANHOLE \odot EXISTING WATER STRUCTURE EXISTING B-BOX

PROPOSED STORM SEWER

EXISTING STREET LIGHT EXISTING FIRE HYDRANT EXISTING UTILITY POLE

> EXISTING SIGN EXISTING FLARED END SECTION

EXISTING TREE

PROPOSED RIM ELEVATION

(00.00) PROPOSED INVERT ELEVATION FINISHED FLOOR ELEVATION

ADJUST EXISTING RIM ELEVATION ADJUST PROPOSED FIRE HYDRANT

PROPOSED VALVE WITH VAULT PROPOSED B-BOX

PROPOSED INLET PROPOSED OPEN LID MANHOLE/CATCH BASIN

PROPOSED CLOSED LID MANHOLE EXISTING TELCO PEDESTAL

WETLAND BOUNDARY

SITE UTILITY NOTES:

(000.00)

- A. CONTRACTOR SHALL CONTACT J.U.L.I.E. (811 OR 1-800-892-0123) AND PRIVATE LOCATING SERVICE TO LOCATE ALL UNDERGROUND UTILITY LINES PRIOR TO STARTING ANY DEMOLITION AND/OR EXCAVATION. EXACT LOCATIONS OF ANY EXISTING ELECTRIC, GAS, TELEPHONE, ETC. LINES ARE UNKNOWN.
- B. CONTRACTOR TO UTILIZE CARE WHEN WORKING NEAR EXISTING UTILITIES TO REMAIN. ANY DAMAGE TO EXISTING UTILITIES NOT NOTED TO BE REMOVED SHALL BE REPAIRED AT THE CONTRACTOR'S EXPENSE AND TO THE SATISFACTION OF THE OWNER AND/OR ENGINEER.
- C. CONTRACTOR SHALL EXCAVATE AND VERIFY IN FIELD ALL EXISTING UTILITY LOCATIONS, SIZES, CONDITIONS AND ELEVATIONS AT PROPOSED POINTS OF CONNECTION PRIOR TO ANY UNDERGROUND CONSTRUCTION. CONTRACTOR SHALL NOTIFY THE OWNER AND ENGINEER OF ANY DISCREPANCIES OR CONFLICTS PRIOR TO PROCEEDING WITH
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- G. THE CONTRACTOR IS RESPONSIBLE FOR THE STABILITY OF UTILITY TRENCHES DURING CONSTRUCTION AND SHALL PROVIDE TEMPORARY SHORING AND BRACING AS NECESSARY TO MAINTAIN STABILITY UNTIL CONSTRUCTION OF THE UTILITY IS COMPLETE IN ORDER TO MEET OSHA AND LOCAL CODES, AS WELL AS MANUFACTURER'S REQUIREMENTS. H. ALL RCP STORM SEWER PIPE SHALL BE REINFORCED CONCRETE PIPE,
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- SIDEWALKS IN ACCORDANCE WITH THE STANDARD SPECIFICATIONS FOR ROAD AND BRIDGE CONSTRUCTION.

WITHIN 2 FEET OF ANY PROPOSED OR EXISTING PAVEMENT OR

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- L. CONTRACTOR TO USE CAUTION WHEN EXCAVATING AT EXISTING UTILITY
- M. ALL STORM MANHOLES SHALL HAVE OPEN LIDS UNLESS OTHERWISE
- N. ALL EXISTING UTILITIES TO BE ABANDONED IN PLACE SHALL BE CAPPED WITH 2' LONG (MIN.) NON-SHRINK CONCRETE MORTAR PLUGS AT
- O. CONTRACTOR TO USE FLEXIBLE RUBBER BOOT THAT MEETS ASTM C923 WHERE PROPOSED SANITARY SEWER CONNECTS TO EXISTING MANHOLE. P. PROVIDE RUBBER MISSION COUPLING OR SIMILAR CONNECTION BETWEEN




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HECK: CMS

C-6.3 SITE UTILITY PLAN



LOCATION KEYMAP SCALE: N.T.S. UTILITY LEGEND PROPOSED STORM SEWER

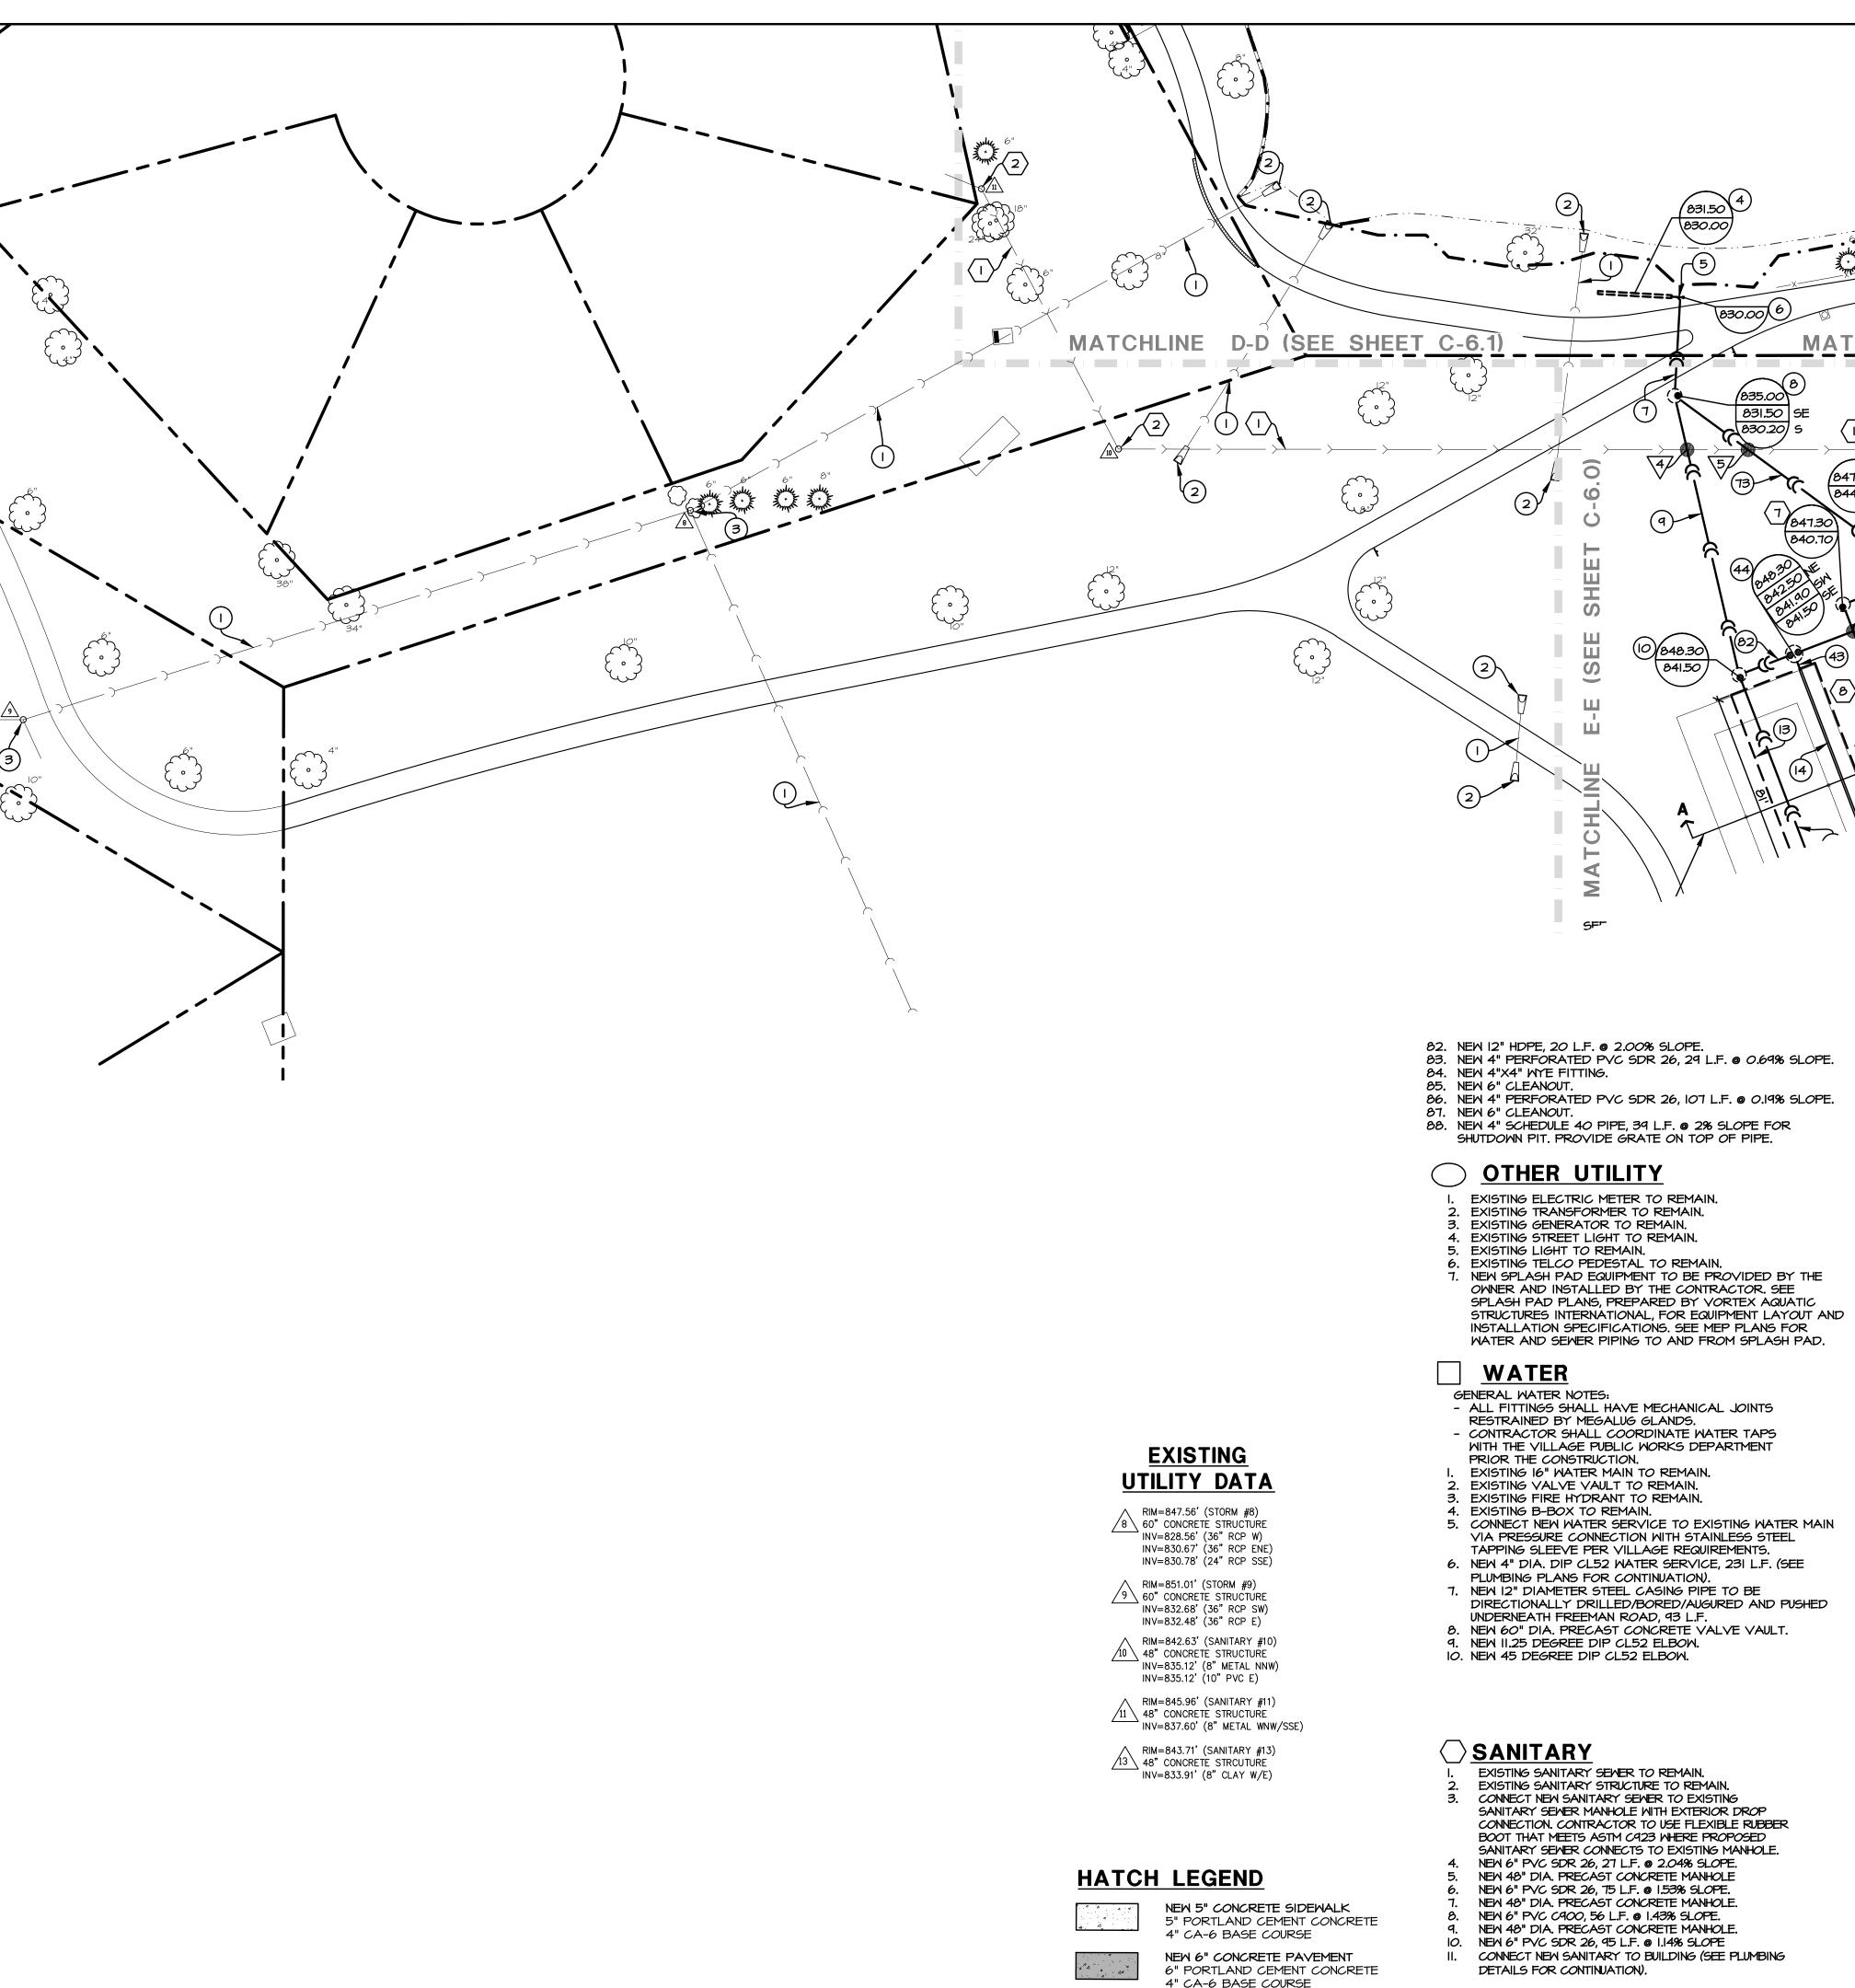OUT ENF

-WETLAND BOUNDARY

NE 846.00

STORM SEWER

NEW 6" CLEANOUT.

12. NEW CLEANOUT

EXISTING STORM SEWER TO REMAIN.

NEW 12"XI2" HDPE WYE FITTING.

EXISTING FLARED END SECTION TO REMAIN

NEW 12" PERFORATED ADS SLOTTED DRAIN, 25 L.F.

NEW 48" DIA. PRECAST CONCRETE CLOSED LID MANHOLE.

10. NEW 48" DIA. PRECAST CONCRETE MANHOLE WITH OPEN RIM. NEW 4" PERFORATED HDPE, IOT L.F. @ 0% SLOPE.

NEW 18" PERFORATED HDPE LEVEL SPREADER, 88 L.F.

18. NEW 48" DIA. PRECAST CONCRETE MANHOLE WITH OPEN RIM.

20. NEW 48" DIA. PRECAST CONCRETE MANHOLE WITH OPEN RIM.

22. NEW 48" DIA. PRECAST CONCRETE MANHOLE WITH OPEN RIM.

26. NEW 48" DIA PRECAST CONCRETE MANHOLE WITH OPEN RIM.

28. NEW 48" DIA. PRECAST CONCRETE MANHOLE WITH OPEN RIM.

30. NEW 48" DIA. PRECAST CONCRETE MANHOLE WITH OPEN RIM.

34. NEW 48" DIA. PRECAST CONCRETE MANHOLE WITH OPEN RIM.

42. NEW 24" DIA. PRECAST CONCRETE MANHOLE WITH OPEN RIM.

46. NEW 48" DIA. PRECAST CONCRETE MANHOLE WITH OPEN RIM.

48. NEW 48" DIA. PRECAST CONCRETE MANHOLE WITH OPEN RIM.

49. NEW 4" PERFORATED PVC SDR 26, 122 L.F. @ 0.29% SLOPE.

53. NEW 4" PERFORATED PVC SDR 26, 80 L.F. @ 0.14% SLOPE.

56. NEW 4" PERFORATED PVC SDR 30, 48 L.F. @ 0.21% SLOP.

59. NEW 4" PERFORATED PVC SDR 26, 80 L.F. @ 0.13% SLOPE.

61. NEW 4" PERFORATED PVC SDR 26, 39 L.F. @ 0.26% SLOPE.

64. NEW 4" PERFORATED PVC SDR 26, 100 L.F. @ O.11% SLOPE.

67. NEW TYPE KIOO ACO TRENCH DRAIN WITH 4" BOTTOM HUB

69. NEW TYPE KIOO ACO TRENCH DRAIN WITH 45ID STAINLESS

STEEL GRATE, 30 L.F. @ 0.50% SLOPE. INSTALL PER

70. INSTALL SALVAGED FLARED END SECTION TO NEW 24" RCP.

72. EXISTING OUTLET CONTROL STRUCTURE AND OVERFLOW WEIR.

74. NEW 24" DIA. PRECAST CONCRETE INLET WITH SOLID LID.

75. NEW 6" PVC SDR 26, 40 L.F. @ 1% SLOPE. SEE SPLASH PAD

71. NEW 24" RCP, 8 L.F. @ 0.40% SLOPE. CONNECT TO EXISTING 24"

SLOPE. INSTALL PER MANUFACTURERS SPECIFICATIONS.

68. NEW ACO KI-62IG CATCH BASIN LOAD CLASS E. INSTALL PER

OUTLET AND 45ID STAINLESS STEEL GRATE, 23 L.F. @ 0.50%

44. NEW 72" DIA. PRECAST CONCRETE CATCH BASIN WITH

OVERFLOW PIPE. (SEE DETAIL ON SHEET C-6.7)

24. NEW 48" DIA. PRECAST CONCRETE CATCH BASIN WITH OPEN RIM.

13. NEW GRAVEL INFILTRATION BASIN. (SEE SECTION A-A ON SHEET

NEW 48" DIA, PRECAST CONCRETE CATCH BASIN WITH OPEN RIM.

EXISTING STORM STRUCTURE TO REMAIN.

NEW 12" HDPE, 33 L.F. @ 0.60% SLOPE.

NEW 12" HDPE, 97 L.F. @ 11.6% SLOPE.

NEW 18" HDPE, 5 L.F. @ 0% SLOPE.

17. NEW 15" RCP, 41 L.F. @ 0.85% SLOPE.

19. NEW 15" RCP, 25 L.F. @ 0.60% SLOPE.

23. NEW 15" RCP, 44 L.F. @ 0.45% SLOPE

25. NEW 12" RCP, 136 L.F. @ 0.59% SLOPE.

27. NEW 12" RCP, 54 L.F. @ 0.56% SLOPE.

29. NEW 12" RCP, 13 L.F. @ 0.46% SLOPE.

31. NEW 8" HDPE, 57 L.F. @ 1.47% SLOPE.

33. NEW 12" RCP, 12 L.F. @ 1.67% SLOPE.

35. NEW 8" HDPE, 49 L.F. @ 1.43% SLOPE.

37. NEW 8" PVC, 31 L.F. @ 1.29% SLOPE.

39. NEW 8" PVC, 71 L.F. @ 1.20% SLOPE.

41. NEW 12" RCP, 57 L.F. @ 1.10% SLOPE.

45. NEW 12" HDPE, 92 L.F. @ 0.43% SLOPE.

47. NEW 8" HDPE, 36 L.F. @ 3.00 % SLOPE.

43. NEW 18" HDPE, 5 L.F. @ 0% SLOPE.

50. NEW 4"X4" MYE FITTING.

52. NEW 4"X4" MYE FITTING.

55. NEW 4"X4" WYE FITTING

57. NEW 4"X4" MYE FITTING

63. NEW 4"X4" MYE FITTING.

51. NEW PLAYGROUND CLEANOUT

54. NEW PLAYGROUND CLEANOUT.

58. NEW PLAYGROUND CLEANOUT.

60. NEW PLAYGROUND CLEANOUT.

62. NEW PLAYGROUND CLEANOUT.

65. NEW PLAYGROUND CLEANOUT.

66. NEW 4" DIP CL52, 31 L.F. @ 2.58% SLOPE.

MANUFACTURERS SPECIFICATIONS.

MANUFACTURERS SPECIFICATIONS.

RCP WITH ALL FITTINGS REQUIRED

73. NEW 6" PVC SDR 26, 90 L.F. @ 14.2% SLOPE.

21. NEW 15" PVC SDR 26, 52 L.F. @ 0.58% SLOPE.

32. NEW 24" DIA. CONCRETE INLET WITH OPEN RIM.

36. NEW 24" DIA. CONCRETE INLET WITH OPEN RIM.

38. NEW 24" DIA. CONCRETE INLET WITH OPEN RIM.

40. NEW 24" DIA. CONCRETE INLET WITH OPEN RIM.

PROPOSED WATER SERVICE EXISTING SANITARY SEWER EXISTING WATER MAIN EXISTING STORM SEWER EXISTING MANHOLE \odot EXISTING WATER STRUCTURE EXISTING B-BOX EXISTING STREET LIGHT EXISTING FIRE HYDRANT EXISTING UTILITY POLE EXISTING SIGN EXISTING FLARED END SECTION EXISTING TREE PROPOSED RIM ELEVATION 000.00 000.00 PROPOSED INVERT ELEVATION FINISHED FLOOR ELEVATION **ADJUST** ADJUST EXISTING RIM ELEVATION PROPOSED FIRE HYDRANT PROPOSED VALVE WITH VAULT PROPOSED B-BOX PROPOSED INLET PROPOSED OPEN LID MANHOLE/CATCH BASIN PROPOSED CLOSED LID MANHOLE

PROPOSED SANITARY SEWER

SITE UTILITY NOTES:

A. CONTRACTOR SHALL CONTACT JULLIE. (811 OR 1-800-892-0123) AND PRIVATE LOCATING SERVICE TO LOCATE ALL UNDERGROUND UTILITY LINES PRIOR TO STARTING ANY DEMOLITION AND/OR EXCAVATION. EXACT LOCATIONS OF ANY EXISTING ELECTRIC, GAS, TELEPHONE, ETC. LINES ARE UNKNOWN.

B. CONTRACTOR TO UTILIZE CARE WHEN WORKING NEAR EXISTING UTILITIES TO REMAIN. ANY DAMAGE TO EXISTING UTILITIES NOT NOTED TO BE REMOVED SHALL BE REPAIRED AT THE CONTRACTOR'S EXPENSE AND

EXISTING TELCO PEDESTAL

WETLAND BOUNDARY

TO THE SATISFACTION OF THE OWNER AND/OR ENGINEER. C. CONTRACTOR SHALL EXCAVATE AND VERIFY IN FIELD ALL EXISTING UTILITY LOCATIONS, SIZES, CONDITIONS AND ELEVATIONS AT PROPOSED POINTS OF CONNECTION PRIOR TO ANY UNDERGROUND CONSTRUCTION. CONTRACTOR SHALL NOTIFY THE OWNER AND ENGINEER OF ANY DISCREPANCIES OR CONFLICTS PRIOR TO PROCEEDING WITH

CONSTRUCTION. D. REFER TO THE GENERAL NOTES AND SPECIFICATION SHEETS FOR ALL PIPE MATERIAL AND JOINT SPECIFICATIONS.

E. CONTRACTOR SHALL RESTORE ALL DISTURBED AREAS OUTSIDE OF CONSTRUCTION LIMITS TO ORIGINAL CONDITION OR BETTER.

F. CONTRACTOR SHALL VERIFY IN FIELD EXACT SIZE, MATERIAL, INVERT, PIPE ROUTING, AND SLOPE OF ALL EXISTING UTILITIES AND NOTIFY THE OWNER AND ENGINEER OF ANY DISCREPANCIES OR CONFLICTS PRIOR TO CONSTRUCTION. G. THE CONTRACTOR IS RESPONSIBLE FOR THE STABILITY OF UTILITY

TRENCHES DURING CONSTRUCTION AND SHALL PROVIDE TEMPORARY SHORING AND BRACING AS NECESSARY TO MAINTAIN STABILITY UNTIL CONSTRUCTION OF THE UTILITY IS COMPLETE IN ORDER TO MEET OSHA AND LOCAL CODES, AS WELL AS MANUFACTURER'S REQUIREMENTS. H. ALL RCP STORM SEMER PIPE SHALL BE REINFORCED CONCRETE PIPE, CLASS IV, PER ASTM C-76 WITH FLEXIBLE (O-RING) GASKET JOINTS IN CONFORMANCE WITH ASTM C-443 AND SECTION 31-1.08 OF THE "STANDARD SPECIFICATIONS".

TRENCH BACKFILL MATERIAL SHALL BE PLACED AND COMPACTED TO A MINIMUM OF 95% MODIFIED PROCTOR DENSITY (ASTM D-1557) OVER ALL UNDERGROUND UTILITIES WHICH ARE CONSTRUCTED UNDER OR WITHIN 2 FEET OF ANY PROPOSED OR EXISTING PAVEMENT OR SIDEWALKS IN ACCORDANCE WITH THE STANDARD SPECIFICATIONS FOR

ROAD AND BRIDGE CONSTRUCTION.

J. ADJUST RIM ELEVATIONS OF EXISTING STRUCTURES IN PAVEMENT AS NECESSARY TO MEET PROPOSED FINISHED GRADE. K. CONTRACTOR TO COORDINATE ALL CONNECTIONS TO CITY UTILITIES

AND STORM SEWERS WITH THE PUBLIC WORKS DEPARTMENT. CONTRACTOR TO USE CAUTION WHEN EXCAVATING AT EXISTING UTILITY

M. ALL STORM MANHOLES SHALL HAVE OPEN LIDS UNLESS OTHERWISE

SPECIFIED. N. ALL EXISTING UTILITIES TO BE ABANDONED IN PLACE SHALL BE CAPPED WITH 2' LONG (MIN.) NON-SHRINK CONCRETE MORTAR PLUGS AT

BOTH ENDS. O. CONTRACTOR TO USE FLEXIBLE RUBBER BOOT THAT MEETS ASTM C923 WHERE PROPOSED SANITARY SEWER CONNECTS TO EXISTING MANHOLE.

P. PROVIDE RUBBER MISSION COUPLING OR SIMILAR CONNECTION BETWEEN PIPES OF DISSIMILAR SIZE OR MATERIAL

I" = 30' 60

 \bigcirc SANITARY

EXISTING SANITARY SEMER TO REMAIN. EXISTING SANITARY STRUCTURE TO REMAIN. CONNECT NEW SANITARY SEMER TO EXISTING SANITARY SEWER MANHOLE WITH EXTERIOR DROP CONNECTION. CONTRACTOR TO USE FLEXIBLE RUBBER BOOT THAT MEETS ASTM C923 WHERE PROPOSED SANITARY SEWER CONNECTS TO EXISTING MANHOLE. NEW 6" PVC SDR 26, 27 L.F. @ 2.04% SLOPE. NEW 48" DIA. PRECAST CONCRETE MANHOLE

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831.50

NEW 6" PVC C900, 56 L.F. @ 1.43% SLOPE. NEW 48" DIA. PRECAST CONCRETE MANHOLE. 10. NEW 6" PVC SDR 26, 95 L.F. @ 1.14% SLOPE

II. CONNECT NEW SANITARY TO BUILDING (SEE PLUMBING DETAILS FOR CONTINUATION).

NEW CONCRETE SPLASH PAD

NEW 6" PVC SDR 26, 75 L.F. @ 1.53% SLOPE. NEW 48" DIA. PRECAST CONCRETE MANHOLE.

PLANS FOR CONTINUATION. 76. NEW 12" RCP, 119 L.F. @ 0.50% SLOPE. 77. NEW 48" DIA. PRECAST CONCRETE MANHOLE WITH OPEN RIM. 78. NEW PERFORATED 6" HDPE UNDERDRAIN, 233 L.F. @ 0.52% SI OPF.

79. NEW 6" CLEANOUT. 80. NEW 12" RCP, 95 L.F. @ 0.47% SLOPE. 81. NEW 24" DIA. PRECAST CONCRETE INLET WITH OPEN RIM.

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SITE UTILITY PLAN

ISSUE

8/23/19

9/17/19

10/22/19

11/25/19

1/2/20

1/17/20

1/23/20

HECK: CMS

DRAWN: PS

VILLAGE

MWRD

MWRD

MWRD

SWCD

FOR BID

VILLAGE

