

**M** PRAIRIE STONE SPORTS & WELLNESS CENTER NATATORIUM HVAC UNITS REPLACEMENT

HOFFMAN ESTATES, ILLINOIS

REVISIONS ISSUED FOR BIDS

SHEET TILE.

MECHANICAL FLOOR
PLAN - DEMOLITION

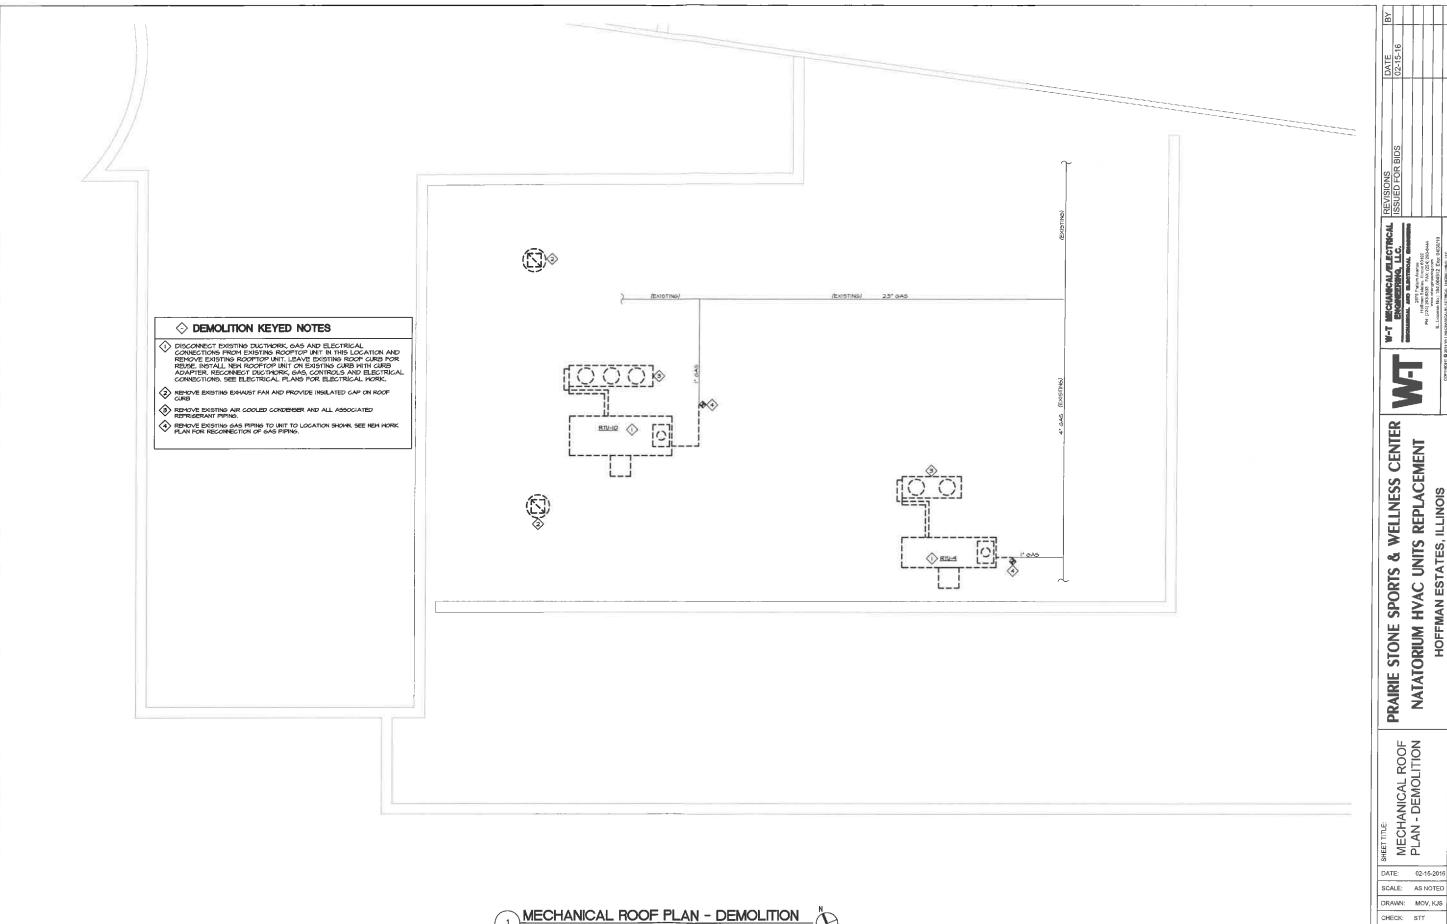
DATE: 02-15-2016 SCALE: AS NOTED DRAWN: MOV, KJS CHECK: STT JOB: M15420

SHEET

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MD-1

MECHANICAL FLOOR PLAN - DEMOLITION SCALE: 1/8"=1'-0"

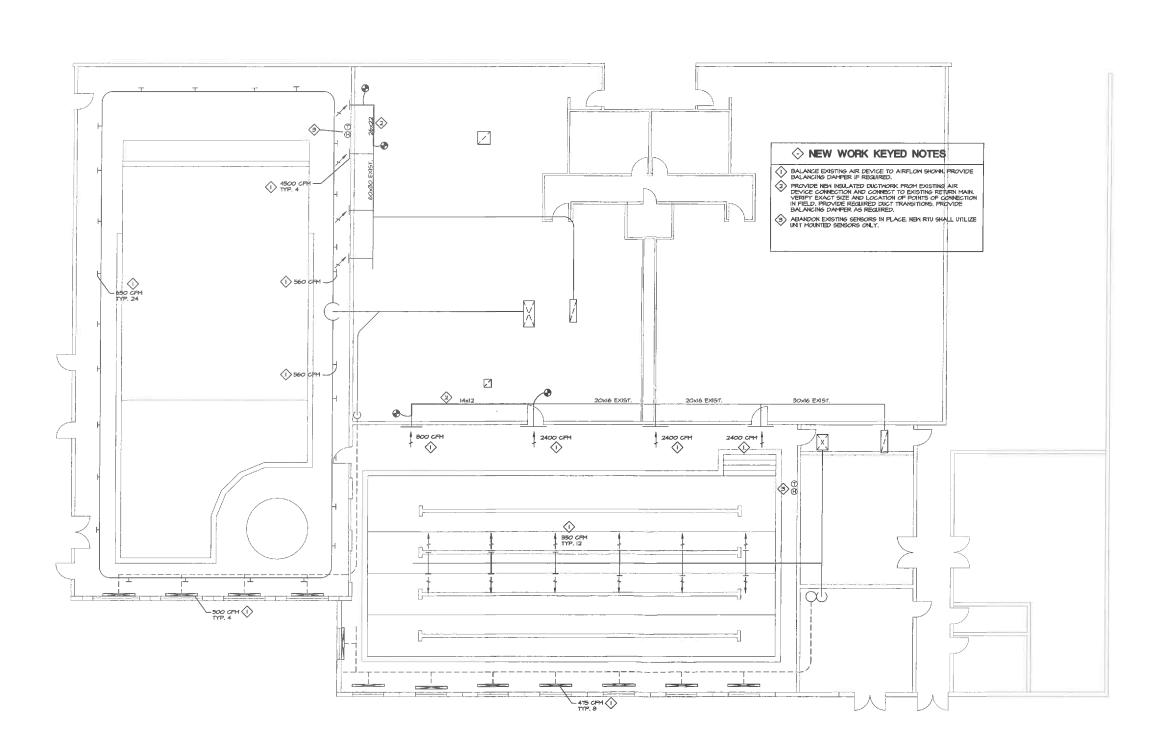


SCALE: 1/8"=1'-0"

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SHEET

MD-2



M PRAIRIE STONE SPORTS & WELLNESS CENTER NATATORIUM HVAC UNITS REPLACEMENT

HOFFMAN ESTATES, ILLINOIS

SHEET TILE:
MECHANICAL FLOOR
PLAN - NEW WORK

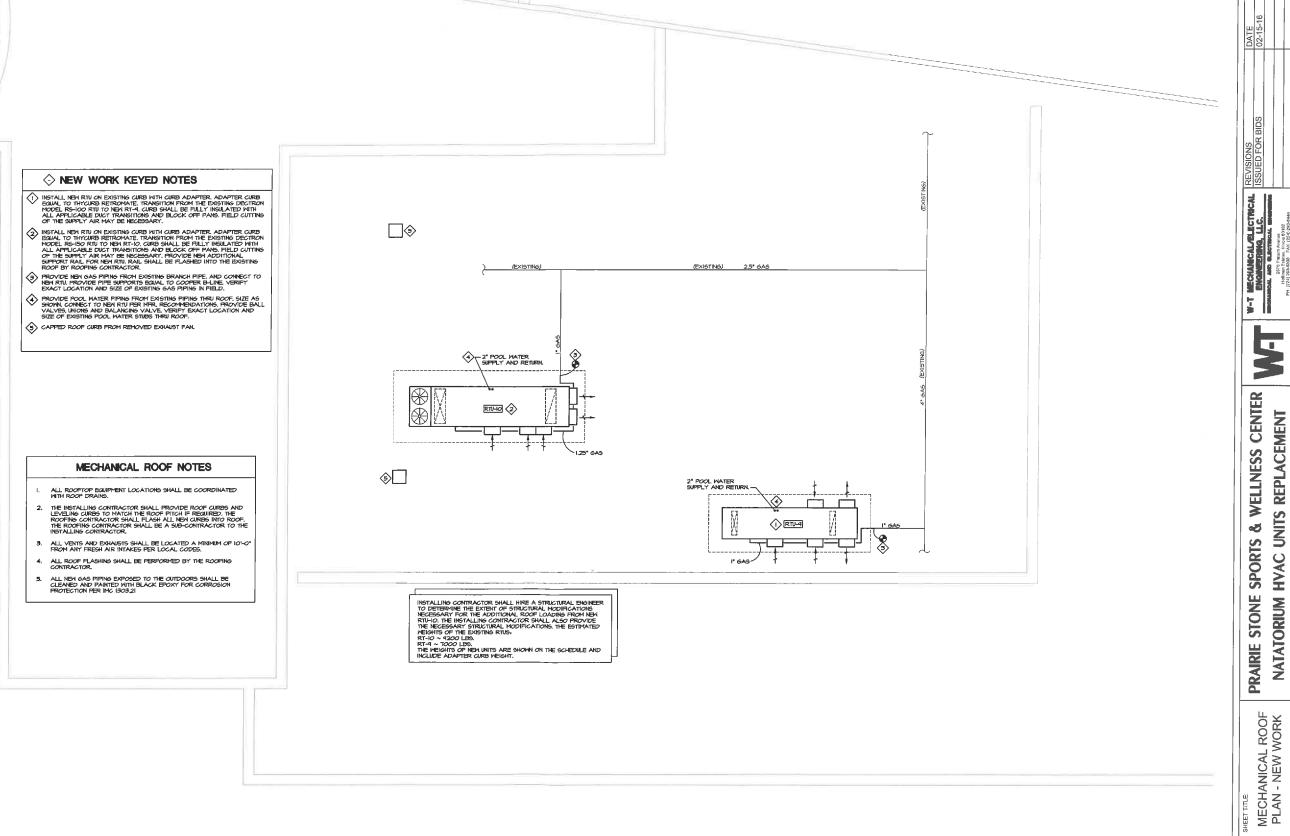
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MECHANICAL FLOOR PLAN - NEW WORK SCALE: 1/8"=1'-0"



MECHANICAL ROOF PLAN - NEW WORK SCALE: 1/8"=1"-0"

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NATATORIUM HVAC UNITS REPLACEMENT

JOB: M15420 SHEET

M-2

																POOL HEA	TING	3 /	COOL	NG /	AND	DEH	UMIDIFICA	ATIO	V UNI	T S	CHED	ULE							-				
ITEM	MANUFACTURER AND		SUPPL	Y FAN.		м	INIMUM I	EXHAUST	FAN	PUR	RGE EXH	AUST F	AN		REFR	IGERATION SYSTEM					F	HOT GAS	REHEAT COIL	HE/	TING		HE	EAT RECOVERY			Pool	. WATER HEA	NTER		ELECTRIC	AL DAT	A	UNIT WEIGHT WITH CURB	OD H Dire
TAG	MODEL NUMBER	CFM	ESP	HP	RPM	CFM	ESP	HP	RPM	CFM	ESP	HP I	RPM	NO. OF C	TONS	1015TURE REMOVAL LBS/HR		TOTA MBI		LE (LE		NO. OF CIRCUITS	TOTAL HEAT REJECT, MBH	(MBH)	(MBH)	EXH. CFM	O.A. CPM	HEAT RECOVERY	PUMP HP	FLUID GPM	TYPE	CAPACITY MBH	WATER P.D. PSIG	FLUID GPM	VOLT <del>-PH-H</del> Z	MCA	MAX FUSE	(LBS)	REMARKS
RTV-4	"SERESCO" #NE-D20-VB-X -P6FBI602G3E4AD4	8000	1.0"	2 0 35	BOO ECM	2310	0.15	2.4	ЕСМ	6490	0.75"	9.9	БСМ	2	20	127.6	132.8	270.	6 R-410A	2 x	: 75	2	336	450	360	2310	2100	54%	0.25	20	CUPRO-NICKEL CO-AXIAL	186	6.0	36	480-3-60	55.0	70	6200	ALL
RTV-10	"SERESCO" #NP-030-VB-X -P6FB5I83G2E4AD4					ı	1	1	ECM	- 1	1.1	- 5	БСМ	2	30	171,1	199.6	384.	4 R-410	В	5	2	480.5	650	520	2475	2250	55%	0.25	24	CUPRO-NICKEL CO-AXIAL	273	6.0	45	480-3-60	99	110	14,500	ALL

- REMARKS

  I. MOUNT INIT ON EXISTING ROOF CURB WITH NEW ADAPTER CURB. SEE PLANS FOR ADAPTER CURB DESCRIPTION. CONTACT RON HOUSTON AT THTBAR FOR PRICING, 650-442-0450.

  2. RECOMESTE EXISTING DUCT MOUNTED SHOKE DETECTOR AND VERIFY PROFER OPERATION, INIT SHALL SHIT DOWN UPON SHOKE DETECTION.

  3. VERIFY EXACT VOLTAGE IN THE FIELD PRIOR TO ORDERING.

  4. PROVIDE GLAS CONNECTION TO UNIT WITH RESILATOR, 658 COCK, UNION AND DIRT LES.

  5. PROVIDE GLAS CONNECTION TO UNIT WITH RESILATOR, 658 COCK, UNION AND DIRT LES.

  6. MAINTAIN MANAPACITIES SECONSCIENCE OF COMPATIBLE. HIELD PRIOR STEELD HIRDS BY ELECTRICAL CONTRACTOR.

  7. INIT SHALL BE ETIL LISTED. INIT SHALL BE BACKET COMPATIBLE.

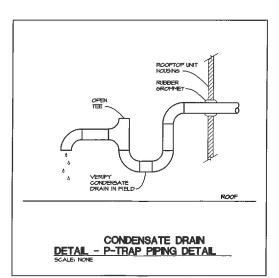
  8. MAINTAIN MANAPACITIES SECONSCIENCE OF COMPATIBLE.

  9. PROVIDE 2'STICK MERKY 5 PANEL FILL TERS FOR CUTSICE AND RETURN AND ADMISSTRATE AND ADMISSTRATE SHALL BE ETIL LISTED. INIT SHALL BE BACKET COMPATIBLE.

  10. PROVIDE 2'STICK MERKY 5 PANEL FILL TERS FOR CUTSICE AND RETURN AND ADMISSTRATE AND

## MECHANICAL GENERAL NOTES

- . HVAC CONTRACTOR SHALL PERFORM ALL CUTTING AND PATCHING OF BUILDING MATERIALS AS REQUIRED FOR INSTALLATION OF HIS WORK AND PROVIDE ALL HOLES AND SLEEVES FOR INSTALLATION OF MECHANICAL WORK.
- SEAL ALL PENETRATIONS THRU EXTERIOR WALLS WATER AND WEATHER TIGHT. ALL ROOF FLASHING SHALL BE BY THE ROOFING CONTRACTOR.
- CONTRACTOR SHALL INCLUDE ALL MISCELLANEOUS ITEMS REQUIRED TO COMPLETE THE WORK, INCLUDING MOVING AND RIGGING OF MATERIAL AND EQUIPMENT, ALL HANGER, SUPPORTS, ANCHORS, EXPANSION MEANS, FITTINGS AND SLEEVES.
- 4. CONTRACTOR SHALL BE RESPONSIBLE FOR RELOCATION OF ANY EXISTING MINOR INTERFERENCES, INCLUDING CONDUIT, HANGERS, SPRINKLER PIPING AND SPRINKLER HEADS AT NO ADDITIONAL COST.
- THE MECHANICAL CONTRACTOR SHALL SUBMIT TO THE BUILDING DEPARTMENT THE MANUFACTURER'S INSTALLATION INSTRUCTIONS FOR THE MECHANICAL EQUIPMENT.
- PROVIDE GAS PRESSURE REGULATORS AT ALL FUEL BURNING APPLIANCES, SIZE REGULATORS FOR THE MFR. REQUIRED FLOW AND INLET AND CUTLET PRESSURES.
- 7. CONTRACTOR SHALL BE RESPONSIBLE FOR VISITING THE SITE AND VERIFYING ALL EXISTING FIELD CONDITIONS PRIOR TO SUBMISSION OF HIS BID. THE CONTRACT DOCUMENTS INDICATE APPROXIMATE LOCATION OF EXISTING DILCTHORIX AND PIPING AND ARE DILAGRAPMATIC IN NATURE, THE CONTRACTOR SHALL BE RESPONSIBLE FOR DETERMINING THE ACTUAL LOCATION AND RIPING. CONTRACTOR IS RESPONSIBLE FOR COORDINATING HIS WORK WITH THE WORK OF ALL OTHER TRADES AND MAKING ANY NECESSARY MODIFICATIONS TO HIS WORK AT NO ADDITIONAL COST, INCLUDING ALL OFFSETS.
- 8. ALL SUPPLY, RETURN AND EXHAUST DUCTWORK ASSOCIATED WITH THE NATATORIUM SHALL BE ALUMINUM.
- ALL NEW POOL WATER HEAT RECOVERY PIPING SHALL BE TYPE L COPPER WITH \$\frac{3}{4}\$" "ARMAFLEX" INSULATION. PROVIDE DIELECTRIC FITTING WHEN CONNECTING TO DISSIMILAR METALS.



	MECHANICAL LEGEND
	NEW DUCTHORK AND AIR DEVICES TO MATCH EXISTING.
	EXISTING DUCTWORK AND AIR DEVICES TO REMAIN. CLEAN AND RECONDITION AS REQUIRED.
	EXISTING DUCTHORK AND AIR DEVICES TO BE REMOVED.
T	THERMOSTAT
6	SENSOR (REMOTE TEMPERATURE SENSOR UNLESS OTHERWISE NOTED)
<b>GD</b>	TAKEOFF WITH MANUAL VOLUME DAMPER
_	LOCKABLE MANUAL VOLUME DAMPER (MVD)
→ FD	FIRE DAMPER
AFF.	ABOVE FINISHED FLOOR
B.F.C.	BELOW FINISHED CEILING
M.V.D.	LOCKABLE MANUAL VOLUME DAMPER
MG.	INCHES OF WATER COLUMN
U.C.	UNDER OUT DOOR, 3/4"
U.T.R.	UP THROUGH ROOF
•	NEW TO EXISTING CONNECTION
•	DEMO BREAK POINT, DEMO BACK TO THIS POINT
RT-I	EQUIPMENT TAG
(CFM) (SIZE)	NEW AIR DEVICE TAG

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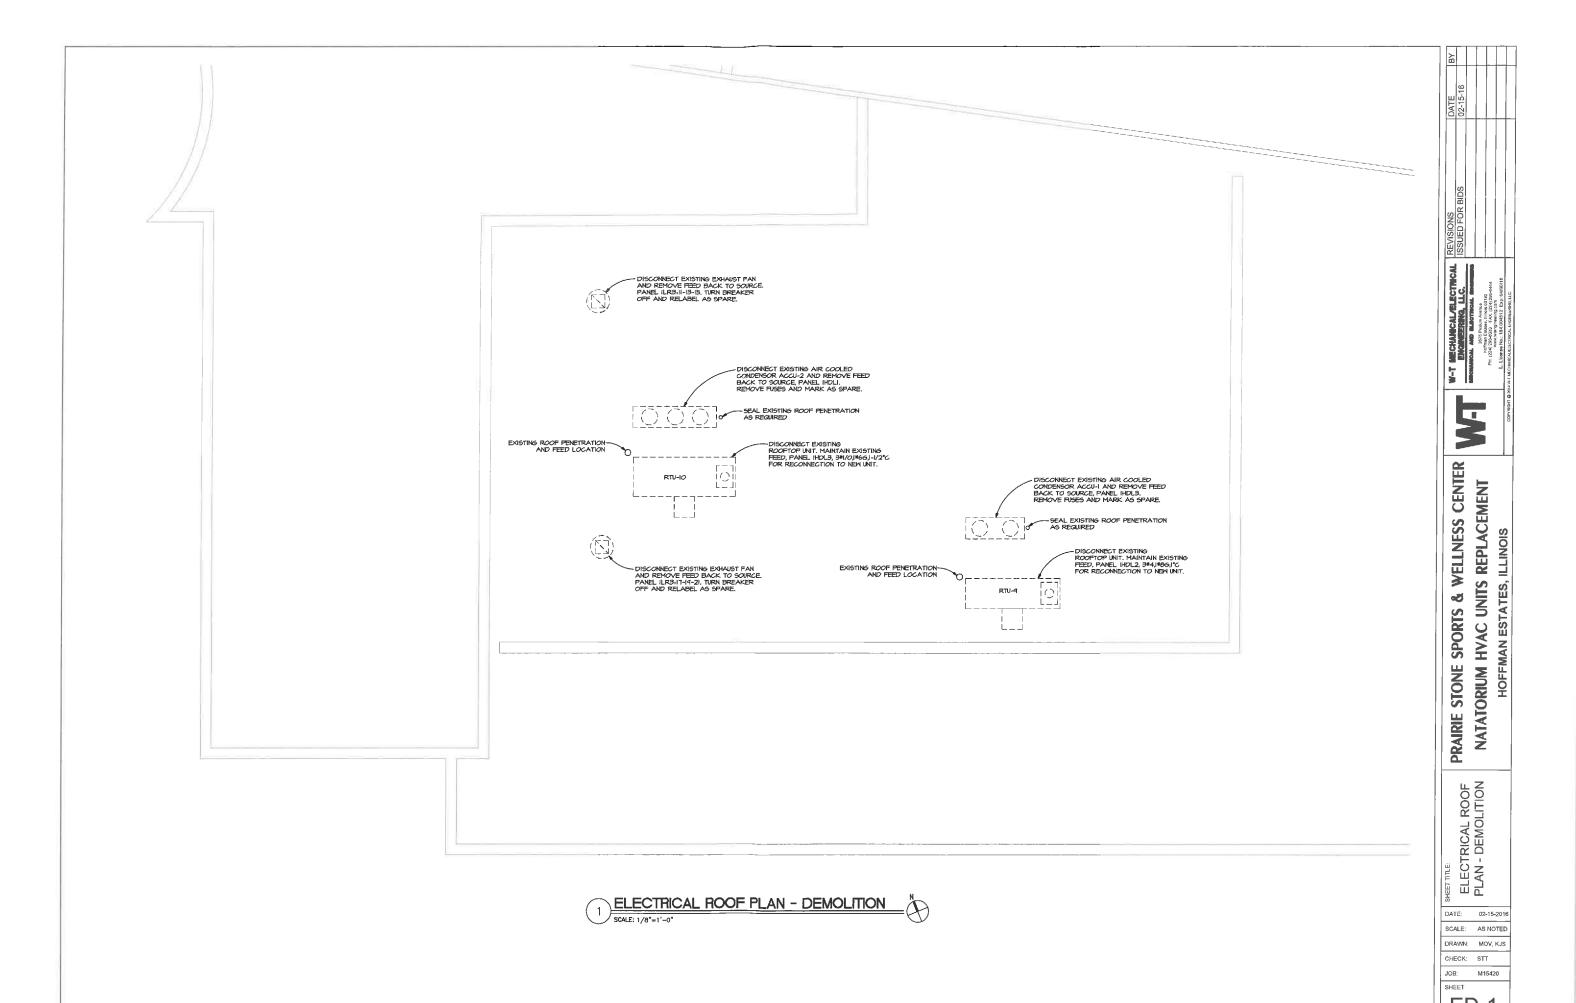
CENTER REPLACEMENT WELLNESS CNITS ಳ **SPORTS** HVAC HOFFMAN STONE NATATORIUM PRAIRIE

MECHANICAL SCHEDULE & NOTES

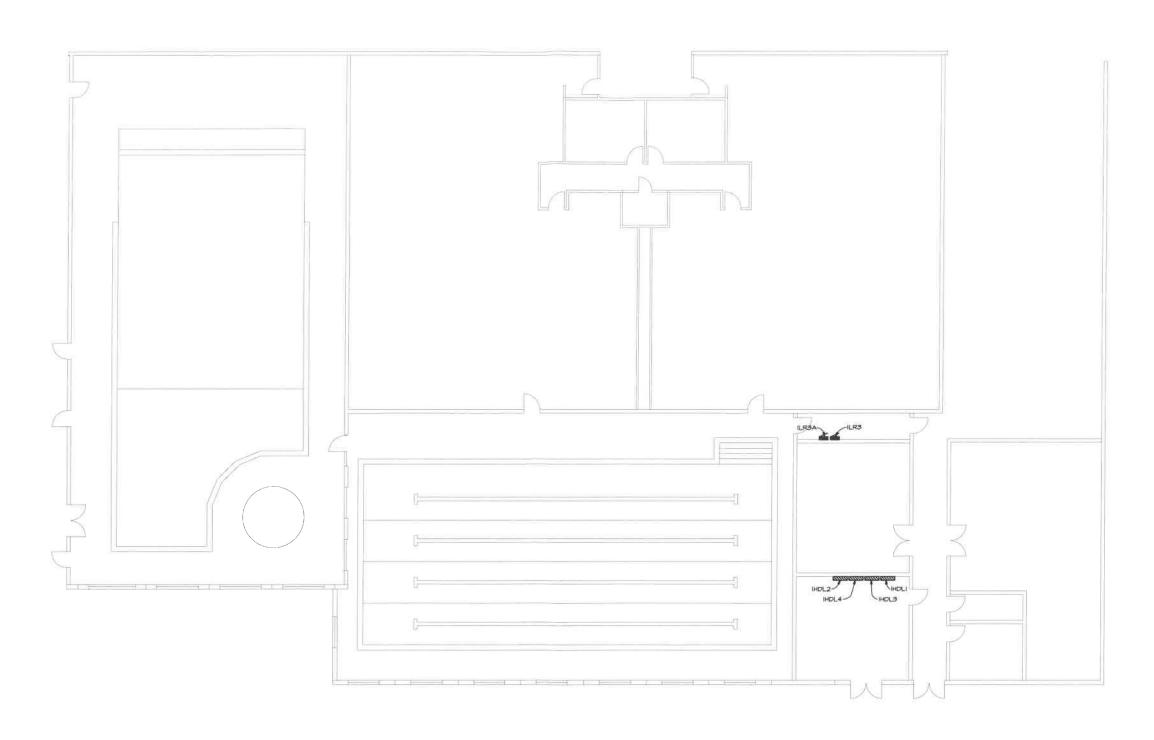
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ELECTRICAL FLOOR PLAN - NEW WORK

SCALE: 1/8"-1'-0"

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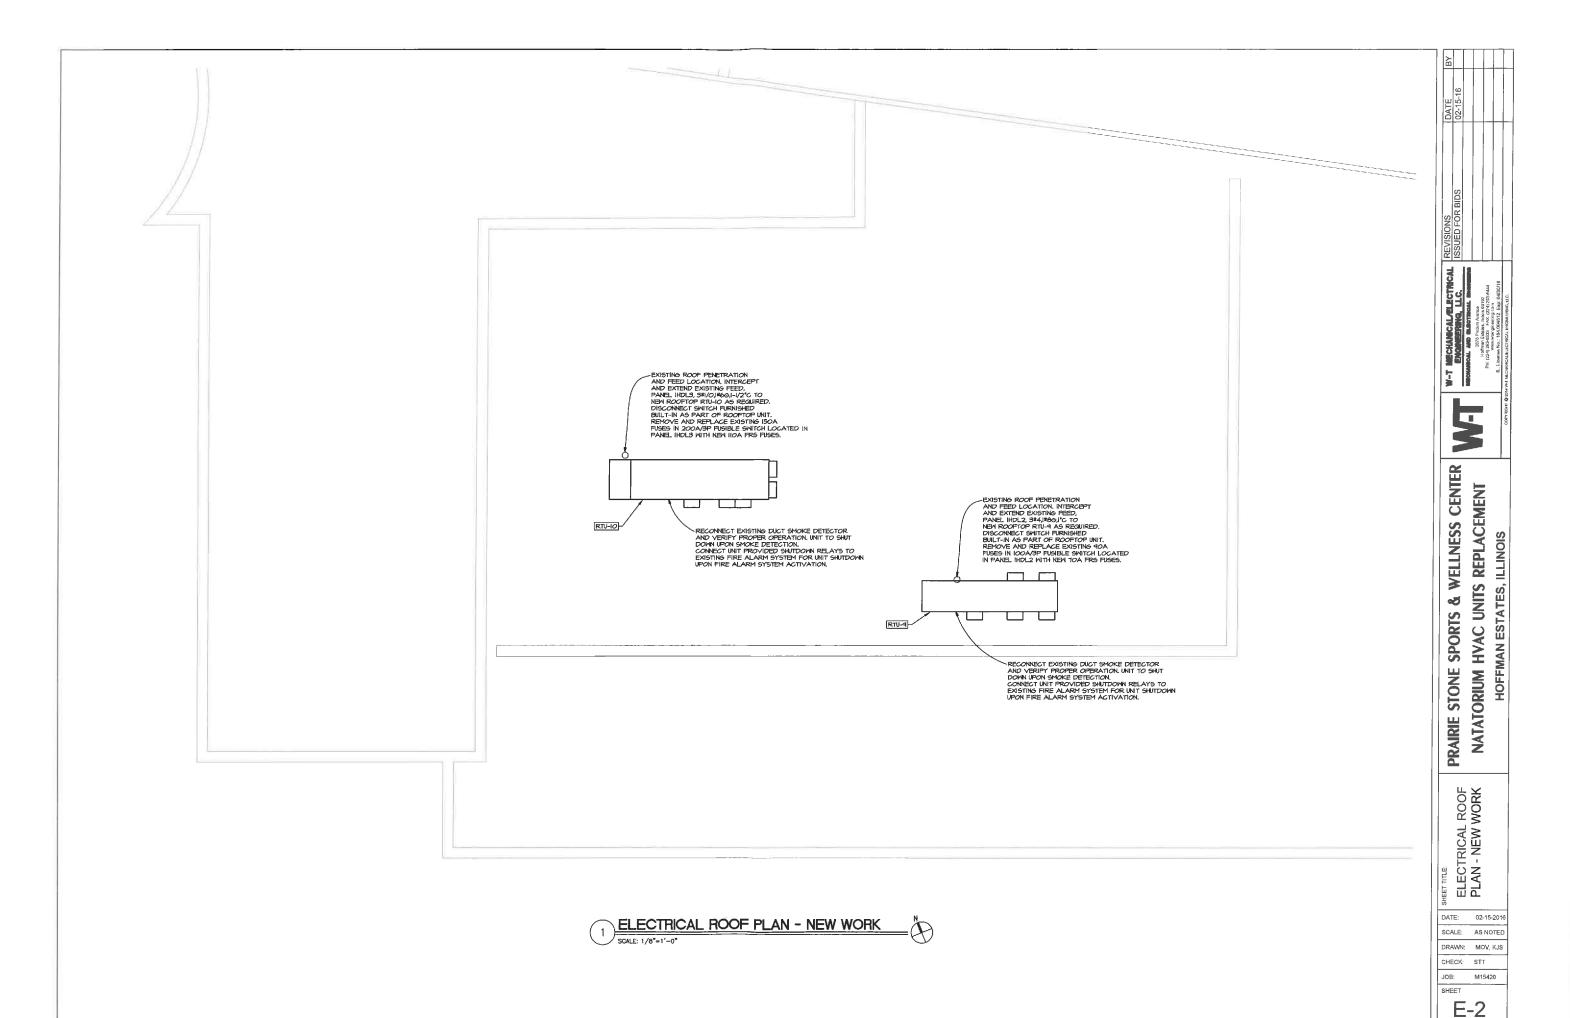
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