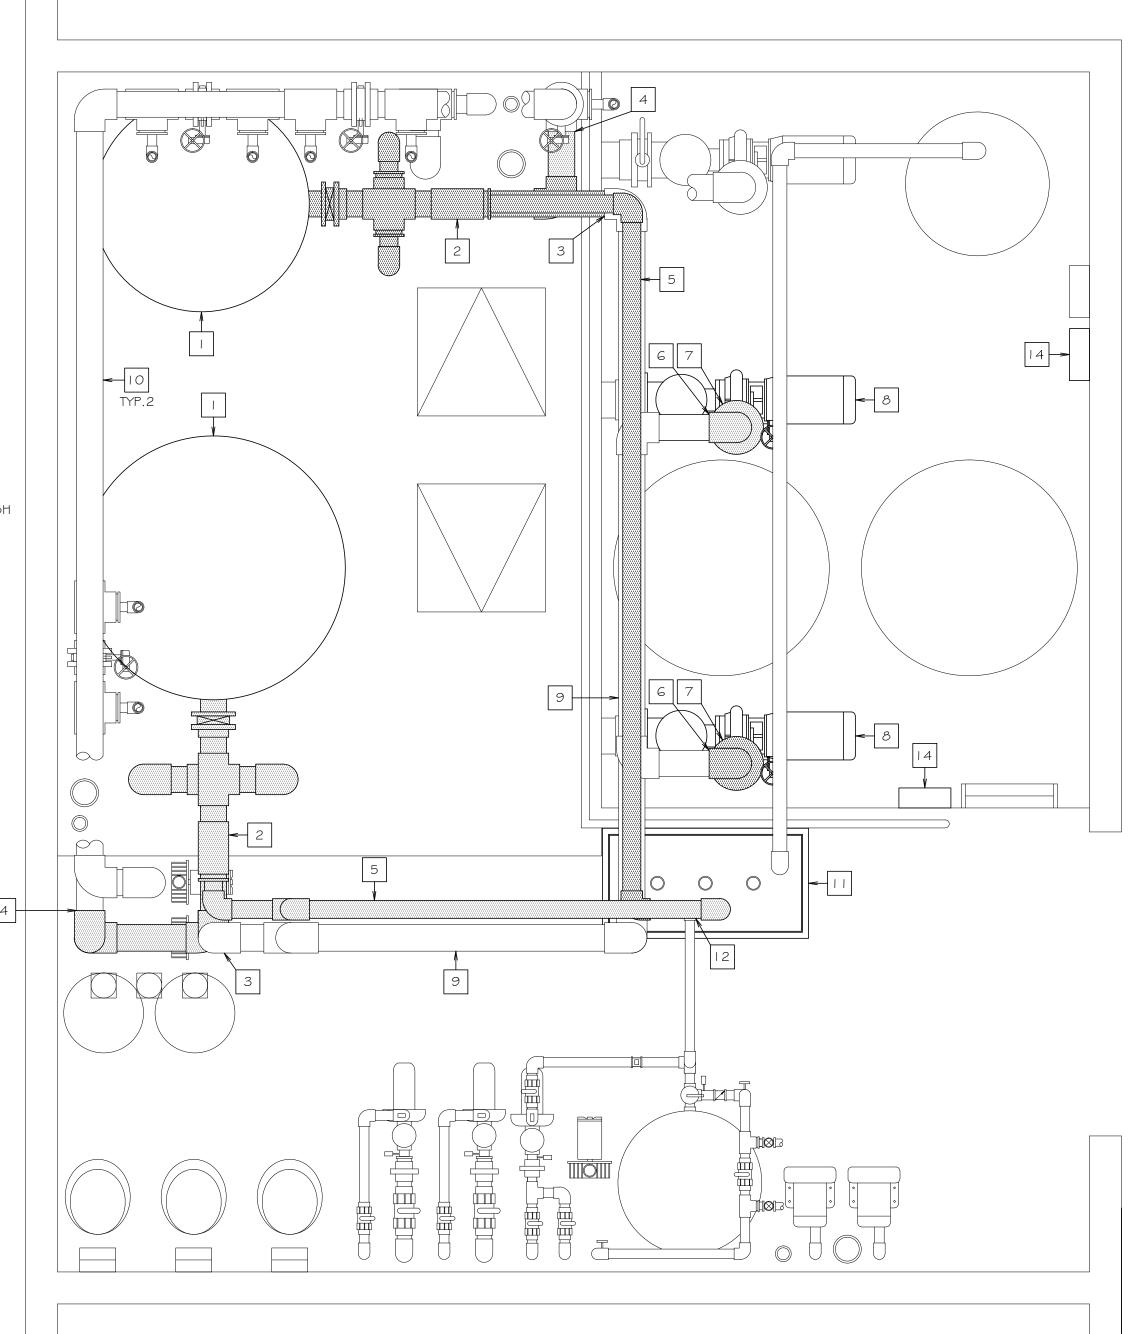
KEY NOTES:

- REMOVE AND DISPOSE OF EXISTING HI-RATE SAND FILTER
- 2 REMOVE AND DISPOSE OF EXISTING FILTER FACE PIPING
- 3 DISCONNECT EXISTING FILTER FACE PIPING FROM EXISTING 6" PUMP DISCHARGE PIPE
- DISCONNECT EXISTING FILTER FACE PIPING FROM EXISTING 6" FILTERED WATER SUPPLY PIPE
- FEMOVE AND DISPOSE OF EXISTING BACKWASH PIPE
- DISCONNECT EXISTING PUMP DISCHARGE PIPE FROM EXISTING 6" PUMP DISCHARGE PIPE
- REMOVE AND DISPOSE OF EXISTING 6" PUMP DISCHARGE PIPE
- 8 REMOVE AND DISPOSE OF EXISTING FILTRATION PUMP AND MOTOR
- 9 EXISTING FILTRATION PUMP DISCHARGE PIPE TO REMAIN
- EXISTING FILTERED WATER SUPPLY PIPE TO REMAIN
- REMOVE AND DISPOSE OF EXISTING STAINLESS STEEL BACKWASH PIT EXTENSION COLLAR, CONCRETE BACKWASH PIT TO REMAIN
- EXISTING HYDROTHERAPY POOL BACKWASH PIPE TO REMAIN
- REMOVE AND DISPOSE OF EXISTING PUMP MOTOR STARTER AND DISCONNECT

NOTES:

- I. ALL EXISTING HEATER AND DEHUMIDIFIER INFLUENT AND EFFLUENT PIPES TO REMAIN
- ALL EXISTING FLOW METERS AND THERMOMETERS TO REMAIN
- ALL EXISTING CHEMICAL SYSTEMS TO REMAIN
- 4. ALL EXISITNG WATER LEVEL CONTROLLER SYSTEMS TO REMAIN



EXISTING FILTER EQUIPMENT LAYOUT

SCALE: 1/2" = 1'-0"

INNOVATIVE
AQUATIC DESIGN, LLC

PARK DISTRICT
2352 HASSELL ROAD

RECREATION CENTER FILTER RENOVATION

DATE REVISION

DESCRIPTION:
EXISTING FILTER
EQUIPMENT LAYOUT

DATE: 03.29.16

DRAWN BY: RRD

JOB NO. A16033

SP-

MY SEAL AND SIGNATURE SHALL ENCOMPASS DRAWINGS SP-1 THRU SP-4. COPYRIGHT© 2018 INNOVATIVE AQUATIC DESIGN, LLC

UTILITY REQUIREMENTS:


FILTER BACKWASH REQUIREMENTS

THERE WILL BE ONE FILTER THAT WILL DRAIN 159 GALLONS BY GRAVITY THRU A 3" PIPE TO WASTE.

THERE WILL BE ONE FILTER THAT WILL DRAIN 181 GALLONS BY GRAVITY THRU A 3" PIPE TO WASTE.

DATA	ACTIVITY POOL	
CAPACITY:	44,745 GALLONS	
FILTER FLOWRATE:	498 G.P.M.	
TURNOVER RATE:	I HOUR 30 MIN.	

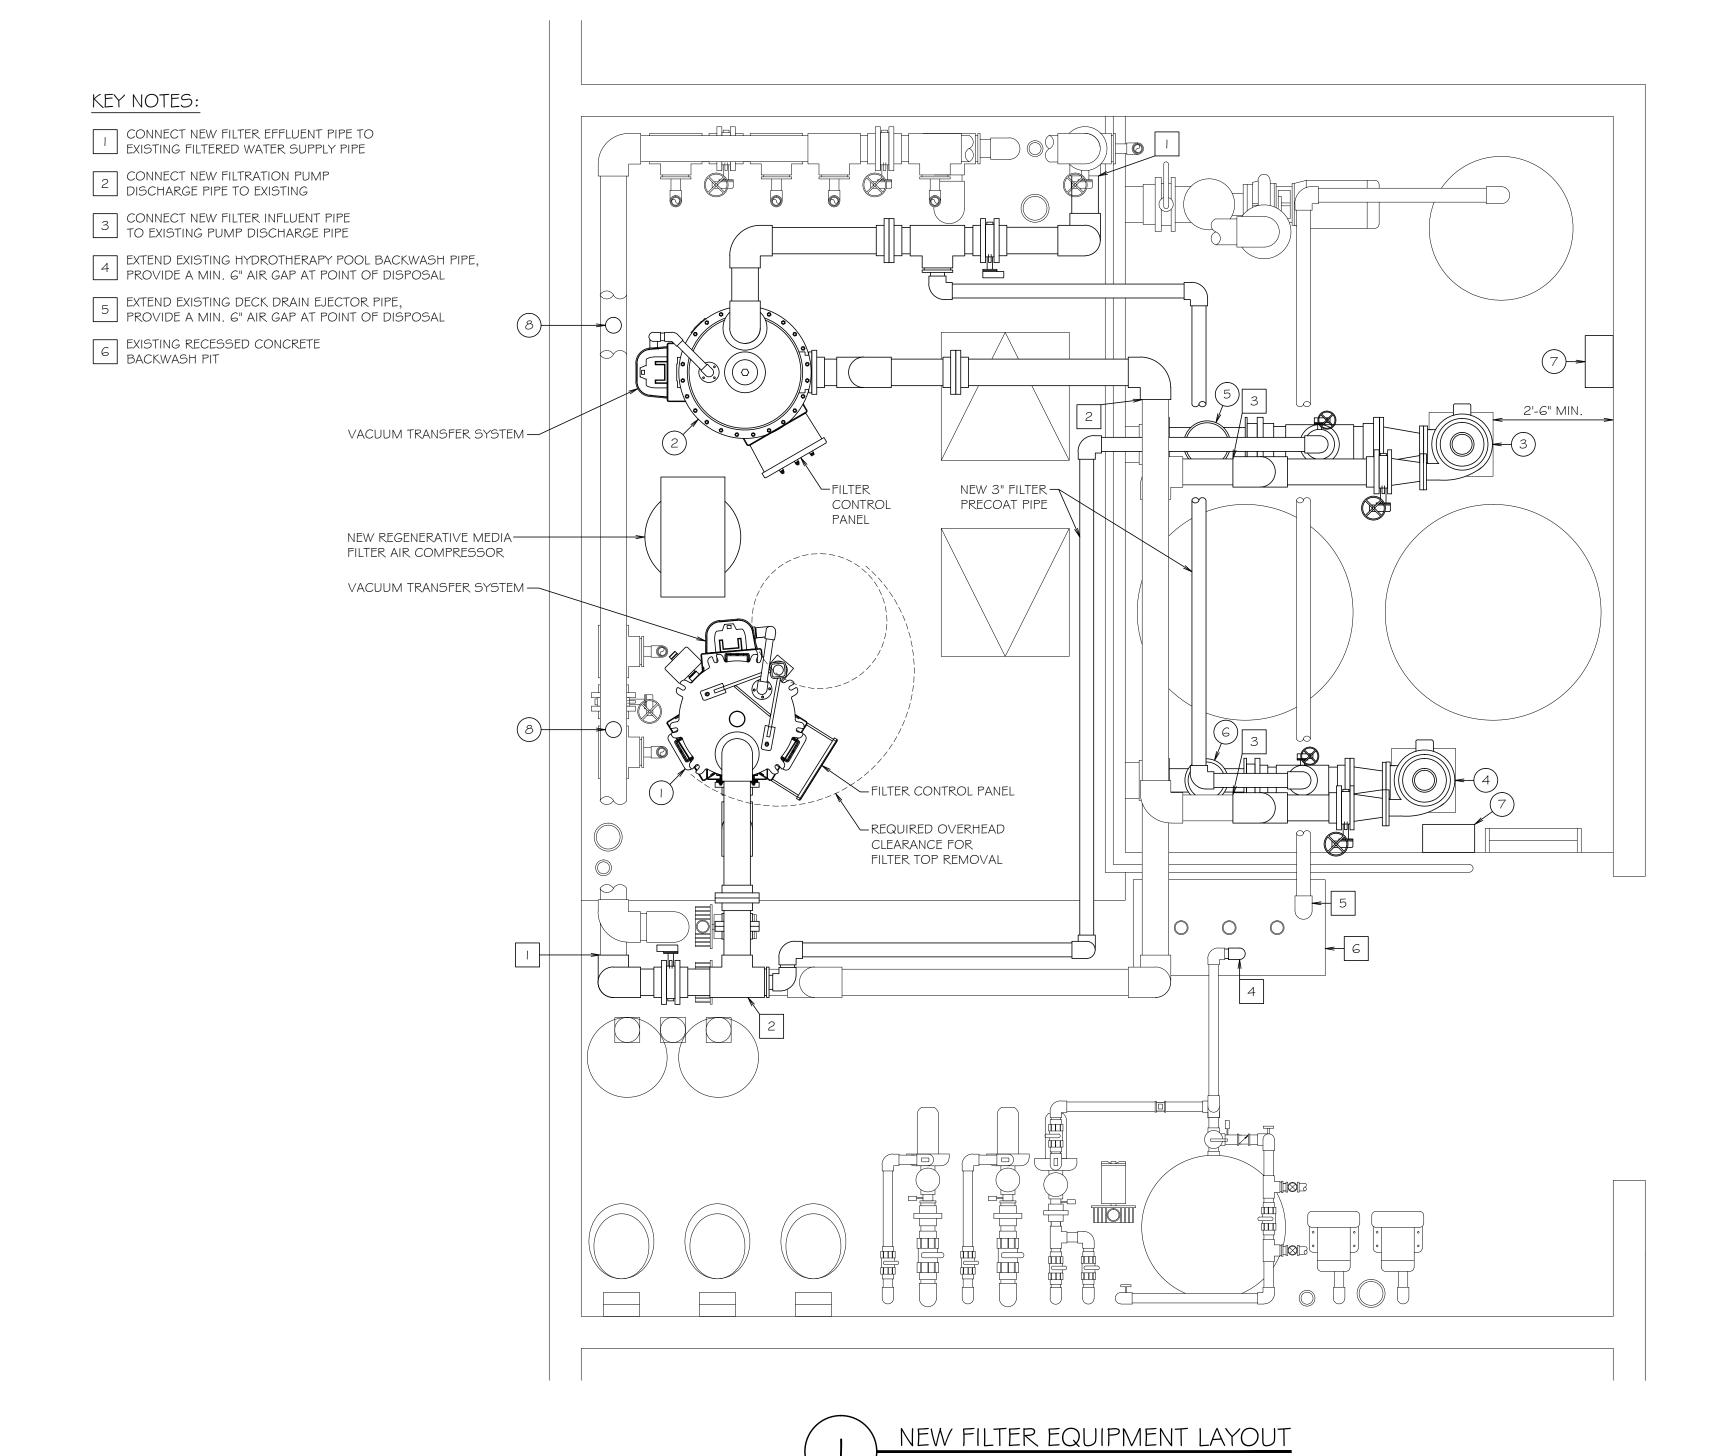LAP POOL
73,782 GALLONS
308 G.P.M.
FOUR HOURS



NEW FILTRATION EQUIPMENT LIST


THE EQUIPMENT MANUFACTURERS AND CATALOG NUMBERS LISTED BELOW, AND NOT SPECIFICALLY MENTIONED IN THE SPECIFICATIONS, ARE SHOWN TO PROVIDE A STANDARD. EQUIPMENT BY OTHER MANUFACTURERS WILL BE APPROVED IF SAID EQUIPMENT IS SHOWN TO BE EQUAL TO THAT SPECIFIED.

	MANUFACTURERS WILL DE AFFROVED IT SAID EQUIFIMENT IS SHOWN TO DE EQUAL TO THAT SFECTIED.							
ITEM	DESCRIPTION	MANUFACTURER	CATALOG NO.	QTY.				
ı	ACTIVITY POOL FILTER, REGENERATIVE "PERLITE" MEDIA, W/ 38 I SQ. FT. OF FILTER AREA, I.3 I G.P.M. / SQ. FT. OF FILTER AREA FILTRATION RATE, STEEL TANK W/ CONTROL PANEL, AIR COMPRESSOR, MEDIA VACUUM TRANSFER SYSTEM AND PNEUMATIC VALVES. "R" = REDUCED HEIGHT MODEL.	NEPTUNE BENSON	SP-27-48-487-R	l				
2	LAP POOL FILTER, REGENERATIVE "PERLITE" MEDIA, W/ 263 SQ. FT. OF FILTER AREA, I.I7 G.P.M. / SQ. FT. OF FILTER AREA FILTRATION RATE, STEEL TANK W/ CONTROL PANEL, AIR COMPRESSOR, MEDIA VACUUM TRANSFER SYSTEM AND PNEUMATIC VALVES.	NEPTUNE BENSON	5P-29-36-450	I				
3	ACTIVITY POOL FILTRATION PUMP AND MOTOR, FLOODED SUCTION, 498 G.P.M. @ 80 FT. TDH, 20 H.P., 480 VOLT, 3-PHASE, I 750 RPM, W/ EPOXY COATING ON ALL INTERIOR CAST IRON PARTS.	PACO	40957 LC	I				
4	LAP POOL FILTRATION PUMP AND MOTOR, FLOODED SUCTION, 308 G.P.M. @ 80 FT. TDH, 15 H.P., 480 VOLT, 3-PHASE, 1750 RPM, W/ EPOXY COATING ON ALL INTERIOR CAST IRON PARTS.	PACO	30957 LC	I				
5	STRAINER, FIBERGLASS, 8" W/ TWO STAINLESS STEEL BASKETS.	NEPTUNE BENSON	I 500NBFG08R I	I				
6	STRAINER, FIBERGLASS, 6" W/ TWO STAINLESS STEEL BASKETS.	NEPTUNE BENSON	I 500NBFG0GR I	I				
7	VARIABLE FREQUENCY DRIVE, 480 VOLT, 3-PHASE, 60 Hz, W/ DIGITAL READOUT, NEMA I ENCLOSURE, INTEGRAL DISCONNECT AND LINE REACTOR.	ABB	ACS550 SERIES	2				
8	FLOW SENSOR, 6", FOR FILTRATION PUMP AND MOTOR VARIABLE FREQUENCY DRIVE CONTROL.	SIGNET	3-2551-P1-42	2				
9	VACUUM / PRESSURE GAUGE, O" - 30" AND O - 60 PSI, 2 1/2" DIAL, LIQUID FILLED, WITH STAINLESS STEEL TUBE AND SOCKET, SNUBBER NO. 872-2 AND GAUGE COCK NO. 865MFG.	TRERICE	700	2				
10	PRESSURE GAUGE, O - 60 PSI, 2 1/2" DIAL, LIQUID FILLED, WITH STAINLESS STEEL TUBE AND SOCKET, SNUBBER NO. 872-2 AND GAUGE COCK NO. 865MFG.	TRERICE	700	2				

LAP POOL NOTES:


- 1.) THE EXISTING LAP POOL MAIN DRAIN MEET ASME / ANSI A | 12.19.8 2007 STANDARDS. THE EXISTING 18" X 18" MAIN DRAIN FRAME AND GRATE ARE TO REMAIN.
- 2.) THE EXISTING LAP POOL 18" X 18" MAIN DRAIN IS A BLOCKABLE SUBMERGED SUCTION OUTLET WITH AN 8" PIPE. THE 8" PIPE CONNECTS TO A SURGE TANK THAT A FILTRATION PUMP DRAWS FROM. THE NEW 15 H.P. FILTRATION PUMP IS MANUFACTURED BY PACO, MODEL #30957 LC (DESIGN FLOW RATE: 308 G.P.M. AT 80' T.D.H. - 1,750 R.P.M.).
- 3.) THE MAXIMUM FLOW CAPABILITY OF THE FILTRATION PUMP IS 570 G.P.M.
- 4.) THE MAXIMUM APPROVED FLOW RATE FOR THE EXISTING AQUASTAR #WAV1810, 18" X 18" GRATE IS 628 G.P.M.
- 5.) THE MAXIMUM FLOW CAPABILITY OF THE FILTRATION PUMP WILL NOT EXCEED THE MAXIMUM FLOW RATE OF THE NEW DRAIN COVER.

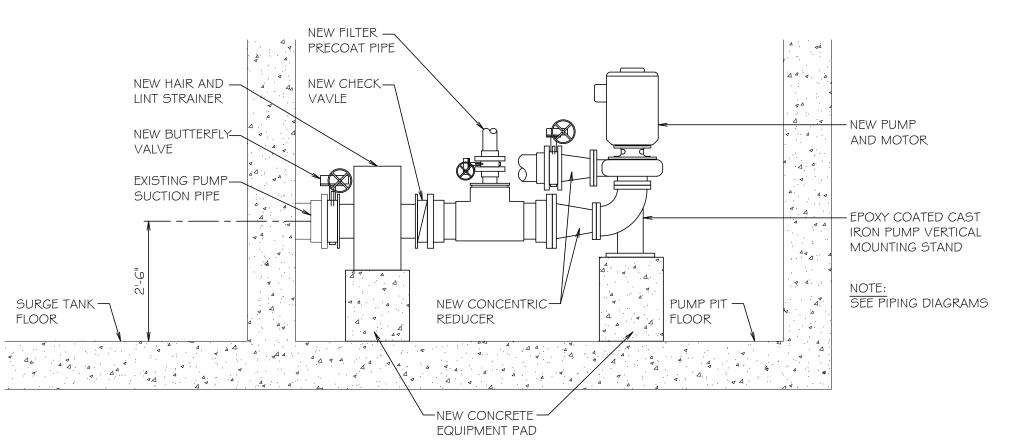- 1.) THE (2) EXISTING ACTIVITY POOL MAIN DRAINS MEET ASME / ANSI A I I 2. I 9.8 2007 STANDARDS. THE (2) EXISTING UNBLOCKABLE 30" X 30" DRAIN COVERS ARE TO REMAIN.
- 2.) THE (2) EXISTING ACTIVITY POOL 18" X 18" MAIN DRAINS ARE BLOCKABLE SUBMERGED SUCTION OUTLETS, EACH WITH AN 8" PIPE. THE 8" PIPES COMBINE TO A 12" PIPE THAT CONNECTS TO A SURGE TANK. THE FILTRATION PUMP AND PLAY FEATURE PUMP DRAW FROM THE SURGE TANK. THE NEW 20 H.P. FILTRATION PUMP IS MANUFACTURED BY PACO, MODEL #40957 LC (DESIGN FLOW RATE: 498 G.P.M. AT 80' T.D.H. - 1,750 R.P.M.). THE EXISTING 10 H.P. PLAY FEATURE PUMP IS MANUFACTURED BY PACO, MODEL #40957 LC (DESIGN FLOW RATE: 710 G.P.M. AT 40' T.D.H. - 1,750 R.P.M.).
- 3.) THE MAXIMUM FLOW CAPABILITY OF THE NEW FILTRATION PUMP IS 1,075 G.P.M.
- 4.) THE MAXIMUM FLOW CAPABILITY OF THE EXISTING PLAY FEATURE PUMP IS 940 G.P.M.
- 5.) THE TOTAL MAXIMUM FLOW CAPABILITY OF THE TWO PUMPS IS 2,015 G.P.M.
- 6.) THE MAXIMUM APPROVED FLOW RATE FOR THE EACH OF THE EXISTING NEPTUNE-BENSON #3030AEC, 30" X 30" DRAIN COVER IS 1,504 G.P.M. THE TOTAL MAXIMUM APPROVED FLOW RATE FOR (2) DRAIN COVERS IS 3,008 G.P.M.
- 7.) THE TOTAL MAXIMUM FLOW CAPABILITY OF THE TWO PUMPS WILL NOT EXCEED THE MAXIMUM FLOW RATE OF THE NEW DRAIN COVERS.





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DATE REVISION

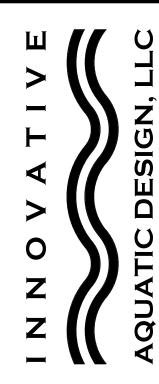DESCRIPTION: NEW FILTER EQUIPMENT LAYOUT, EQUIPMENT LIST, DATA AND DETAIL

03.29.16 **DRAWN BY:** JOB NO. A16033

SIGHT

NEW 8" FILTRATION PUMP SUCTION PIPE

SIGHT → GLASS

> -CONCRETE PAD (TYP.)

_#	DATE	REVISION

DESCRIPTION: NEW PIPING DIAGRAM, VALVE LEGEND AND NOTES

DATE:	03.29.
DRAWN BY:	R
JOB NO.	A160

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CONNECT TO 1 EXISTING

NEW 6" FILTRATION PUMP SUCTION PIPE

→ 3" FILTER DRAIN PIPE TO WASTE W/ A 6" FREE FALL AT POINT OF DISPOSAL

3/4" VENT PIPE TO WASTE— WITH A 6" AIR GAP AT POINT OF DISPOSAL


CONNECT TO EXISTING

DESCRIPTION:


NEW FILTER EQUIPMENT ELECTRICAL PLAN AND **ELECTRICAL REQUIREMENTS**

03.29.16 DATE: DRAWN BY: JOB NO. A16033

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* NOTE: VARIABLE FREQUENCY DRIVE TO BE PROVIDED BY PUMP AND MOTOR SUPPLIER - FIELD VERIFY VOLTAGE BEFORE ORDERING

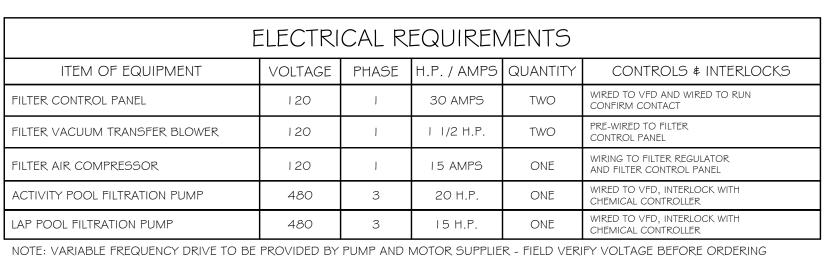

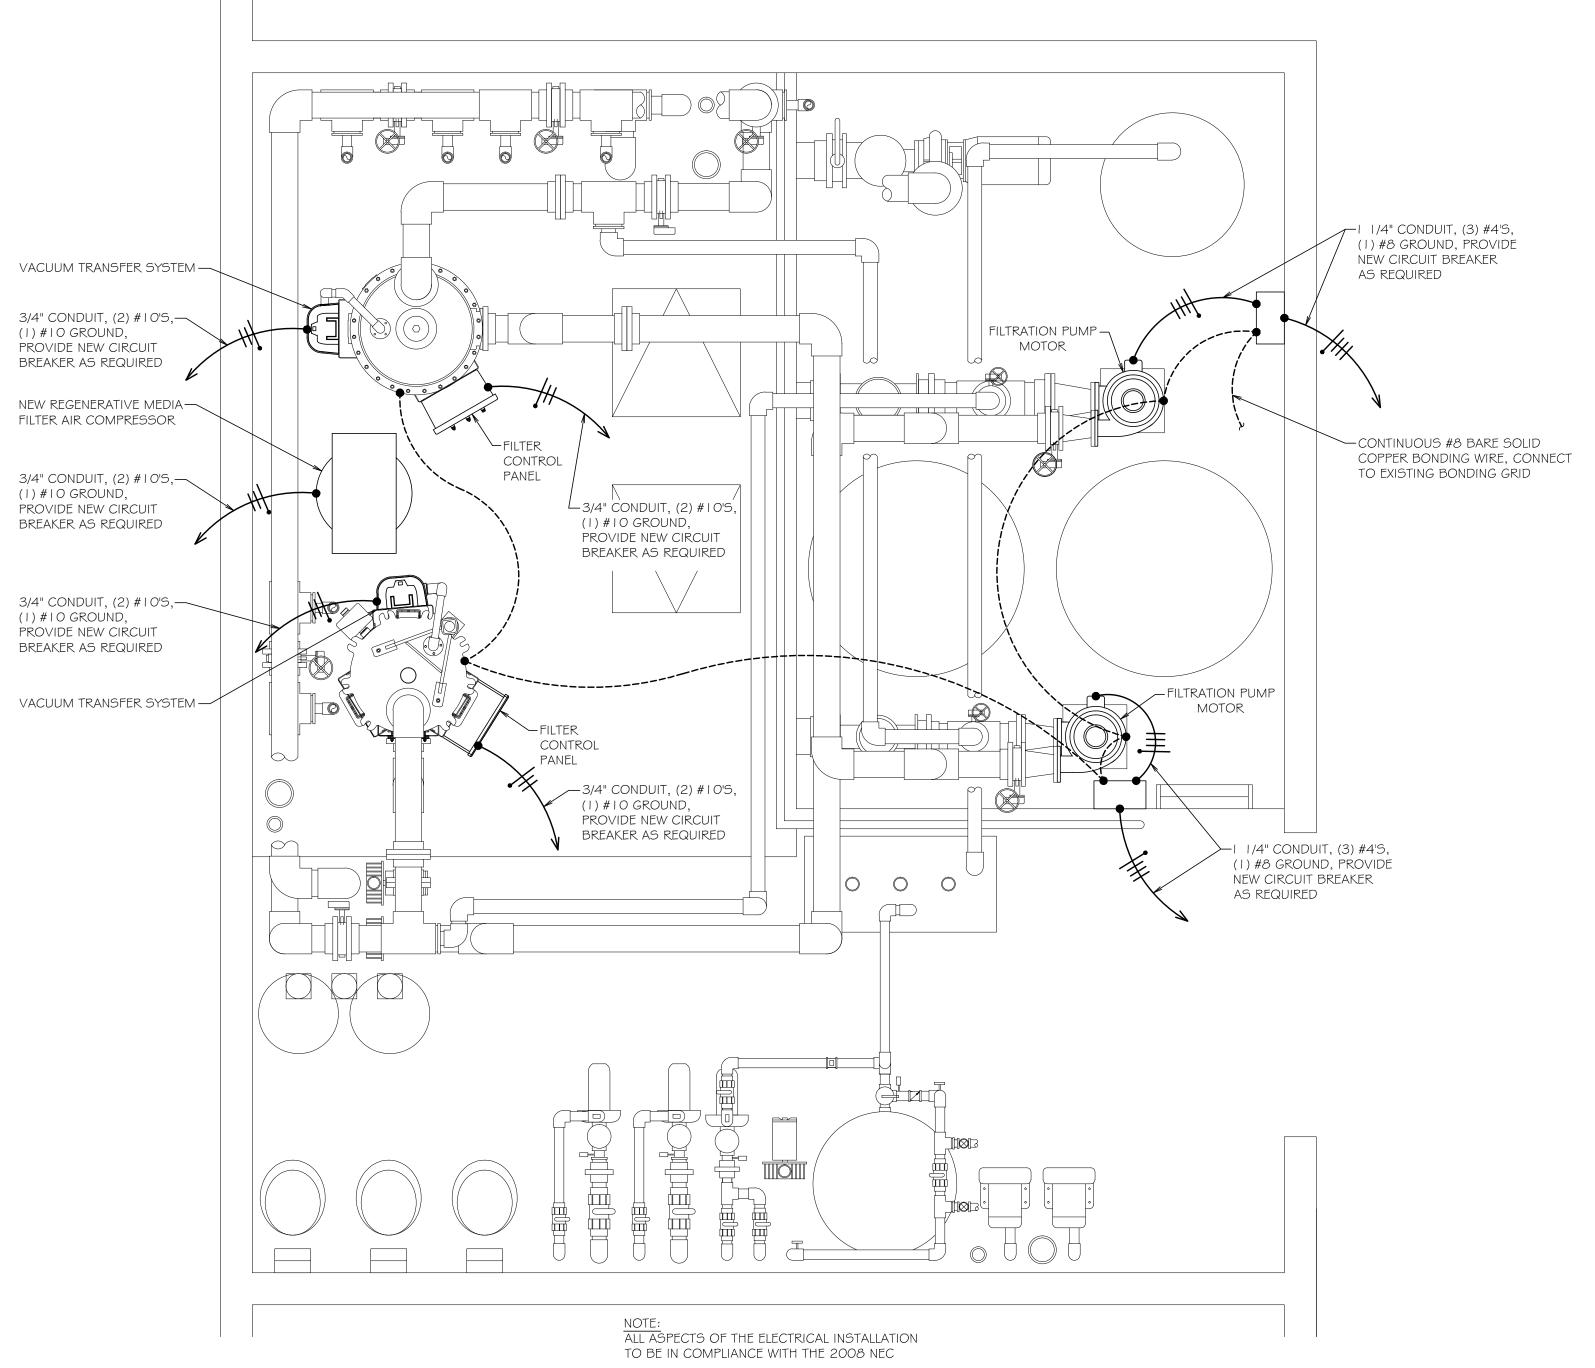NEW FILTER EQUIPMENT ELECTRICAL PLAN SCALE: 1/2" = 1'-0"